PREPARED FOR:



CITY OF SOMERVILLE, MASSACHUSETTS
JOSEPH A. CURTATONE, MAYOR
MICHAEL F. GLAVIN, EXECUTIVE DIRECTOR
MAYOR'S OFFICE OF STRATEGIC PLANNING & COMMUNITY DEVELOPMENT
ARN FRANZEN, DIRECTOR OF PARKS AND OPEN SPACE
CITY HALL
93 HIGHLAND AVENUE
SOMERVILLE, MA 02143

DRAWING INDEX

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L7.7	DECK DETAILS

HOYT SULLIVAN PLAYGROUND

SOMERVILLE, MASSACHUSETTS



16 FEBRUARY 2017 BID SET

LOCUS MAP (NOT TO SCALE)

PREPARED BY:



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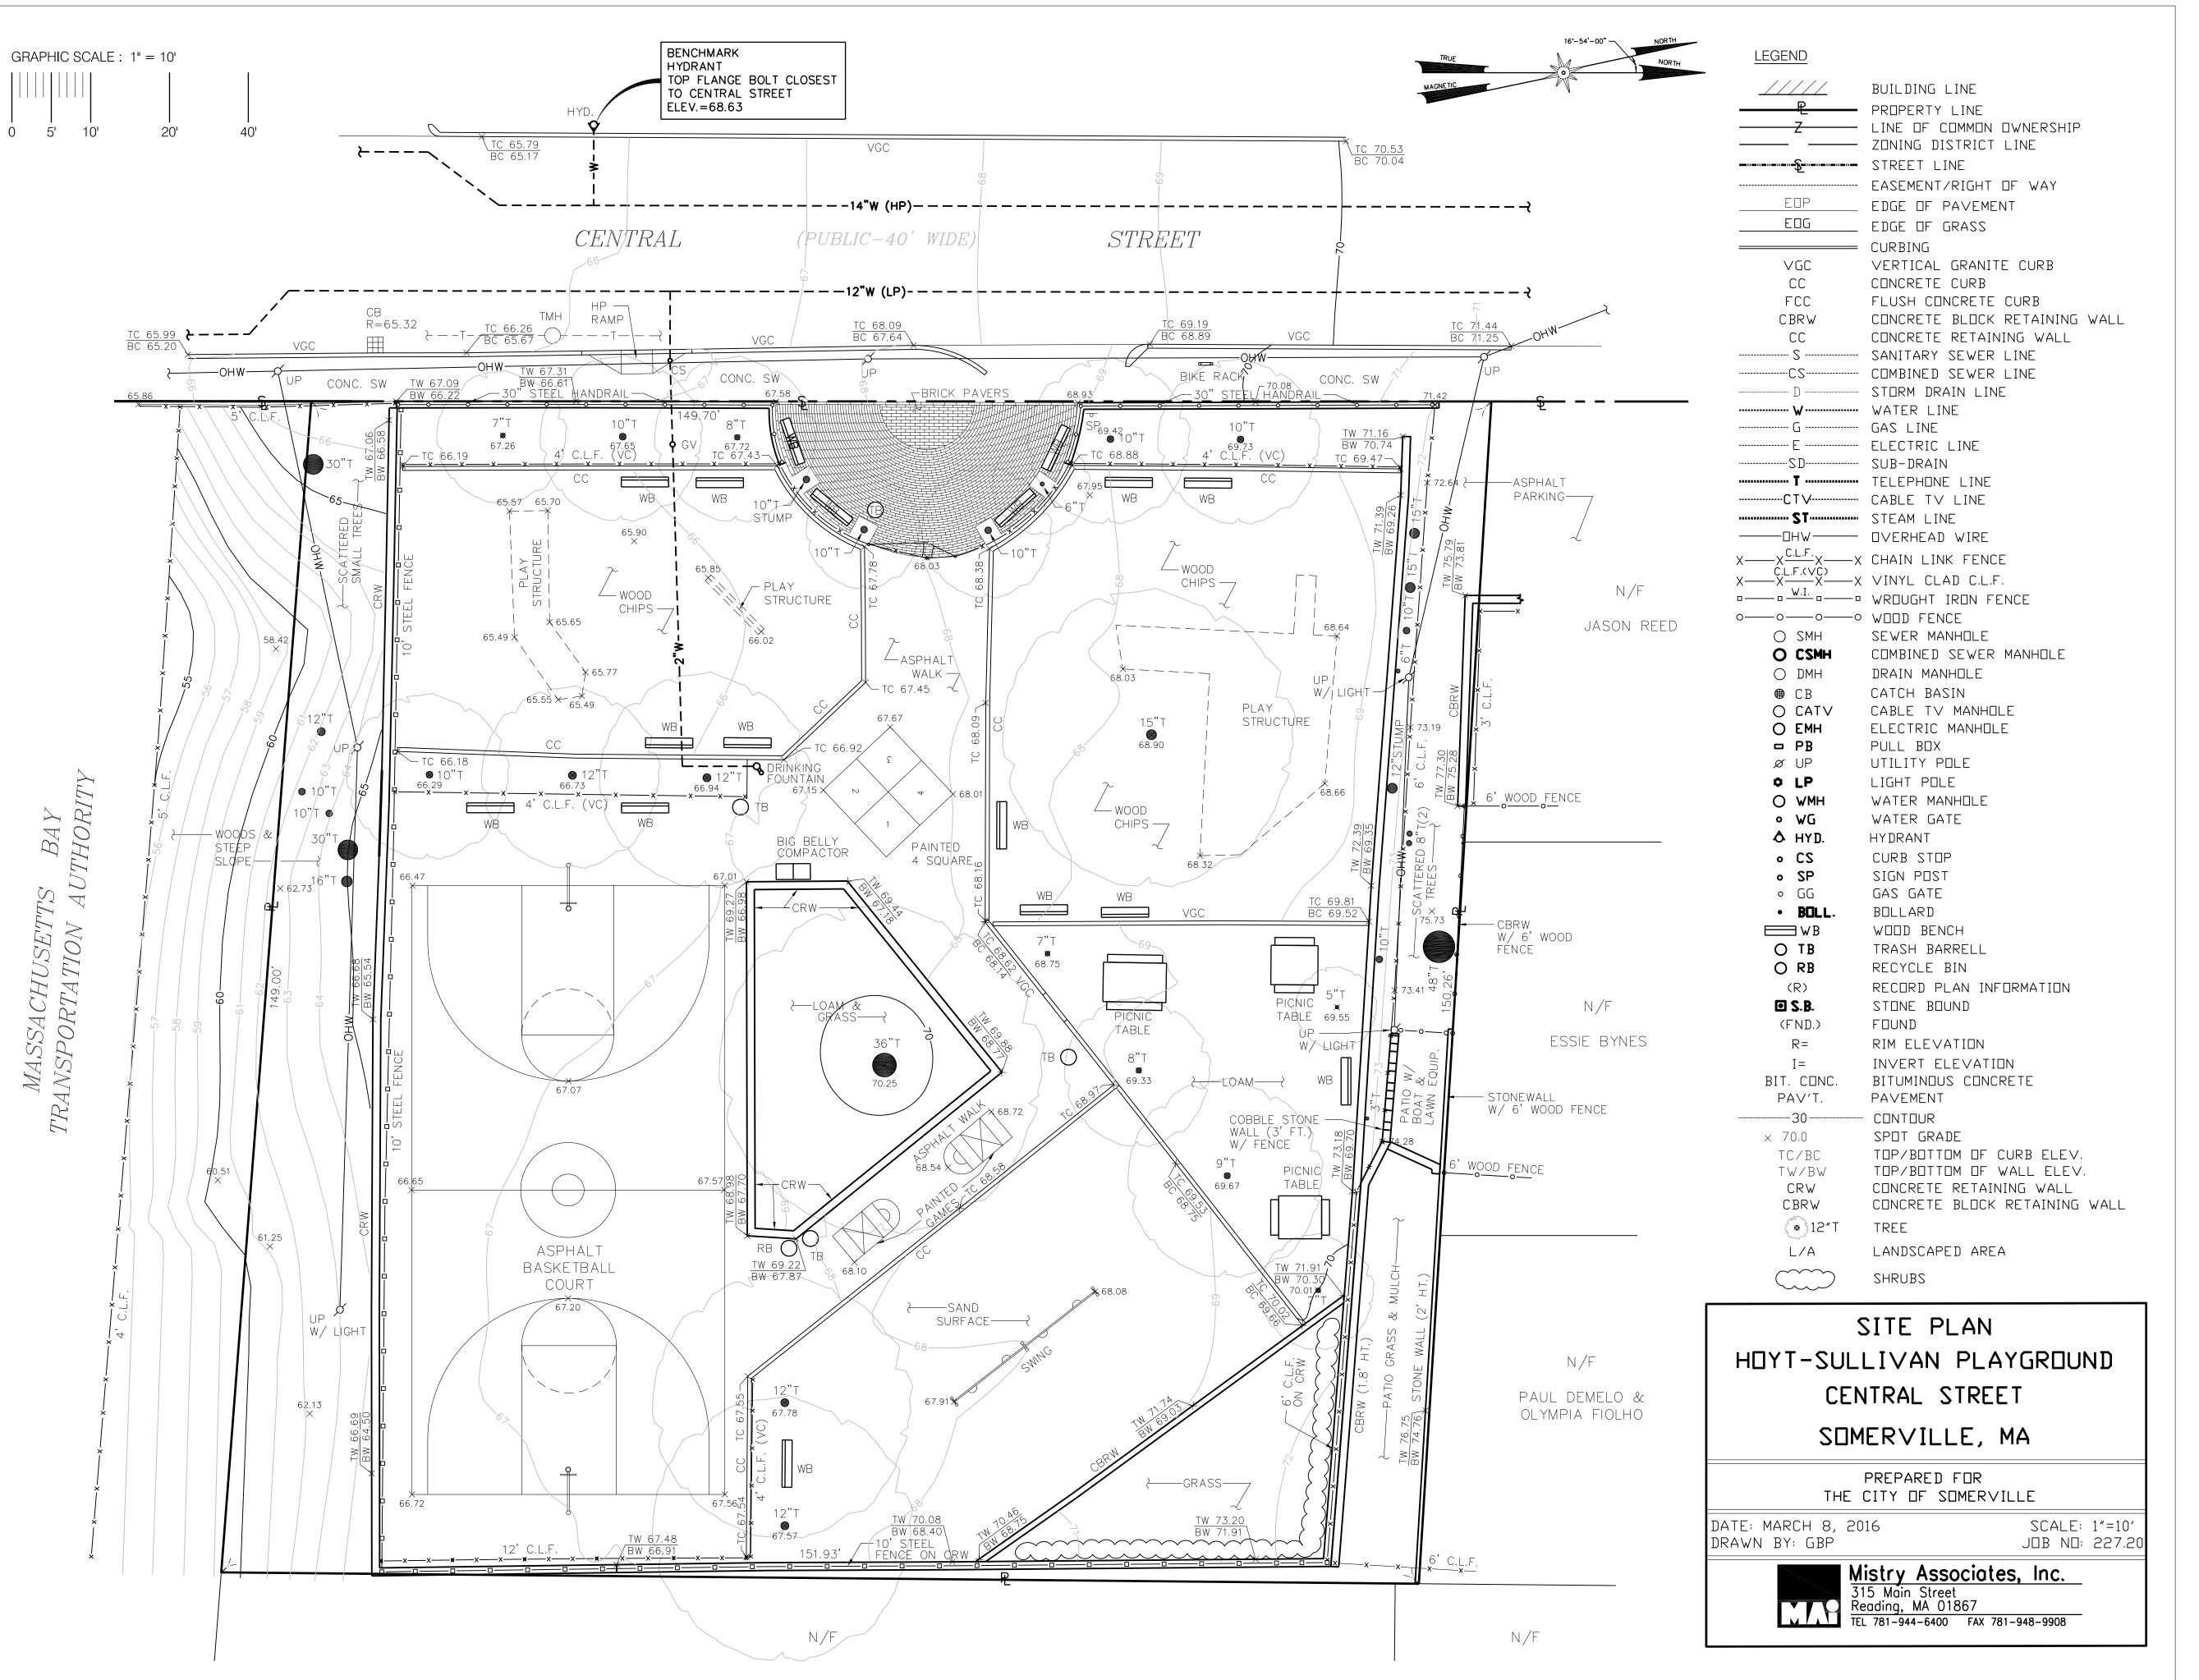
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BOSTON, MA 02116 | t: 978.663.5580

ABBREVIATIONS LIST:

<u>ABBREV</u>	IATIONS LIST:
ADJ	ADJACENT
AGG	AGGREGATE
BC	BOTTOM OF CURB
BIT	BITUMINOUS
BETW	BETWEEN
BS	BOTTOM OF STEP
BW	BOTTOM OF WALL
CLF	CHAIN LINK FENCE
CB	CATCH BASIN
CIP	CAST IN PLACE
CONC	CONCRETE
CP	CENTER POINT
DET'L	DETAIL
DIA	DIAMETER
DIM	DIMENSION
DWG EA	DRAWING EACH
EHH	ELECTRIC HAND HOLE
EQ	EQUAL
EXP	EXPANSION
EX	EXISTING
FIN	FINISH
GA	GAUGE
GALV	GALVANIZED
GRAN	GRANITE
HT	HEIGHT
JT	JOINT
LA	LANDSCAPE ARCHTIECT
LP	LIGHT POLE
MAT'L	MATERIAL
MAX	MANUOLE
MH	MANHOLE
MIN NTS	MINIMUM NOT TO SCALE
OC	ON CENTER
OD	OUTSIDE DIAMETER
PC	POINT OF CURVATURE
PCS	PIECES
POB	POINT OF BEGINNING
PSF	POUNDS PER SQUARE FOO
PSI	POUNDS PER SQUARE INCH
PT	PRESSURE TREATED
PTD	PAINTED
PVMT	PAVEMENT
REINF	REINFORCED
REQ	REQUIRED
SF	SQUARE FEET
SHT SIM	SHEET SIMILAR
SST	STAINLESS STEEL
TC	TOP OF CURB
TS	TOP OF STEP
TW	TOP OF WALL
TYP	TYPICAL
VERT	VERTICAL
VIF	VERIFY IN FIELD
WWM	WELDED WIRE MESH
\A/C	WATED CATE

CALL "DIGSAFE" AT LEAST 72 HOURS IN ADVANCE OF CONSTRUCTION AT 1-888-DIG-SAFE OR 1-888-344-7233

WATER GATE



KLOPFER MARTIN S DESIGN GROUP

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REV DATE	NOTE	

PROJECT: KMDG #1604

HOYT SULLIVAN PLAYGROUND

117 CENTRAL STREET SOMERVILLE, MA 02145

DRAWING:

REVISIONS:

EXISTING CONDITIONS PLAN

PROVIDED BY CITY OF SOMERVILLE

EVIEW:

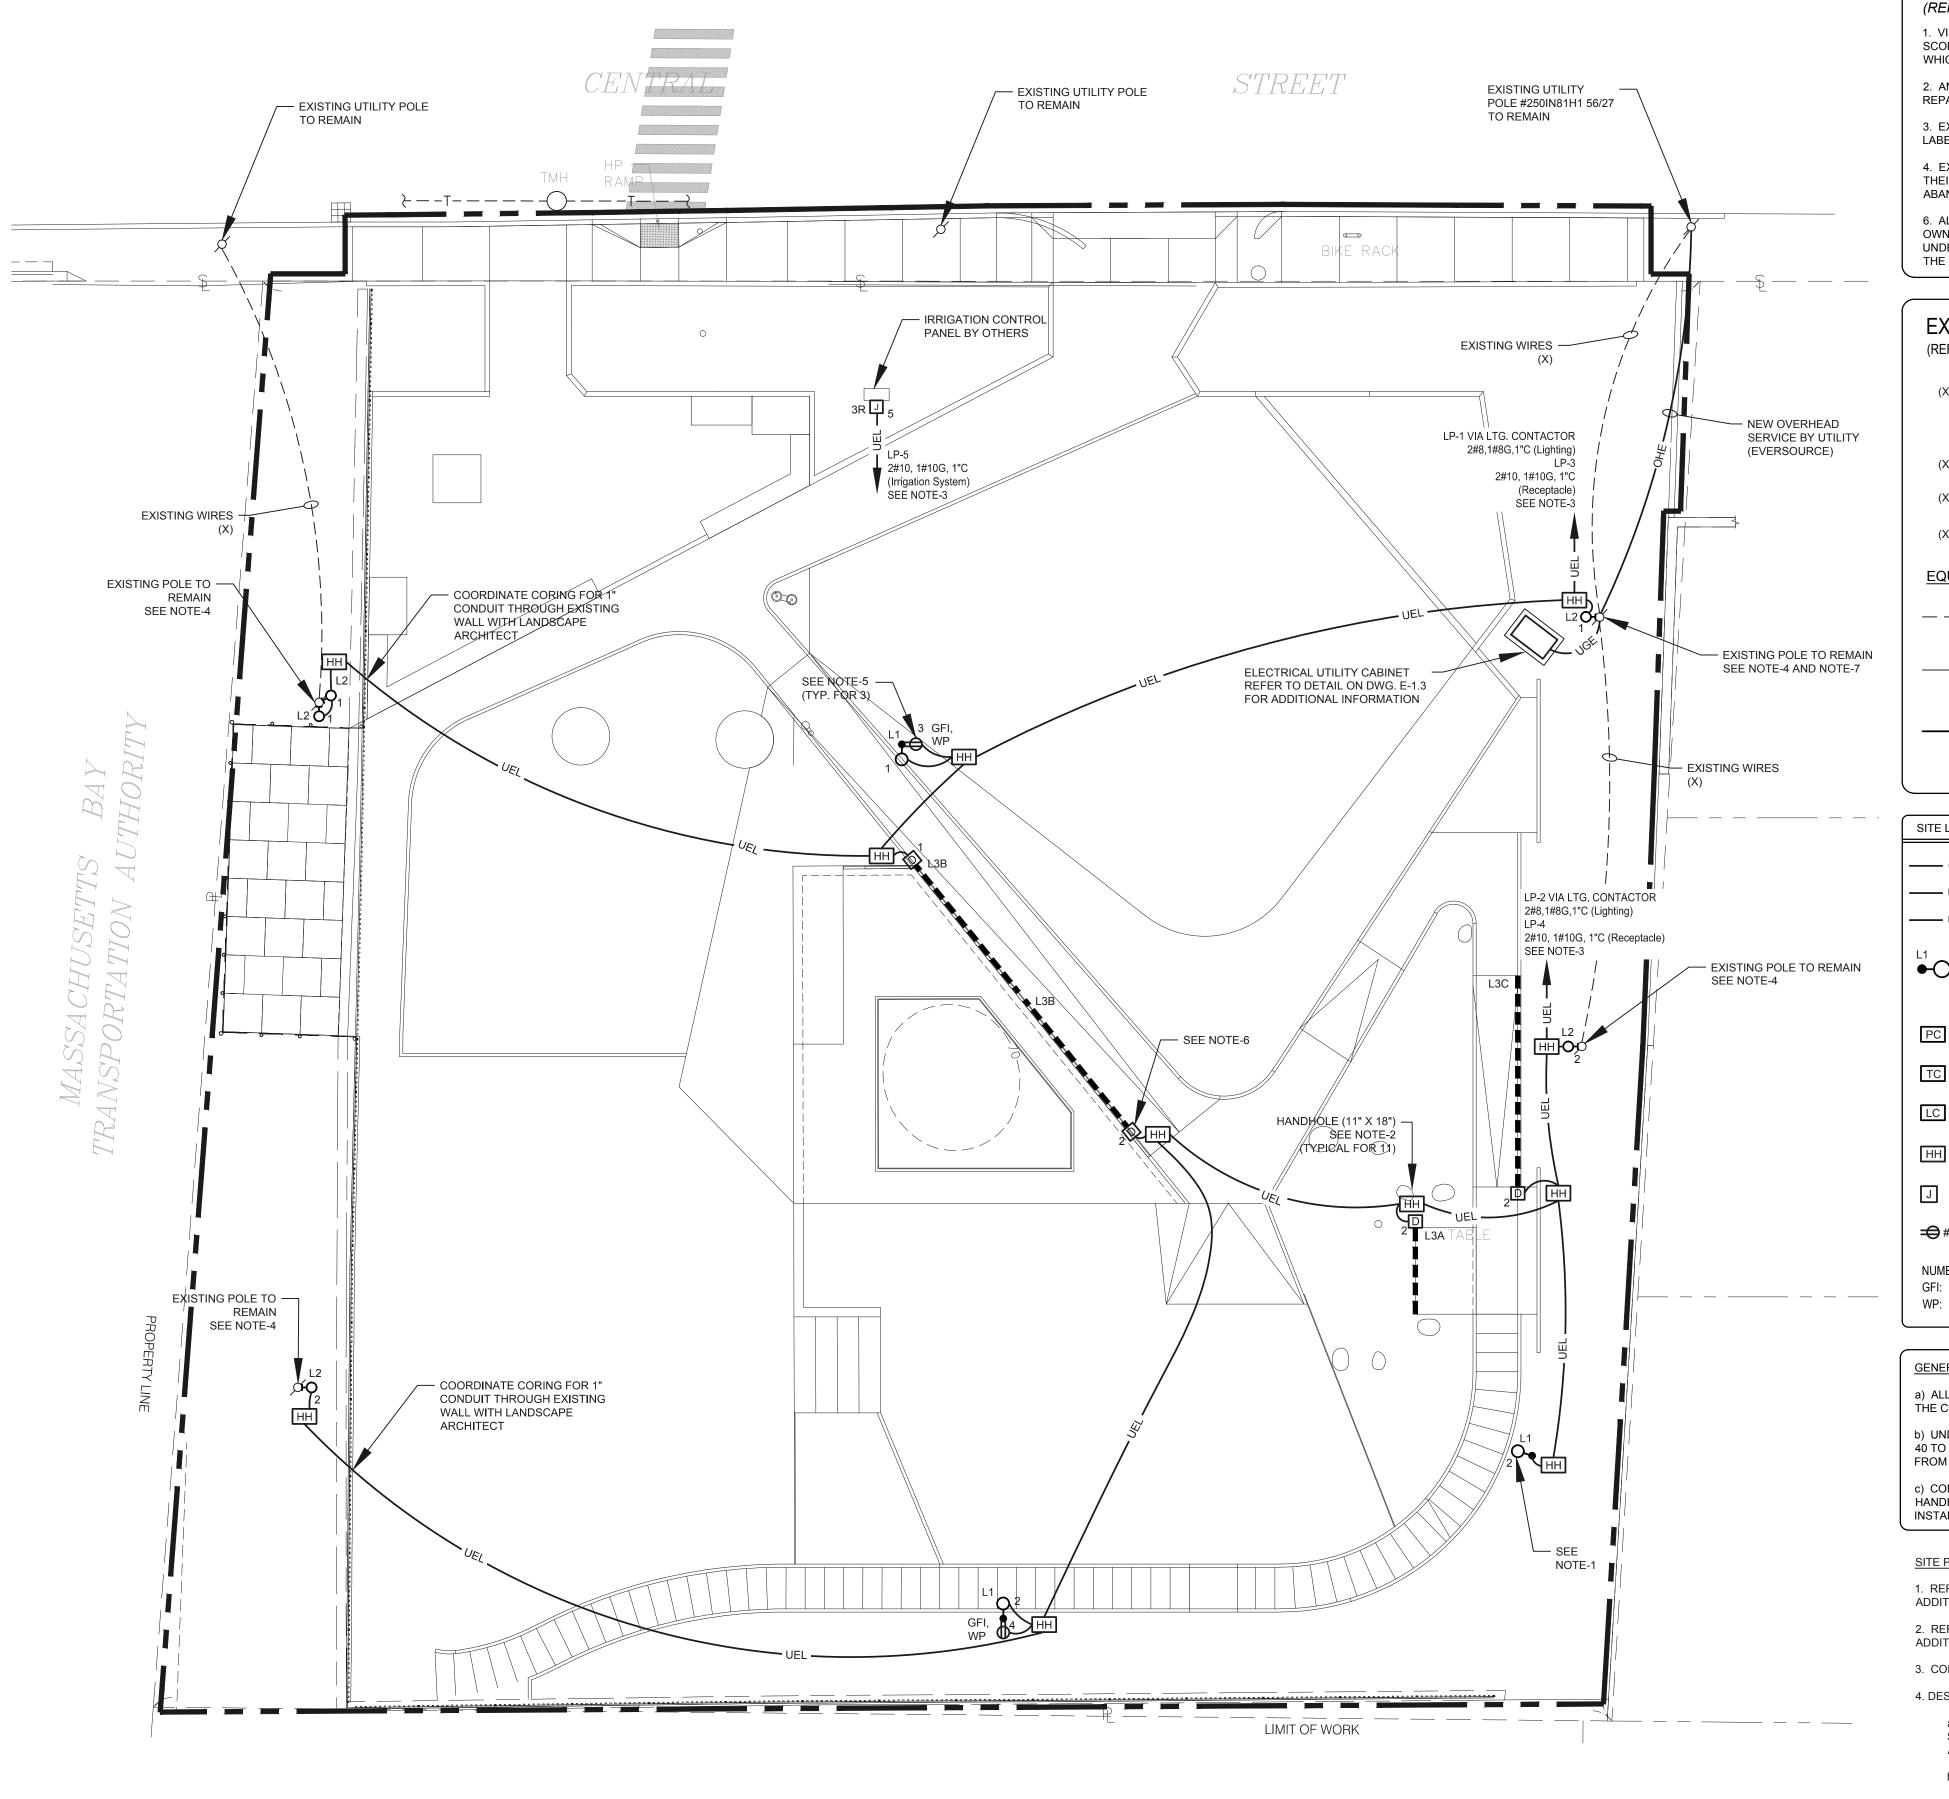
SCALE: 1" = 10'-0"

DATE:

16 FEBRUARY 2017

SHEET:

X1.1



ELECTRICAL: Site Plan

GENERAL DEMOLITION NOTES

(REFER TO ELECTRICAL SPECIFICATION 260000 FOR ADDITIONAL REQUIREMENTS)

1. VISIT THE SITE PRIOR TO SUBMISSION OF BID TO REVIEW THE AREAS AFFECTED BY THE PROJECT SCOPE. PROVIDE A WRITTEN REPORT TO THE OWNER/ ENGINEER DOCUMENTING ANY CONDITIONS WHICH MIGHT IMPACT COMPLETION OF THE INTENDED PROJECT SCOPE.

2. ANY/ ALL EQUIPMENT/ DEVICES DAMAGED DURING THE CONSTRUCTION EFFORT SHALL BE REPAIRED/ REPLACED BY THE CONTRACTOR.

3. EXISTING BRANCH AND FEEDER CIRCUITRY WITHIN THE PROJECT LIMITS SHALL BE TRACED AND LABELED PRIOR TO DISCONNECTION/ REMOVAL.

4. EXISTING RECEWAYS AND CONDUCTORS SCHEDULED FOR DEMOLITION SHALL BE REMOVED IN THEIR ENTIRETY FROM LOAD TO SOURCE. NO RACEWAYS AND/OR CONDUCTORS SHALL BE ABANDONED IN PLACE INCLUDING ANCILLARY COMPONENTS (e.g. JUNCTION BOXES, PULL BOXES).

6. ALL EXISTING EQUIPMENT/DEVICES SCHEDULED FOR DEMOLITION SHALL BE OFFERED TO THE OWNER UPON DISCONNECTION/REMOVAL. THE OWNER MAY ELECT TO RETAIN SALVAGEABLE ITEMS. UNDER THIS SCENARIO, THE CONTRACTOR SHALL TURN OVER THE IDENTIFIED ITEMS AS DIRECTED BY THE OWNER. ALL OTHER ITEMS SHALL BE LEGALLY DISPOSED OF BY THE CONTRACTOR.

EXISTING EQUIPMENT DESIGNATIONS

(REFER TO GENERAL DEMOLITION NOTES)

X) EXISTING EQUIPMENT / DEVICE SCHEDULED TO BE REMOVED - REMOVE CIRCUIT CONDUCTORS / CONDUIT BACK TO NEXT ACTIVE DEVICE,

AND/OR BACK TO SOURCE

(M) EXISTING EQUIPMENT / DEVICE SCHEDULED TO REMAIN

(R) EXISTING EQUIPMENT/DEVICE SCHEDULED TO BE RELOCATED

(XL) EXISTING EQUIPMENT/DEVICE IN NEW LOCATION (AFTER RELOCATION)

EQUIPMENT / DEVICE LINEWEIGHT KEY

DASHED LIGHT / OUT-OF-FUNCTION LINETYPE INDICATES
 EXISTING EQUIPMENT / DEVICES SCHEDULED TO BE REMOVED - (X)

CONTINUOUS LIGHT / OUT-OF-FUNCTION LINETYPE INDICATES EXISTING EQUIPMENT / DEVICES SCHEDULED TO REMAIN, AND/OR TO BE RELOCATED - (XM), (XR), (XL)

CONTINUOUS DARK / IN-FUNCTION LINETYPE INDICATES NEW EQUIPMENT / DEVICES

SITE LIGHTING PLAN LEGEND

OHE OVERHEAD ELECTRIC

UGE UNDERGROUND ELECTRIC - SECONDARY

UEL UNDERGROUND ELECTRIC - LIGHTING

LIGHTPOLE WITH ONE (1) LUMINAIRE

UPPERCASE TEXT: INDICATES LIGHTING FIXTURE TYPE

NUMERAL: INDICATES BRANCH CIRCUIT NUMBER

PHOTOCELL

TIME CLOCK

LC LIGHTING CONTACTOR

ELECTRICAL HANDHOLE

J JUNCTION BOX

DUPLEX RECEPTACLE - GROUNDING TYPE (NEMA 5-20R)

NUMERAL: INDICATES BRANCH CIRCUIT NUMBER

GFI: INDICATES GROUND FAULT CIRCUIT INTERRUPTER TYPE

WP: WEATHERPROOF

GENERAL SITE PLAN NOTES:

a) ALL TRENCHING, EXCAVATING AND BACKFILL SHALL BE PROVIDED BY THE CONTRACTOR.

b) UNDERGROUND CONDUITS SHALL TRANSITION FROM PVC SCHEDULE 40 TO RGS UPON EXIT / ENTRY FROM FINISHED GRADE. TRANSITION FROM PVC TO RGS SHALL BE MADE UNDERGROUND.

c) CONTRACTOR SHALL STAKE THE LOCATION OF THE FIXTURES AND HANDHOLES FOR APPROVAL FROM LANDSCAPE ARCHITECT PRIOR TO INSTALLATION.

SITE PLAN NOTES:

1. REFER TO SITE LIGHTING POLE BASE DETAIL ON DWG. E-1.3 FOR ADDITIONAL INFORMATION.

2. REFER TO PREFABRICATED HANDHOLE DETAIL ON DRAWING E-1.3 FOR ADDITIONAL INFORMATION.

3. CONDUCTORS SIZED TO ACCOMMODATE FOR VOLTAGE DROP.

4. DESIGN INTENT:

SCHEDULED TO BE REMOVED. NO WIRES, LIGHTS, AND/OR ACCESSORIES SHALL BE ABANDONED.

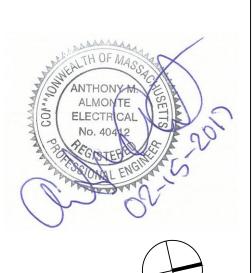
a) EXISTING SITE LIGHTING FIXTURE AND/OR EXISTING WIRES

b) NEW LIGHTING FIXTURE SHALL BE MOUNTED ON EXISTING POLE.

5. PROVIDE TAMPER RESISTANT / GFCI RECEPTACLE HUBBELL HBL GFR5362SGW OR APPROVE EQUAL IN WEATHERPROOF LOW PROFILE METAL COVER AS MANUFACTURED BY HUBBELL TAYMAC MX4280S OR APPROVED EQUAL MOUNTED TO THE LIGHT POLE. EXACT MOUNTING HEIGHT TO BE COORDINATED WITH THE LANDSCAPE ARCHITECT.

6. LED TAPE DRIVER/TRANSFORMER. REFER TO LIGHTING FIXTURE SCHEDULE ON DRAWING E-1.2 FOR ADDITIONAL INFORMATION.

7. DESIGN INTENT: NEW ELECTRICAL SERVICE SHALL ORIGINATE FROM THE POLE INDICATED. COORDINATE WITH EVERSOURCE THE EXTENSION OF OVERHEAD SERVICE FROM EXISTING UTILITY POLE ##250IN81H1 56/27.





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REVISIONS:

REV DATE NOTE

PROJECT: KMDG #1604

HOYT SULLIVAN PLAYGROUND

117 CENTRAL STREET SOMERVILLE, MA 02145

DRAWING:

ELECTRICAL SITE PLAN

DRAWN: REVIEW:

SCALE:

1" = 10'-0"

DATE:

16 FEBRUARY 2017

AMA

SHEET:

E1.1

SCHED	OULE OF PA	NELBO	ARDS																												
PANEL VOLTAGE	DUACE	WIRE	DUIC	MCP	MLO	AIC	TOTAL	TAL MOUNTING	1-PO	1-POLE			2-POLE BRANCH CIRCUIT BREAKERS				3-POLE BRANCH CIRCUIT BREAKERS							NOTES							
FANEL	PANEL VOLTAGE PHASE WIRE BUS MCB MLO AIC	AIC	POLES	MOUNTING	15A	20A 30A	40A	50A	15A 20A	25A	30A 40A	50A 6	60A	15A 20A	25A 3	30A 40A	50A	60A	70A	80A 9	00A -	100A 125A	150A	175A	200A	NOTES					
LP	120/240V	1	3	100A	100A		22K	10	SURFACE		10																				NOTE-11

GENERAL NOTES (applicable to all panelboards):

a) PROVIDE MECHANICAL TERMINAL LUGS TO ACCOMMODATE FEEDER CIRCUITRY AS LISTED ON THE ONE-LINE POWER DIAGRAM FOR ALL TERMINATIONS.

b) PANELBOARDS SHALL BE FULLY RATED.

SCHEDULE OF PANELBOARDS ABBREVIATION KEY:

MCB - MAIN CIRCUIT BREAKER

MLO - MAIN LUG ONLY AIC - MINIMUM INTERRUPTING RATING OF CIRCUIT BREAKERS

GFCI - GROUND FAULT CIRCUIT INTERRUPTER
AFCI - ARC FAULT CIRCUIT INTERRUPTER

SCHEDULE OF PANELBOARDS NOTES (as specifically indicated above):

PROVIDE PANELBOARD WITH FEED-THROUGH LUGS.
 PROVIDE PANELBOARD WITH ISOLATED GROUND BUS.

3. PROVIDE PANELBOARD WITH TRANSIENT VOLTAGE SURGE SURGE

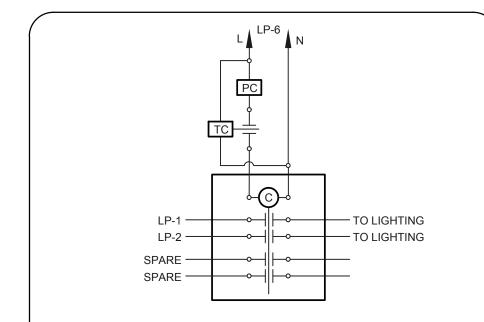
PROVIDE PANELBOARD WITH TRANSIENT VOLTAGE SURGE SUPPRESSION (TVSS).
 PROVIDE CIRCUIT BREAKER WITH SHUNT TRIP AUXILIARY ATTACHMENT.

6. BRANCH CIRCUIT BREAKER SHALL BE GFCI TYPE RATED 4-6 ma FOR PROTECTION OF PERSONNEL.
7. BRANCH CIRCUIT BREAKER SHALL BE GFCI TYPE RATED 30 ma FOR PROTECTION OF EQUIPMENT.

8. BRANCH CIRCUIT BREAKER SHALL BE AFCI TYPE.

9. PROVIDE (1) 20A-1P, 120V CIRCUIT BREAKER WITH LOCKABLE HANDLE.

10. PROVIDE NEMA 3R ENCLOSURE TYPE.
11. PANELBOARD SHALL BE UL-LISTED SE-RATED SUITABLE FOR SERVICE ENTRANCE APPLICATIONS.



DETAIL: LIGHTING CONTACTOR

SCHEDULE OF LIGHTING FIXTURES												
TYPE	MANUFACTURER	CATALOG NUMBER	DESCRIPTION		LAMP DATA	Е	BALLAST DATA	VOLTAGE	WATTS	MOUNTING	NOTES	
				NO.	TYPE	NO.	TYPE	V0217102		in out in to	110120	
L1	WE-EF LIGHTING	ASP534LED 655-3520 WITH 655-9370 (LUMINAIRE) 693-1223 (POLE)	SITE LIGHTING LED FIXTURE TYPE III MEDIUM	-	28W LED ARRAY	-		120V	28 W	12'-0" ON NEW POLE	NOTES-1 & 2	
L2		FLC141LED 655-7426 WITH JB1 JUNCTION BOX	SURFACE MOUNTED LED FIXTURE	-	55W LED ARRAY	1		120V	55 W	20'-0" ON EXISTING POLE	NOTES-1 & 2	
L3A	OPTIC ARTS LIGHTING	FLEX DC 44 WITH CHW-S-2010 MOUNTING CHANNELS GG100E-24-UNV-010V DRIVER	SURFACE MOUNTED FLEXIBLE LED TAPE FIXTURE 9'-0"	-	4.4W / FT LED TAPE	1		120V	40 W	SURFACE	NOTES-1, 2, 3	
L3B		FLEX DC 44 WITH CHW-S-2010 MOUNTING CHANNELS GG100E-24-UNV-010V DRIVER	SURFACE MOUNTED FLEXIBLE LED TAPE FIXTURE 17'-0"	-	4.4W / FT LED TAPE	-		120V	75 W	SURFACE	NOTES-1, 2, 3	
L3C	OPTIC ARTS LIGHTING	FLEX DC 44 WITH CHW-S-2010 MOUNTING CHANNELS GG100E-24-UNV-010V DRIVER	SURFACE MOUNTED FLEXIBLE LED TAPE FIXTURE 22'-0"	-	4.4W / FT LED TAPE	1		120V	96.8 W	SURFACE	NOTES-1, 2, 3	

GENERAL NOTES (for all lighting fixtures):

a) LIGHTING FIXTURES LISTED ABOVE ESTABLISH THE PROPOSED LEVEL OF QUALITY. ANY/ALL PROPOSED LIGHTING FIXTURE SUBSTITUTIONS SHALL BE AN APPROVED EQUAL.

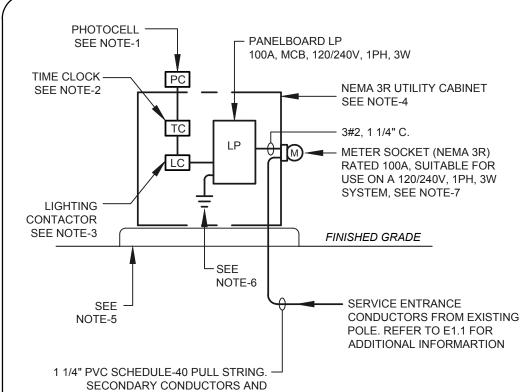
b) PROVIDE ALL ACCESSORIES AND HARDWARE TO ACCOMMODATE MOUNTING REQUIREMENTS.

SCHEDULE OF LIGHTING FIXTURE NOTES (as specifically indicated above):

1. FIXTURE AND ASSOCIATED ACCESSORIES SHALL BE UL-LISTED WET LOCATION FOR INSTALLATION IN WET/EXTERIOR ENVIRONMENTS. COORDINATE EXACT LOCATION, MOUNTING HEIGHT AND LIGHTING FIXTURE AIMING IN FIELD WITH LANDSCAPE ARCHITECT.

2. COORDINATE FINISH/COLOR WITH LANDSCAPE ARCHITECT.

3. COORDINATE EXACT LOCATION OF LED TAPE AND NEMA 3R DRIVER/TRANSFORMER ENCLOSURE IN THE FIELD WITH LANDSCAPE ARCHITECT PRIOR TO ROUGH-IN. LED TAPE LENGTH IS APPROXIMATE, ADJUST IN FIELD AS NECESSARY.



TERMINATIONS BY UTILITY COMPANY.

DETAIL NOTES:

1. 120/240V PHOTOCELL SHALL BE TORK #2100 SERIES OR APPROVED EQUAL, SUITABLE FOR EXTERIOR APPLICATIONS. PHOTOCELL SHALL BE MOUNTED ON TOP OF THE ENCLOSURE ORIENTATION SHALL BE FACING NORTH OR NORTHWEST DIRECTION.

2. 120/240V TIME CLOCK SHALL BE TORK E-SERIES 7-DAY TIME SWITCH OR APPROVED EQUAL.

3. LIGHTING CONTACTOR SHALL BE 4-POLE ELECTRICALLY HELD - SQUARE D TYPE-L, CLASS 8903 IN NEMA-1 ENCLOSURE, OR APPROVED EQUAL BY EATON CUTLER-HAMMER OR GENERAL ELECTRIC.

4. PROVIDE UL-LISTED UTILITY CABINET/ENCLOSURE SUITABLE FOR USE IN EXTERIOR / WET ENVIRONMENTS - NEMA 3R. ENCLOSURE SHALL BE ALUMINUM OR GALVANIZED STEEL 30" WIDE x 50" HIGH x 17" DEEP MINIMUM WITH LOCKABLE DOORS. ENCLOSURE SHALL BE AS MANUFACTURED BY BISON PRO FAB, OR APPROVED EQUAL. COORDINATE WITH CITY OF SOMERVILLE FOR ADDITIONAL REQUIREMENTS.

5. PROVIDE CONCRETE PAD AT UTILITY CABINET ENCLOSURE. CONCRETE SHALL BE CLASS-A, 3,000 PSI, 28-DAY. PAD SHALL EXTEND 6" MINIMUM ON ALL SIDES. PAD SHALL EXTEND 3" AFG. PROVIDE 3/4" CHAMFER AT PAD EDGE ALL AROUND.

6. PROVIDE GROUNDING AT ELECTRICAL SERVICE. PROVIDE (2) 3/4" DIAMETER x 10'-0" LONG COPPER CLAD STEEL GROUND RODS. TOP OF GROUND ROD SHALL BE DRIVEN AT LEAST 12" BELOW FINISHED GRADE. CONNECT WITH 1 #8 COPPER CONDUCTOR IN 3/4"C (PVC SCHEDULE

7. PROVIDE METER SOCKET IN ACCORDANCE WITH UTILITY COMPANY (EVERSOURCE) METERING REQUIREMENTS. METER SOCKET SHALL BE AS MANUFACTURED BY MILBANK OR APPROVED EQUAL.

DETAIL: ELECTRICAL SERVICE ENCLOSURE / UTILITY CABINET





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REVISIONS:

REV DATE NOTE

PROJECT: KMDG #1604

HOYT SULLIVAN PLAYGROUND

117 CENTRAL STREET SOMERVILLE, MA 02145

DRAWING:

ELECTRICAL SCHEDULE SHEET

DRAWN: REVIEW: EP AMA

SCALE:

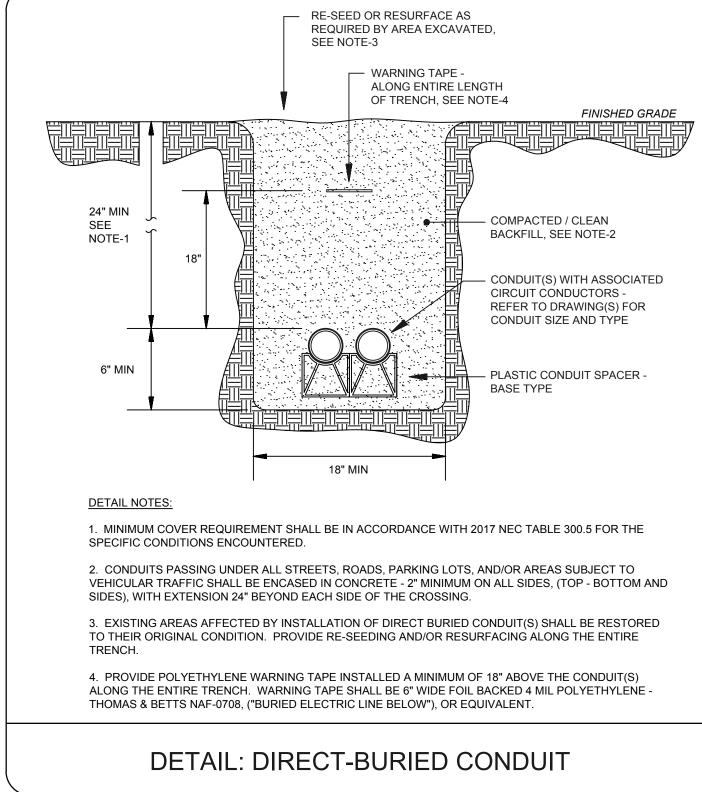
N.T.S.

DATE:

16 FEBRUARY 2017

SHEET:

E1.2



(LOAD DESCRIPTION)

(ELECTRICAL RATING)

FED FROM (SOURCE)

TYPICAL EQUIPMENT NAMEPLATE DETAIL

1. PROVIDE EQUIPMENT NAMEPLATE ON ALL SWITCHBOARDS, PANELBOARDS,

2. EQUIPMENT NAMEPLATES SHALL BE BLACK - 1/16" THICK PLASTIC, WITH WHITE

3. SECURE NAMEPLATE TO EQUIPMENT SURFACE WITH ADHESIVE CEMENT FOR INTERIOR LOCATIONS, AND BRASS SCREWS FOR EXTERIOR LOCATIONS.

DETAIL: EQUIPMENT NAMEPLATES & LABELS

DISCONNECT SWITCHES, MOTOR STARTERS, VFD'S AND SPECIAL PURPOSE

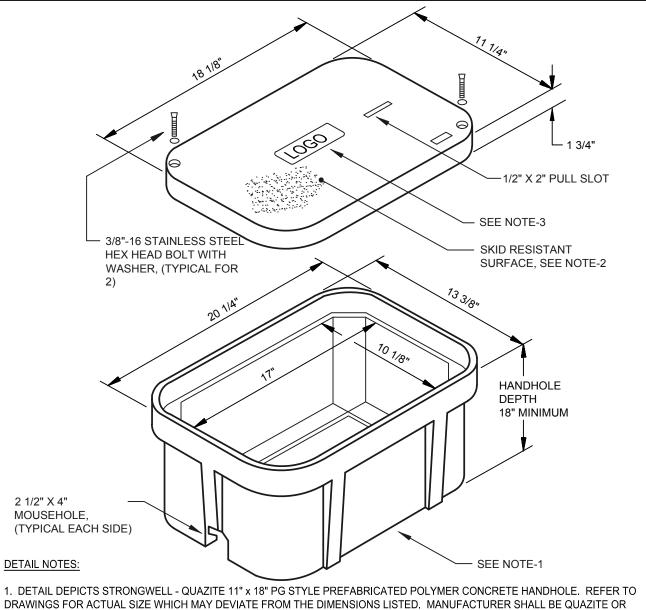
CENTER LAMINATION. ENGRAVED VERBIAGE/TEXT SHALL BE WHITE. TEXT

NAMEPLATE NOTES:

RECEPTACLES (AS APPLICABLE).


LETTERS SHALL BE 1/4" TALL MINIMUM.






- DRAWINGS FOR ACTUAL SIZE WHICH MAY DEVIATE FROM THE DIMENSIONS LISTED. MANUFACTURER SHALL BE QUAZITE OR APPROVED EQUAL BY CONCAST INC. OR JENSEN PRECAST.
- 2. STANDARD HANDHOLE COVER IS INTENDED FOR OCCASIONAL NON-DELIBERATE LIGHT VEHICULAR TRAFFIC ONLY, (DESIGN LOAD 8,000 lbs OVER A 10" SQUARE). PROVIDE HEAVY-DUTY COVER, (DESIGN LOAD 15,000 lbs OVER A 10" SQUARE), IF HANDHOLE IS INSTALLED IN DRIVEWAYS, PARKING LOTS AND OFF-ROADWAY APPLICATIONS SUBJECT TO OCCASIONAL NON-DELIBERATE HEAVY
- 3. PROVIDE COVER LOGO / VERBIAGE AS APPLICABLE FOR THE SERVICE REQUIRED, (e.g. ELECTRIC, TELEPHONE, LIGHTING, etc.).

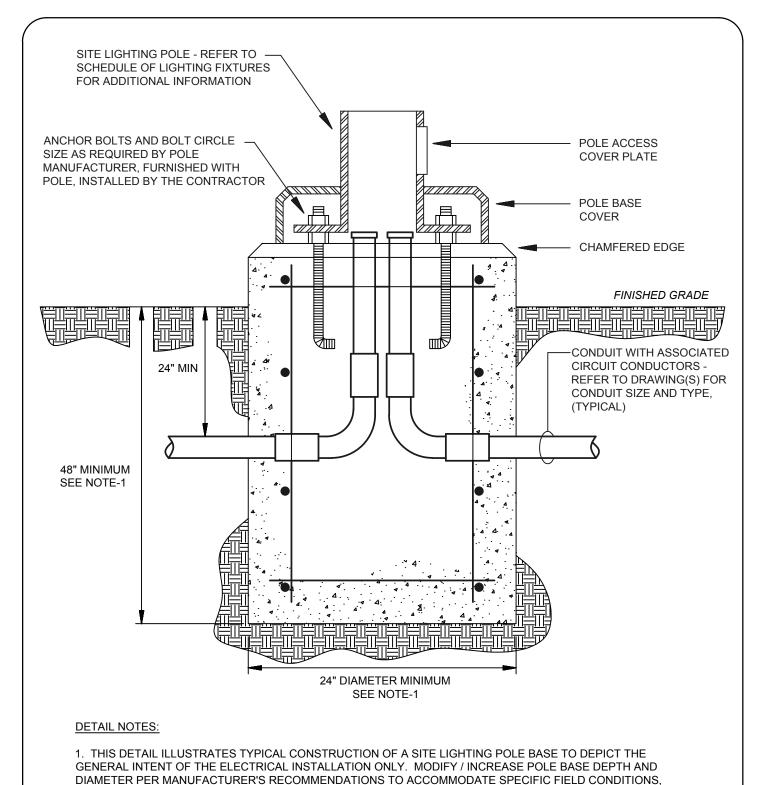DETAIL: PREFABRICATED HANDHOLE



DETAIL: SITE LIGHTING POLE BASE

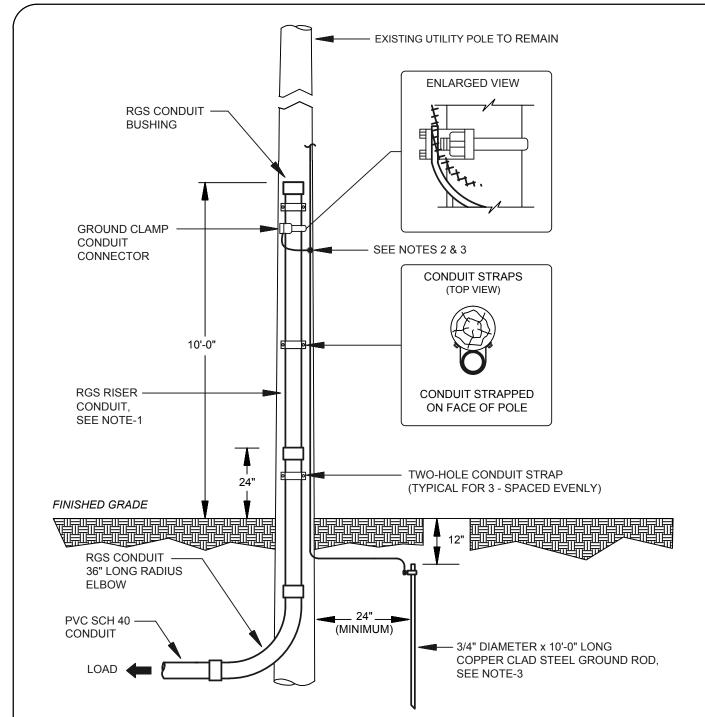AND SOIL CHARACTERISTICS. REFER TO LANDSCAPE ARCHITECT DRAWINGS FOR ADDITIONAL



DETAIL NOTES:

- 1. RISER CONDUIT(S) SHALL BE LOCATED ON POLE OPPOSITE FLOW OF TRAFFIC WHENEVER POSSIBLE. COORDINATE SPECIFIC REQUIREMENTS WITH UTILITY SERVICE PROVIDER.
- a) CONDUITS DESIGNATED AS "ACTIVE" SHALL EXTEND APPROXIMATELY 10'-0" UP UTILITY POLE. CONDUITS DESIGNATED AS "SPARE" SHALL BE STUBBED-UP APPROXIMATELY 24"AFG, AND CAPPED FOR FUTURE USE.
- 2. RISER CONDUIT SHALL BE GROUNDED TO ARRESTER GROUND LEAD WHERE AVAILABLE. CONNECTION SHALL BE VIA #6 AWG BARE COPPER CONDUCTOR. PROVIDE IN 3/4"C (PVC SCH 40). EXTEND CONDUIT TO TOP
- 3. PROVIDE EXOTHERMIC WELD FOR ALL GROUND CABLE CONNECTIONS.

DETAIL: UTILITY POLE RISER



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CLIENT:

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REVISIONS:

REV DATE NOTE

PROJECT: KMDG #1604

HOYT SULLIVAN PLAYGROUND

117 CENTRAL STREET SOMERVILLE, MA 02145

DRAWING:

ELECTRICAL DETAIL SHEET

DRAWN: REVIEW: AMA

SCALE:

N.T.S.

DATE: **16 FEBRUARY 2017**

IRRIGATION NOTES

- . SEE IRRIGATION DETAILS AND SPECIFICATIONS SECTION 328400 FOR ADDITIONAL REQUIRED INFORMATION.
- COORDINATE FINAL LOCATION OF SPRINKLERS, NOZZLES, AND DRIP IRRIGATION WITH FINAL APPROVED LANDSCAPE.
- WITH FINAL APPROVED LANDSCAPE.


 3. ALL PIPE AND VALVE LOCATIONS ARE DIAGRAMMATIC FOR CLARITY: CONTRACTOR
- SHALL FIELD VERIFY.

 4. SPECIFIED VALVE BOX LOCATIONS SHALL BE APPROVED BY LANDSCAPE ARCHITECT AND/OR OWNER'S REPRESENTATIVE
- 5. ALL CONTROL WIRE SHALL BE 14AWG 24VAC GROUNDED IN ACCORDANCE WITH MANUFACTURER.
- 6. IRRIGATION SYSTEM AIS DESIGNED FOR MUNICIPAL WATER SUPPLY TO PROVIDE 20 GPM MAXIMUM FROM EXISTING STREET SERVICE. SYSTEM TO PRODUCE 100-PSI STATIC PRESSURE FROM STREET AS PER SOMERVILLE WATER DEPARTMENT. CONTRACTOR SHALL TEST DYNAMIC PRESSURE BEFORE STARTING WORK AND REPORT ANY DEVIATION TO THE OWNER'S REPRESENTATIVE BEFORE CONTINUING.
- INSTALL NEW CONTROLLER IN PEDESTAL ON CONCRETE PAD OUTDOORS AS
 DIRECTED BY OWNER'S REPRESENTATIVE, HARD WIRE TO 120 VOLT, DEDICATED
 20-AMP CIRCUIT, POWER SUPPLY USING LICENSED ELECTRICIAN. ROUTE ALL VALVE
 WIRES TO CONTROLLER VIA 2-INCH CONDUIT THROUGH CONCRETE PAD.
 ALL ABOVE GROUND WIRING SHALL BE INSTALLED IN RIGID, METALLIC CONDUIT FOR
- VANDALISM PROTECTION.

 9. COORDINATE LOCATION OF ALL EXISTING AND FUTURE UTILITIES ON SITE, CONTACT
- 9. COORDINATE LOCATION OF ALL EXISTING AND FUTURE UTILITIES ON SITE, CONTAC PROPER AUTHORITIES AND UTILITY COMPANIES BEFORE THE START OF WORK.
- FLUSH ALL LATERAL LINES BEFORE INSTALLING SPRINKLERS AND DRIP IRRIGAITON.
 CONTRACTOR MUST SUBMIT PRODUCT SUBMITTALS AND CATALOG CUTS AS PER THE WRITTEN SPECIFICATIONS TO THE IRRIGATION CONSULTANT FOR APPROVAL PRIOR TO ORDERING MATERIAL AND BEGINNING WORK.
- 12. MATERIAL SUBSTITUTIONS WHICH VARY FROM THE SPECIFIED PRODUCTS MUST BE SUBMITTED TO THE IRRIGATION CONSULTANT FOR APPROVAL AS PART OF THE SUBMITTAL PROCESS.
- 13. ONCE APPROVED SUBMITTALS HAVE BEEN RETURNED TO THE CONTRACTOR, WORK MAY BEGIN. OWNER'S REPRESENTATIVE MUST BE NOTIFIED 7 DAYS IN ADVANCE OF THE START OF WORK TO COORDINATE ON-SITE SUPERVISION AND ADMINISTRATION.
- 14. FINAL LOCATION AND CONFIGURATION OF BACKFLOW PREVENTER AND WATER METER SHALL BE APPROVED BY OWNER'S REPRESENTATIVE AND PER LOCAL WATER DEPARTMENT.


IRRIGATION SCHEDULE

SYMBOL	MANUFACTURER/MODEL	QTY
ES LCS RCS CS SS	12-Inch Pop-Up with Check Valve, 30 psi 5` strip spra	у 3
5 5 5 Q H F	12-Inch Pop-Up with Check Valve, 30 psi 5` radius	3
8 8 8 8 Q T H F	12-Inch Pop-Up with Check Valve, 30 psi 8` radius	8
<u> </u>	12-Inch Pop-Up with Check Valve, 30 psi 9' strip spra	y 13
SST 10 10 10 10 Q T H F	12-Inch Pop-Up with Check Valve, 30 psi 10` radius	29
12 12 12 12 12 12 Q T H IT IQ F	12-Inch Pop-Up with Check Valve, 30 psi 12' radius	16
15 15 15 15 15 15 Q T H II IQ F	12-Inch Pop-Up with Check Valve, 30 psi 15` radius	4
4 6 8 10 12 15 17	12-Inch Pop-Up with Check Valve, 30 psi adjustable	15
SYMBOL	MANUFACTURER/MODEL	QTY
	Drip Zone Kit with Filter	4
(P)	Automatic Flush Valve	9
	Double Drip Rings for Trees Netafim TLDL 0.9 gal/hour, 12-inch spacing	1,000 lf
SYMBOL	MANUFACTURER/MODEL	QTY
	Electric Zone Valve with Filter Sentry/Scrubber	7
	Quick Coupling Valve with 40 psi Pressure Regulator	3
X	Isolation Gate Valve	2
\triangle	Hand Pump Pressure Regulator (from Manufacturer)	1
BF	Backflow Preventers (See Detail for Sizes)	3
IC	16-Zone Conventional Wire Controller	1
⟨C⟩	Internet/Cellular Communications Package	1
M	Water Meter (per City of Somerville)	1
	Irrigation Lateral Line: Polyethylene Pipe SDR-7 1" 1,	200 l.f.
	Irrigation Mainline: Schedule 40 PVC $1\frac{1}{2}$ "	300 l.f.
=======	Pipe Sleeve: PVC Class 160 SDR 26	120 l.f.

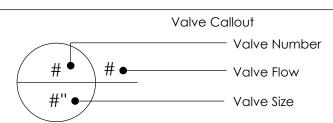

IRRIGATION VALVE WIRE SCHEDULE

NUMBER	WIRE TYPE	ZONE	LENGTH
1	14AWG Valve Wire	Shrub Spray	275'
2	14AWG Valve Wire	Shrub Spray	275'
3	14AWG Valve Wire	Tree Drip	275'
4	14AWG Valve Wire	Tree Drip	212'
5	14AWG Valve Wire	Shrub Spray	212'
6	14AWG Valve Wire	Shrub Spray	212'
7	14AWG Valve Wire	Tree Drip	140'
8	14AWG Valve Wire	Shrub Spray	140'
9	14AWG Valve Wire	Shrub Spray	85'
10	14AWG Valve Wire	Shrub Spray	22'
11	14AWG Valve Wire	Tree Drip	22'
3 Spares	14AWG Valve Wire	Spares	825'
	14AWG Common Wire		280'
	Total 14AWG Wire		2,975 feet

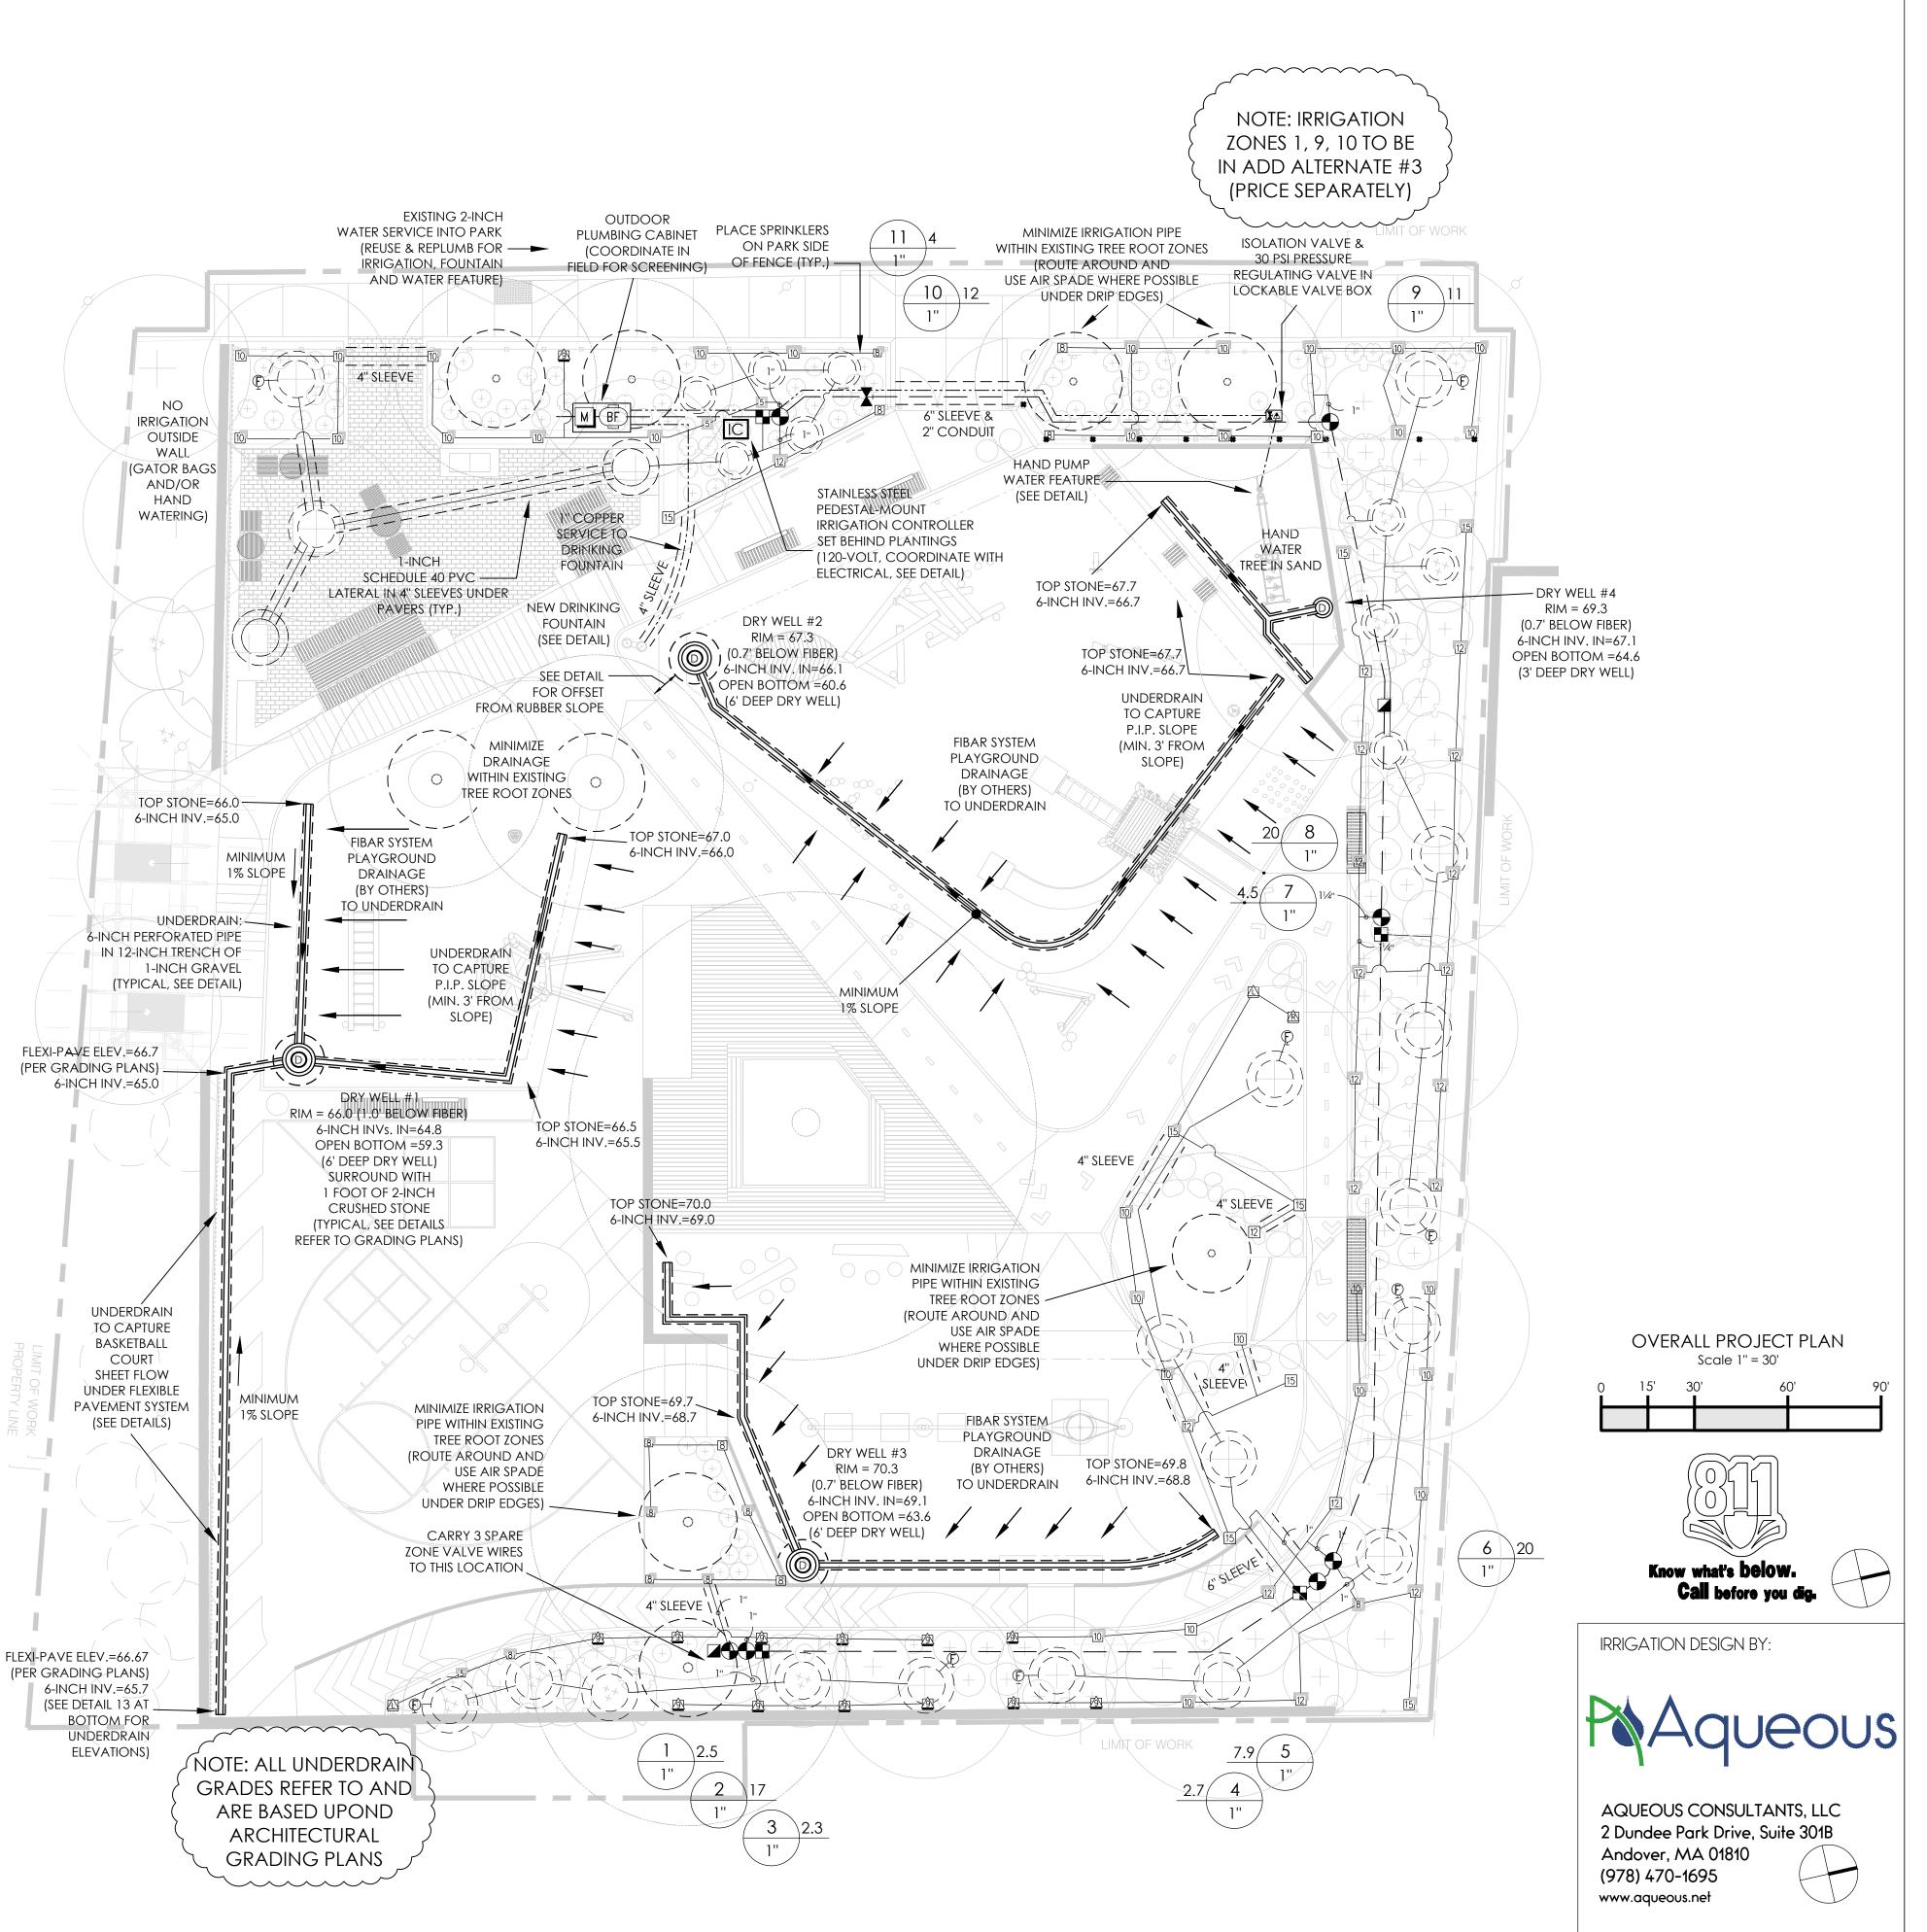



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REVISIONS:

REV DATE NOTE

PROJECT: KMDG #1604

HOYT SULLIVAN PLAYGROUND

117 CENTRAL STREET SOMERVILLE, MA 02145

DRAWING:

IRRIGATION & WATER LAYOUT PLAN

DRAWN:

REVIEW: MI/SM

SCALE:

1" = 10'-0"


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REVISIONS:

REV DATE NOTE

PROJECT: KMDG #1604

HOYT SULLIVAN PLAYGROUND

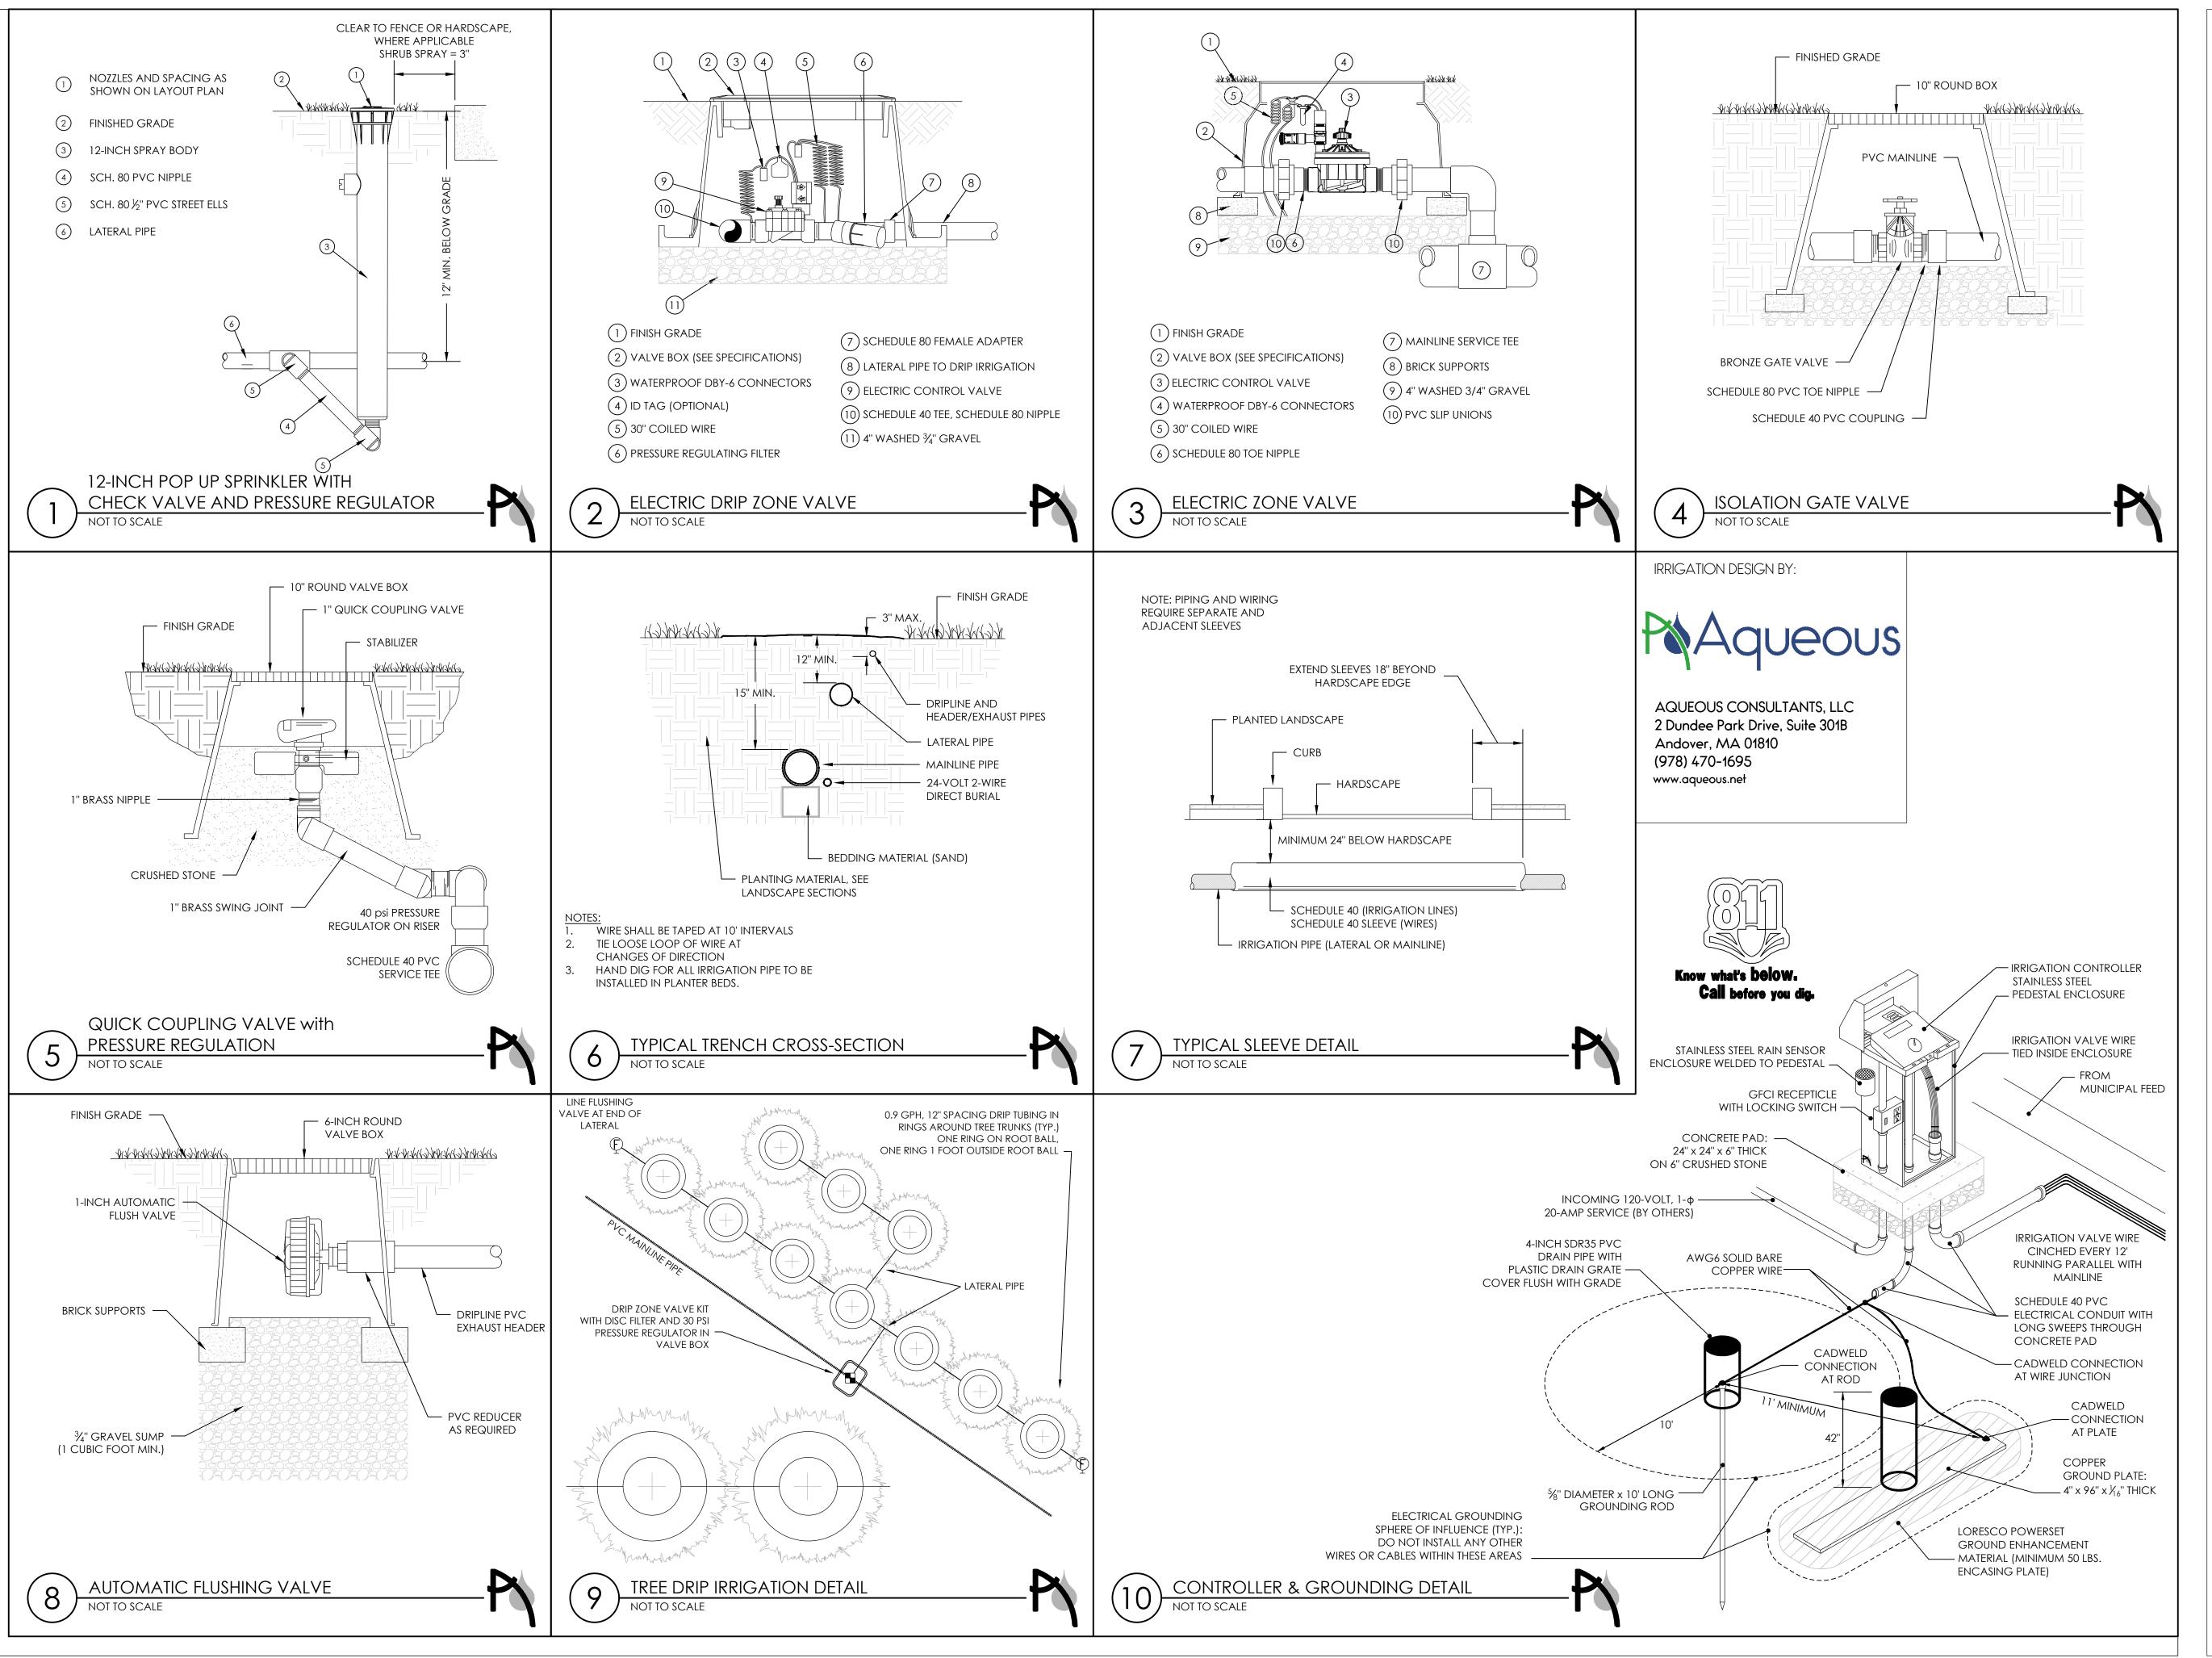117 CENTRAL STREET SOMERVILLE, MA 02145

DRAWING:

IRRIGATION DETAILS

DRAWN: REVIEW:

MI/SM

SCALE:
AS NOTED


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REVISIONS:

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PROJECT: KMDG #1604

HOYT SULLIVAN PLAYGROUND

117 CENTRAL STREET SOMERVILLE. MA 02145

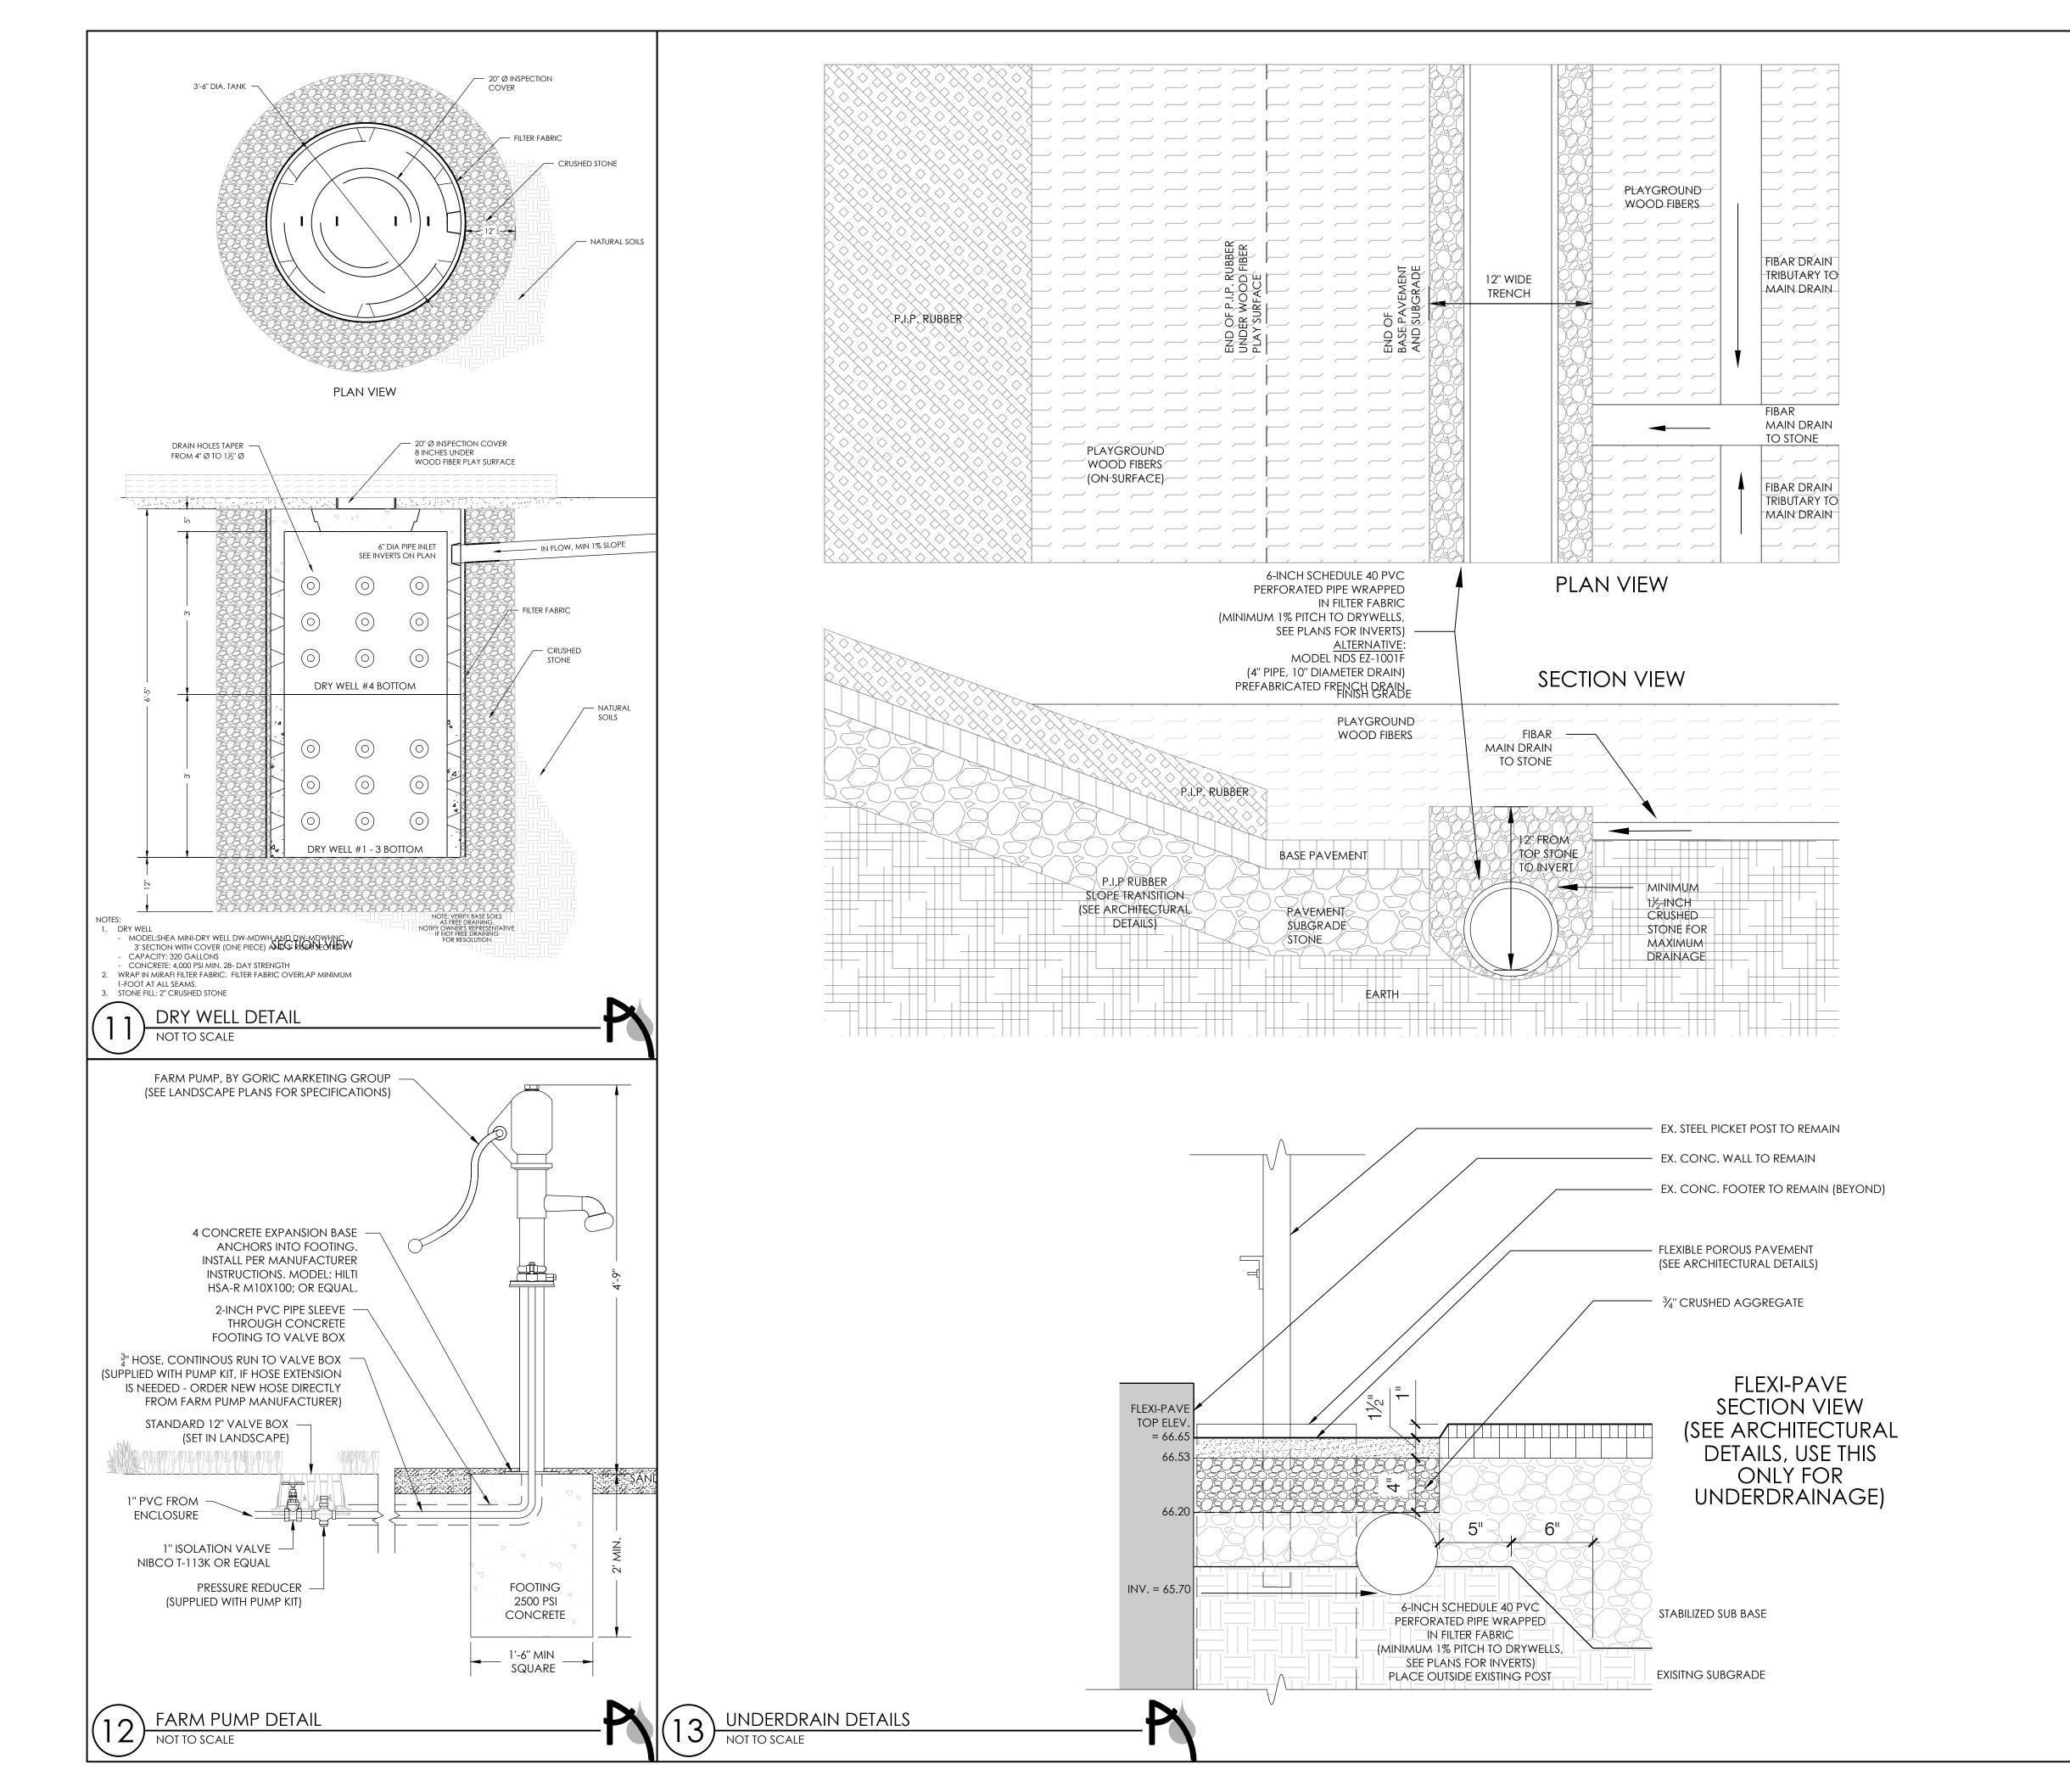DRAWING:

WATER PLAY DETAILS

DRAWN:

REVIEW: MI/SM

SCALE:

AS NOTED

DATE:

16 FEBRUARY 2017

SHEET:

IRRIGATION DESIGN BY:

AQUEOUS CONSULTANTS, LLC

2 Dundee Park Drive, Suite 301B


Andover, MA 01810


(978) 470-1695

www.aqueous.net



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KLOPFER MARTIN S DESIGN GROUP
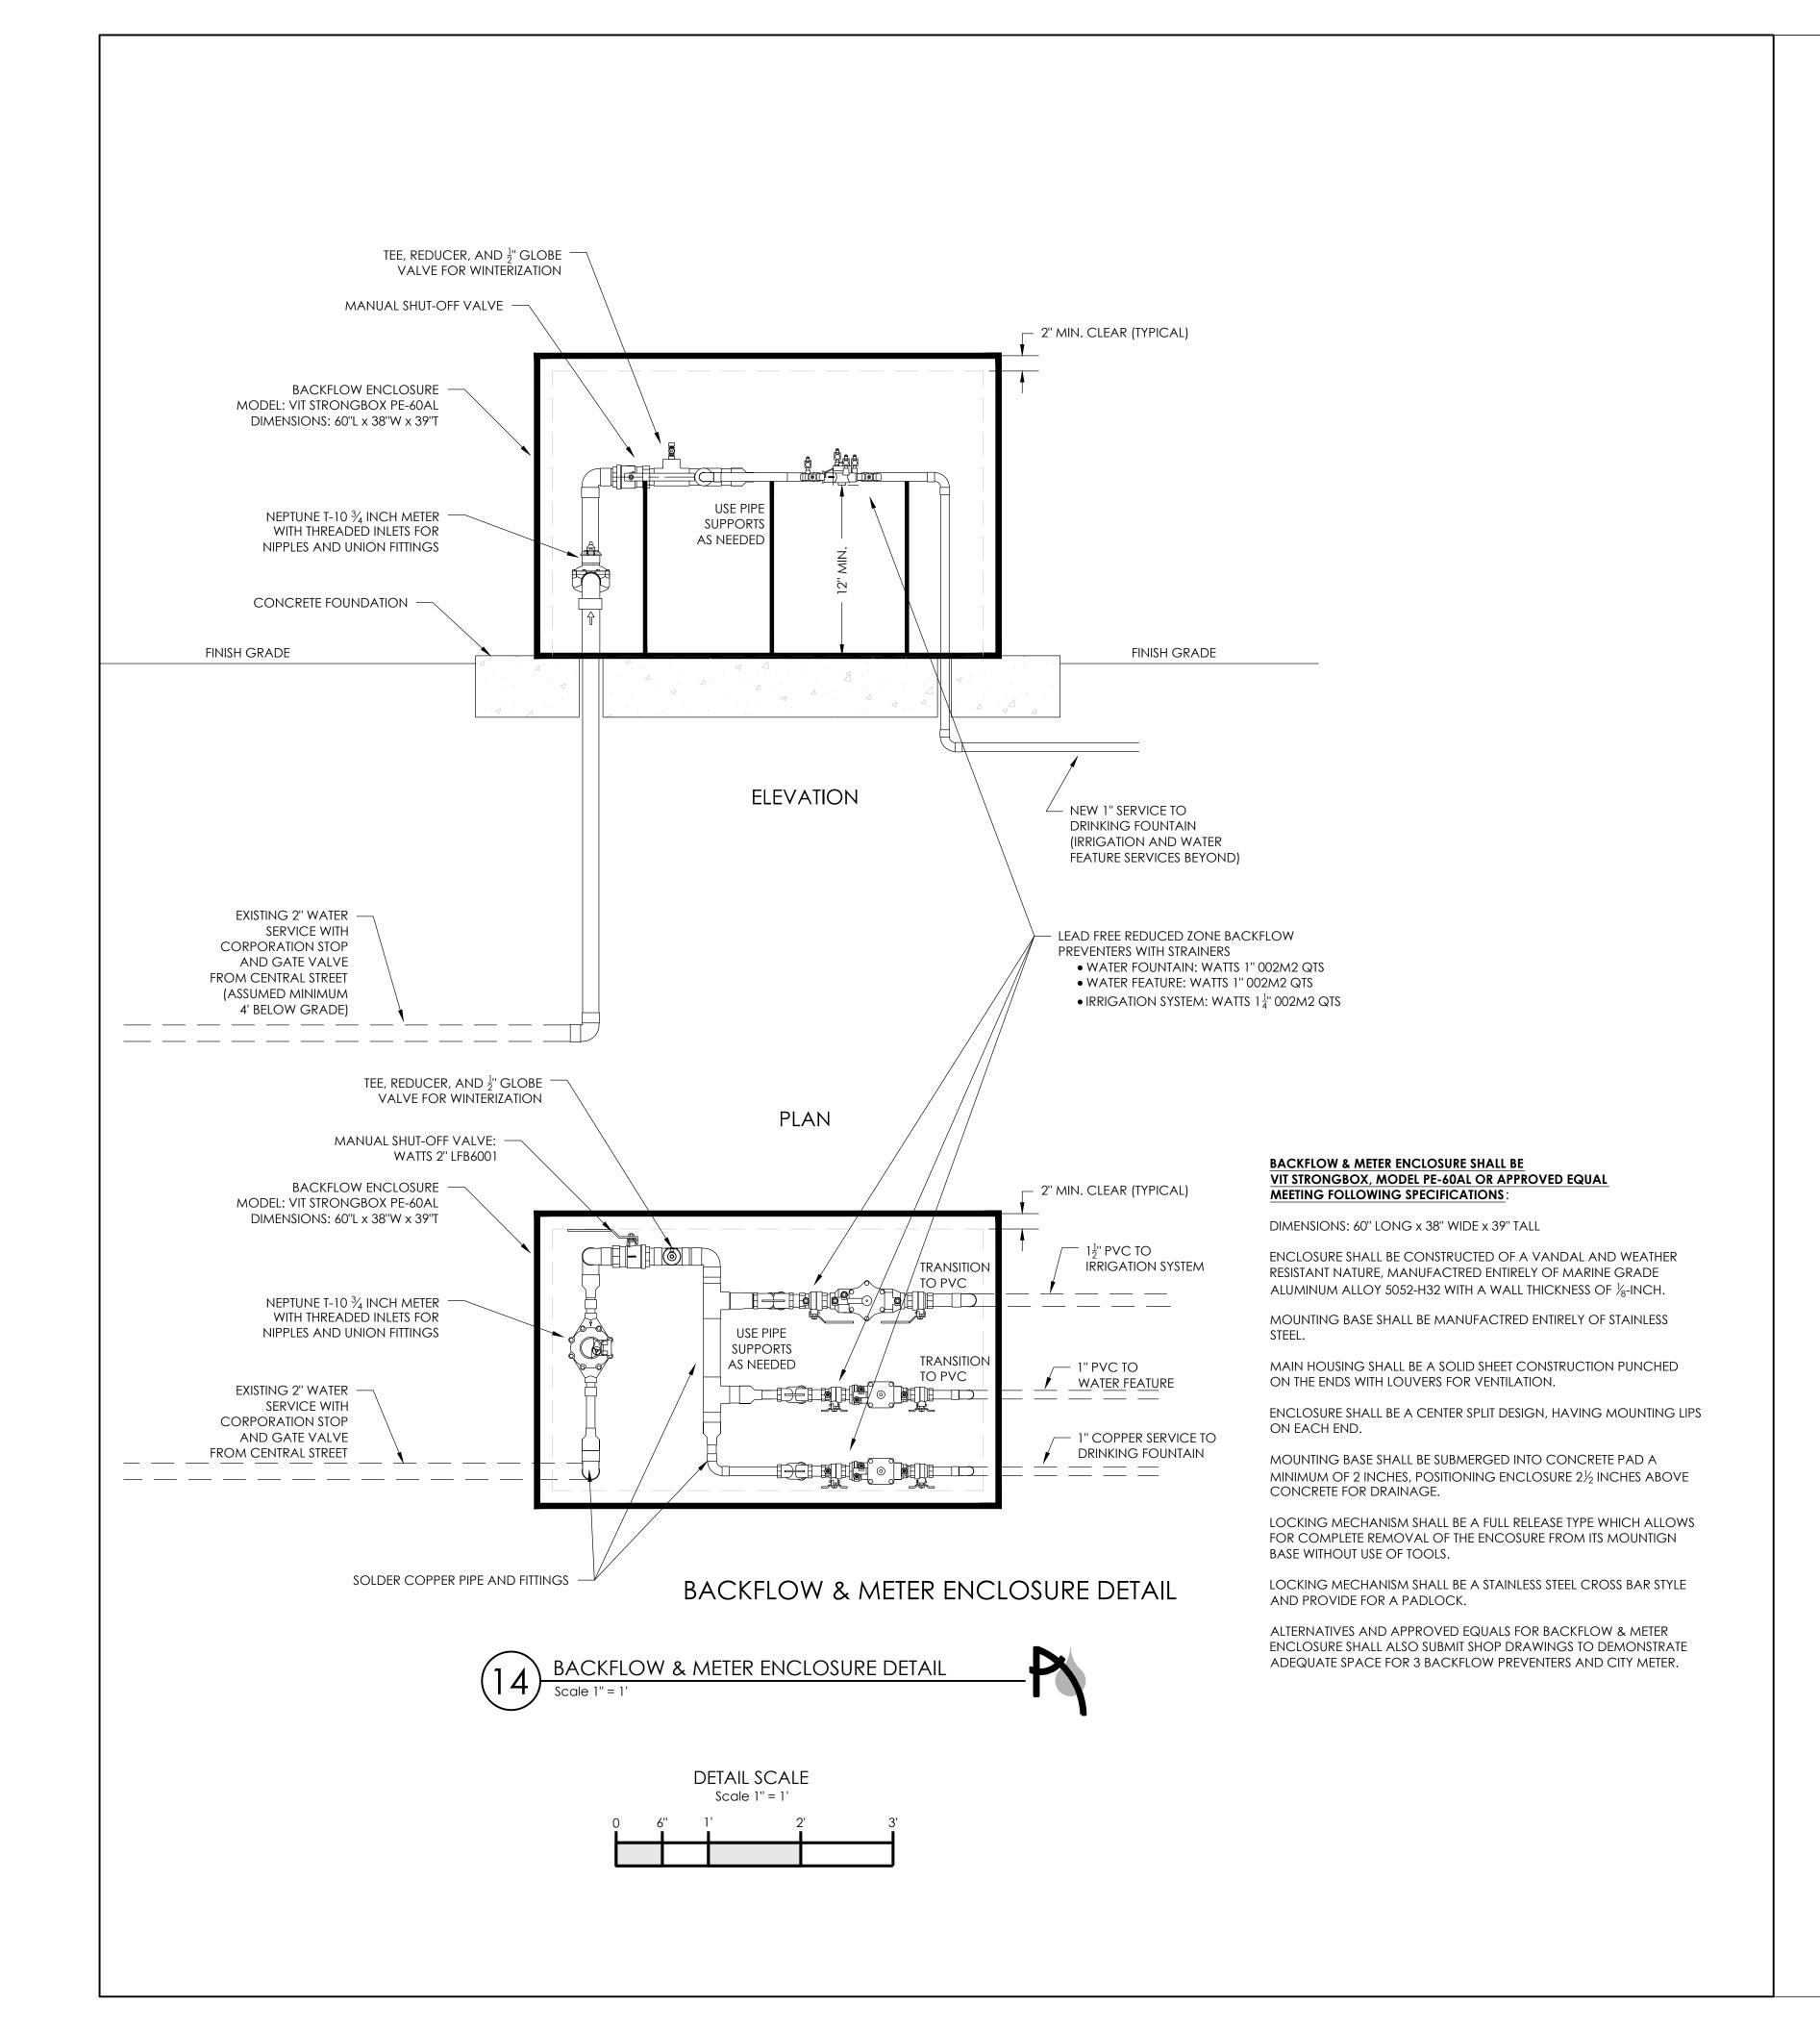
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REVISIONS:

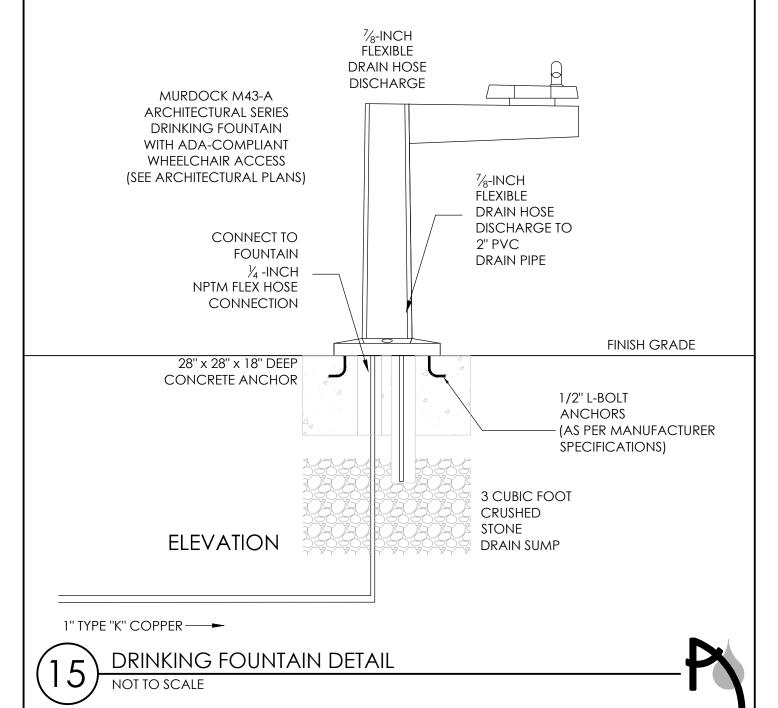REV DATE NOTE

PROJECT: KMDG #1604

HOYT SULLIVAN PLAYGROUND

117 CENTRAL STREET SOMERVILLE, MA 02145

DRAWING:

OUTDOOR CROSS CONNECTION DETAILS

DRAWN:

REVIEW: MI/SM

SCALE:

1'' = 1' at 22" x 34" Sheet

DATE:

16 FEBRUARY 2017

SHEET:


IRRIGATION DESIGN BY:

Andover, MA 01810 (978) 470-1695 www.aqueous.net

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REVISIONS:

REV DATE NOTE

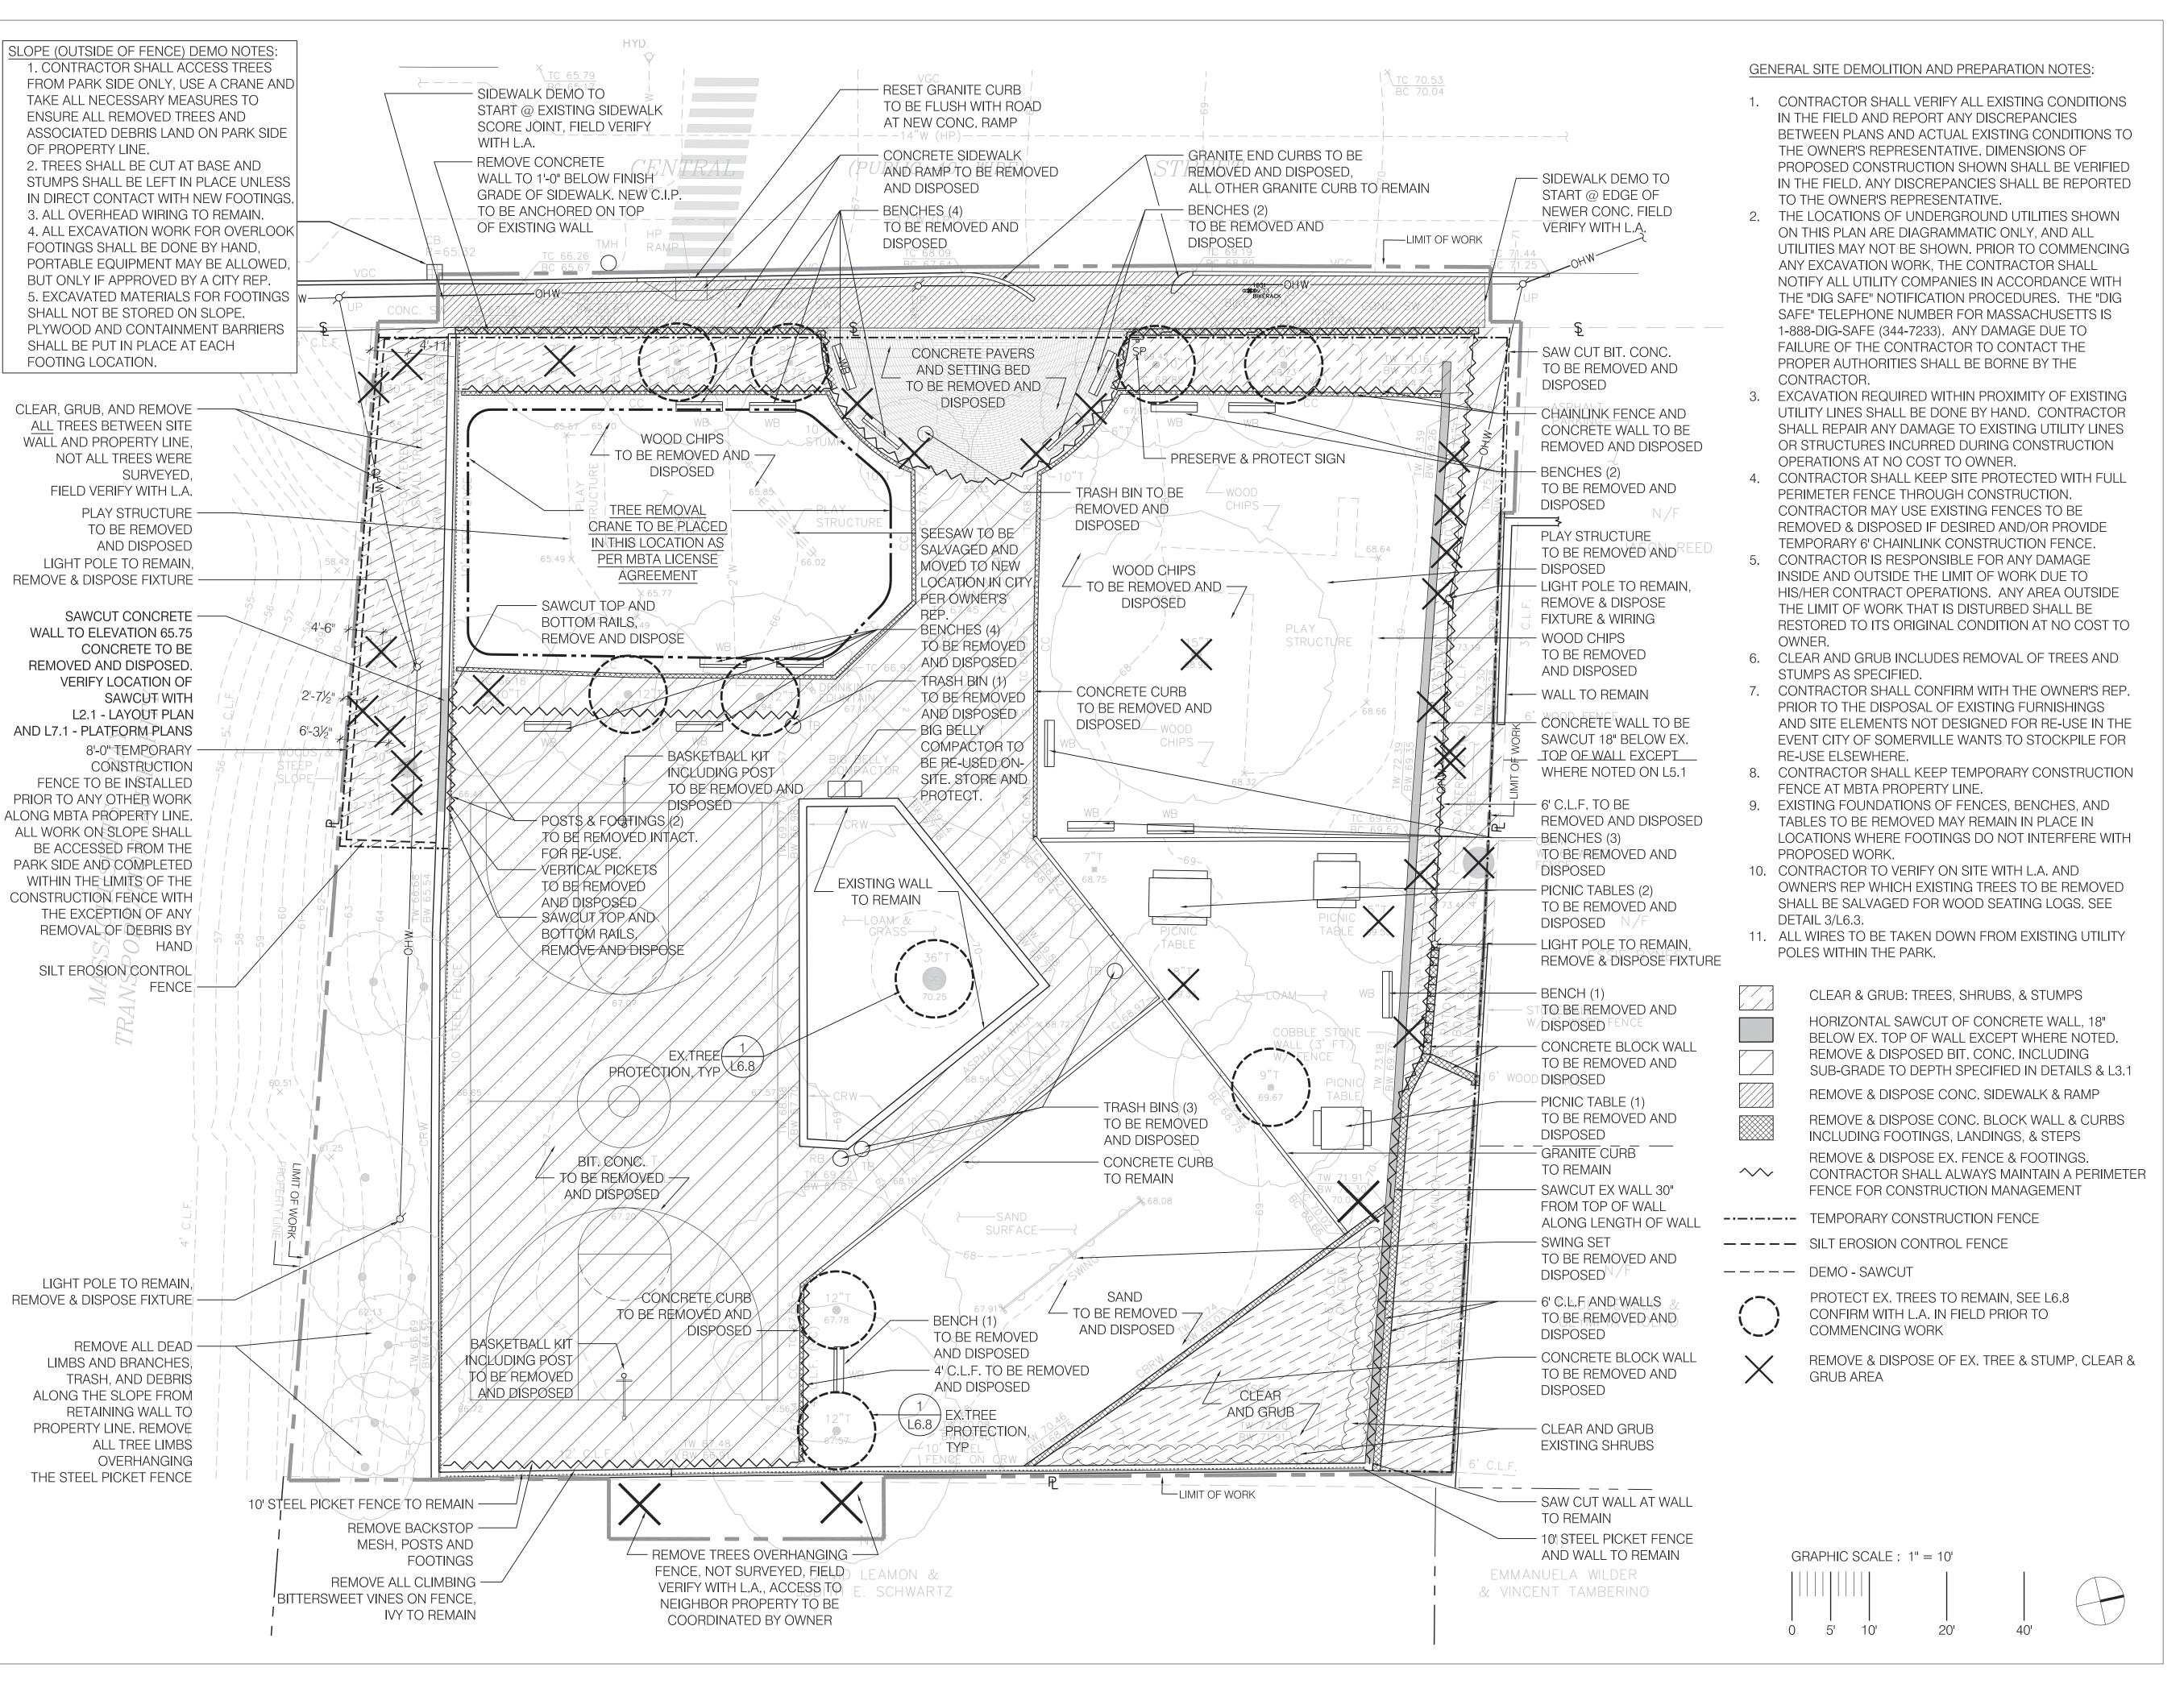PROJECT: KMDG #1604

HOYT SULLIVAN PLAYGROUND

117 CENTRAL STREET SOMERVILLE. MA 02145

DRAWING:

DEMOLITION & SITE PREP PLAN

DRAWN: REVIEW: DS

SK, KM

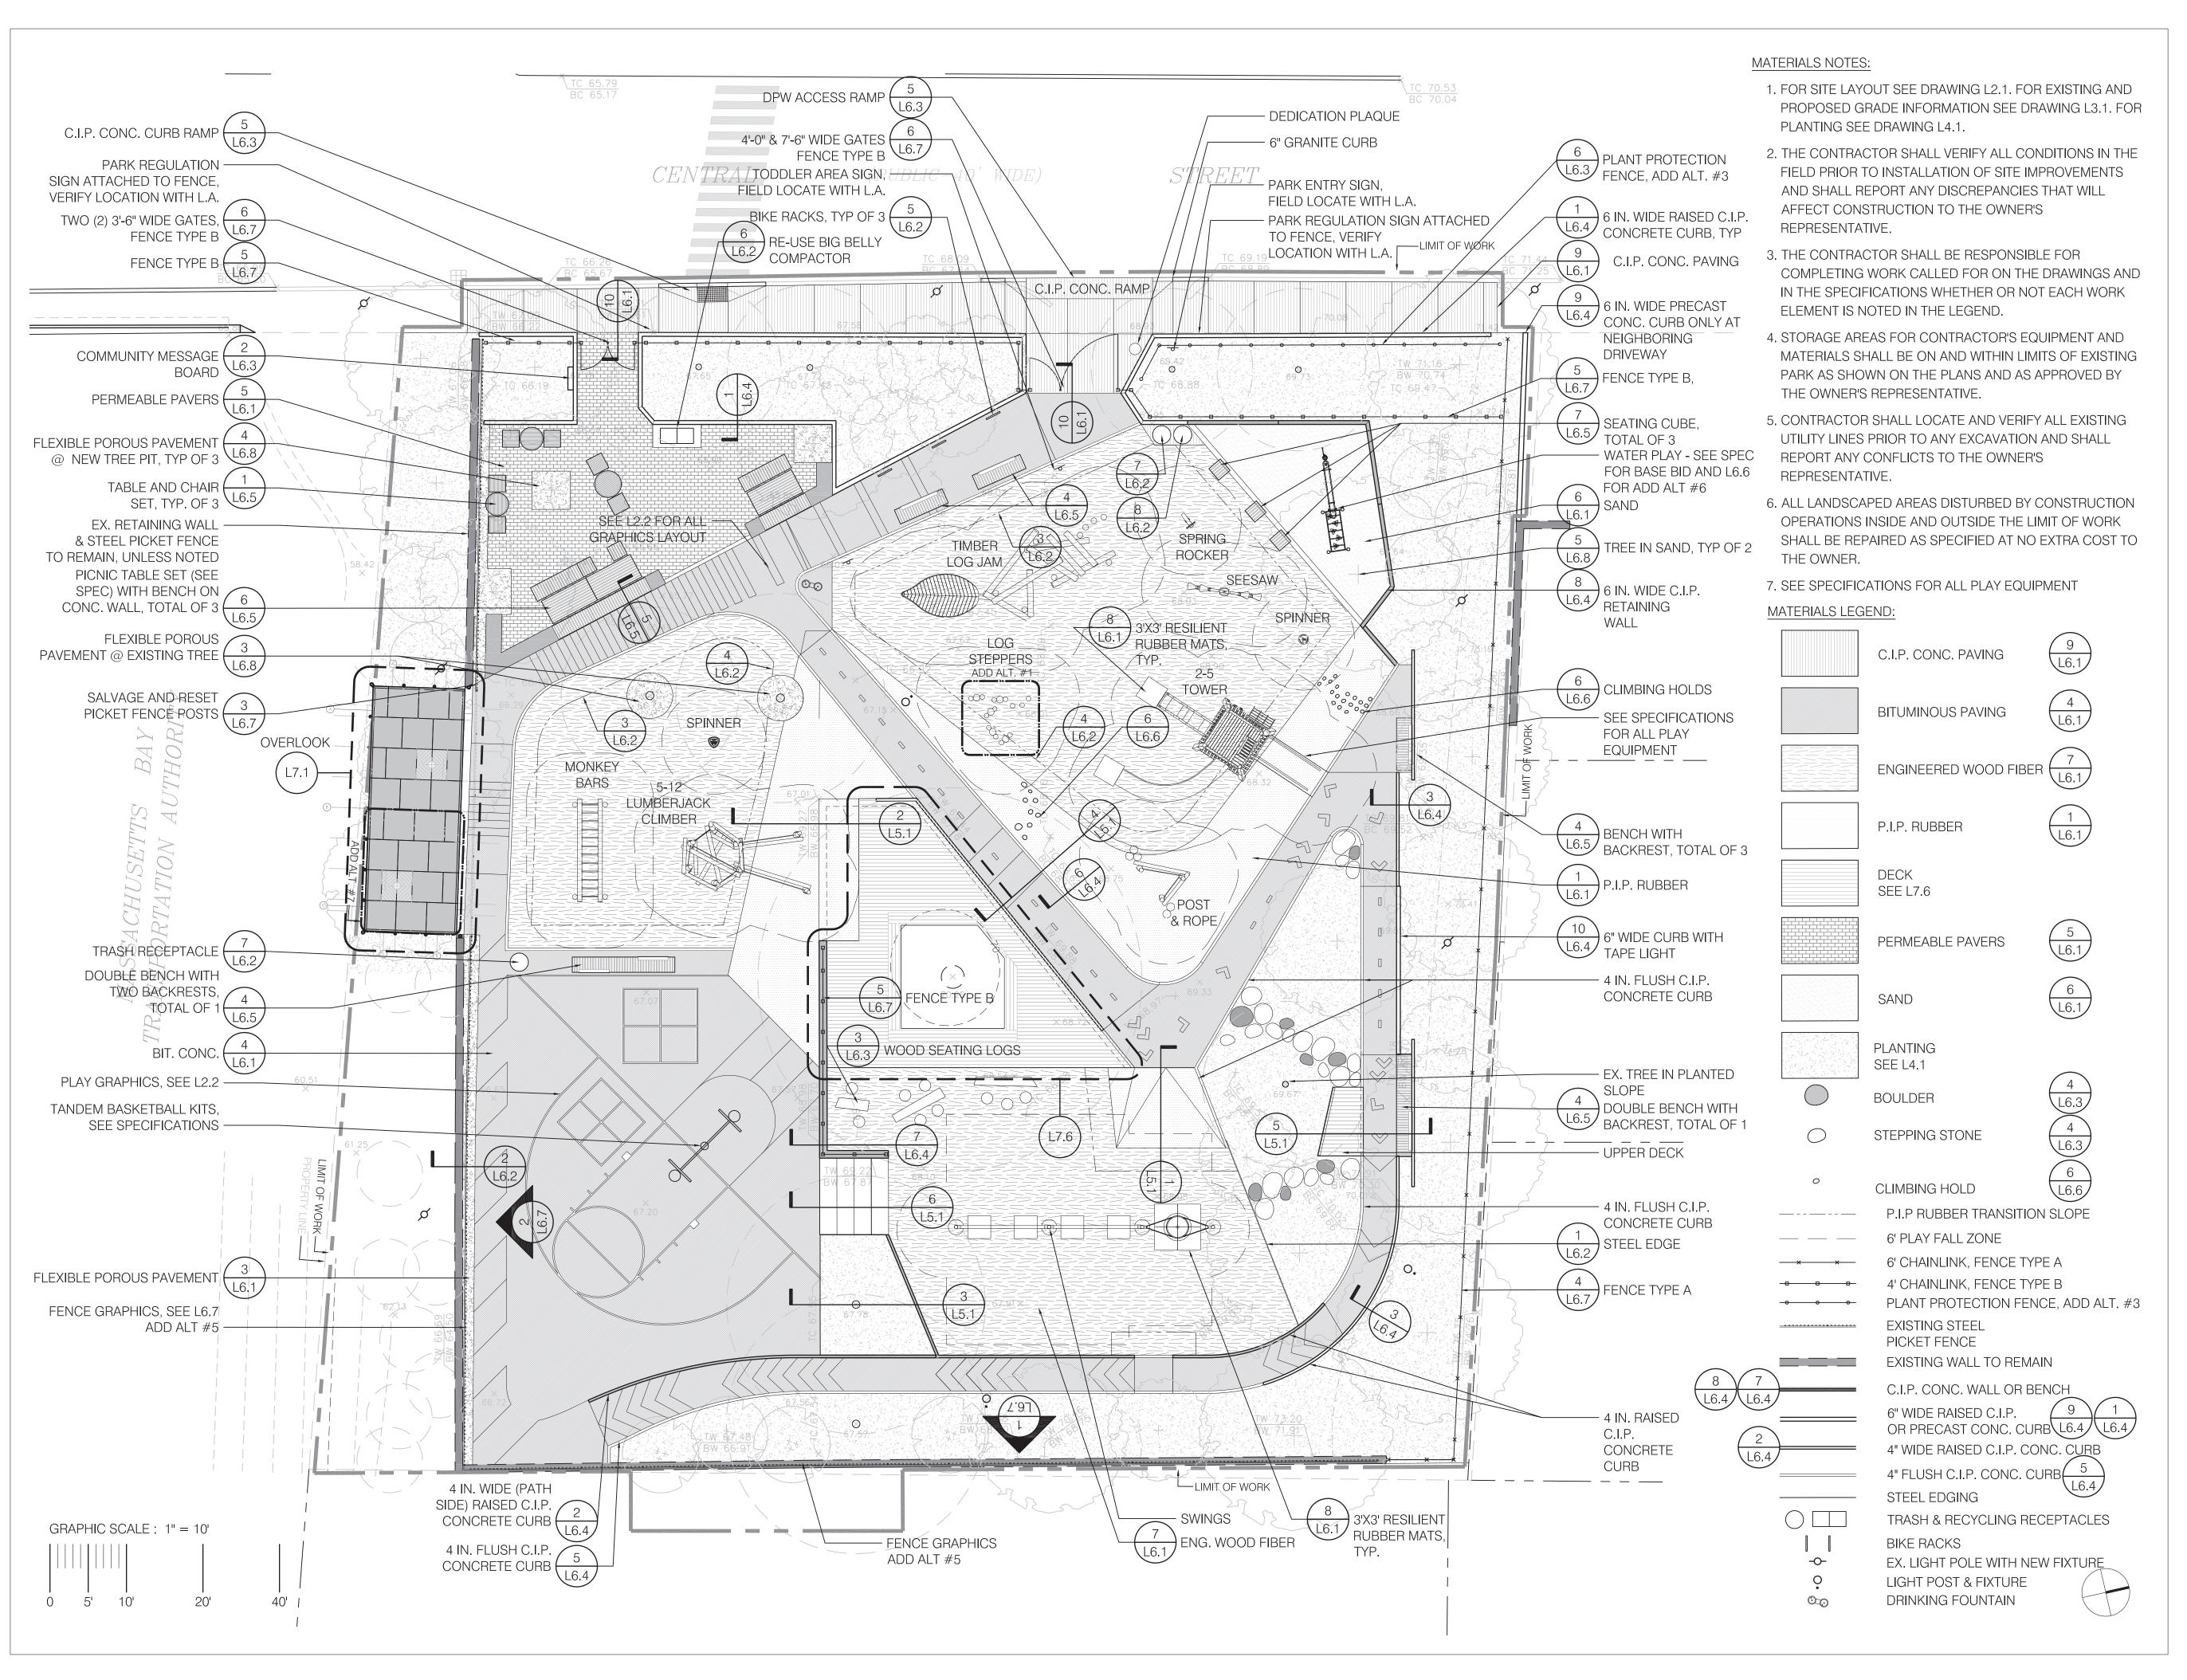
SCALE:

1" = 10'-0"

DATE:

16 FEBRUARY 2017







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REV DATE	NOTE	
-		

PROJECT: KMDG #1604

HOYT SULLIVAN PLAYGROUND

117 CENTRAL STREET SOMERVILLE, MA 02145

DRAWING:

MATERIALS PLAN

DRAWN:	REVIEW
DS/EH	SK

SCALE:

1" = 10'-0"


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HOYT SULLIVAN PLAYGROUND

117 CENTRAL STREET SOMERVILLE, MA 02145

DRAWING:

LAYOUT PLAN

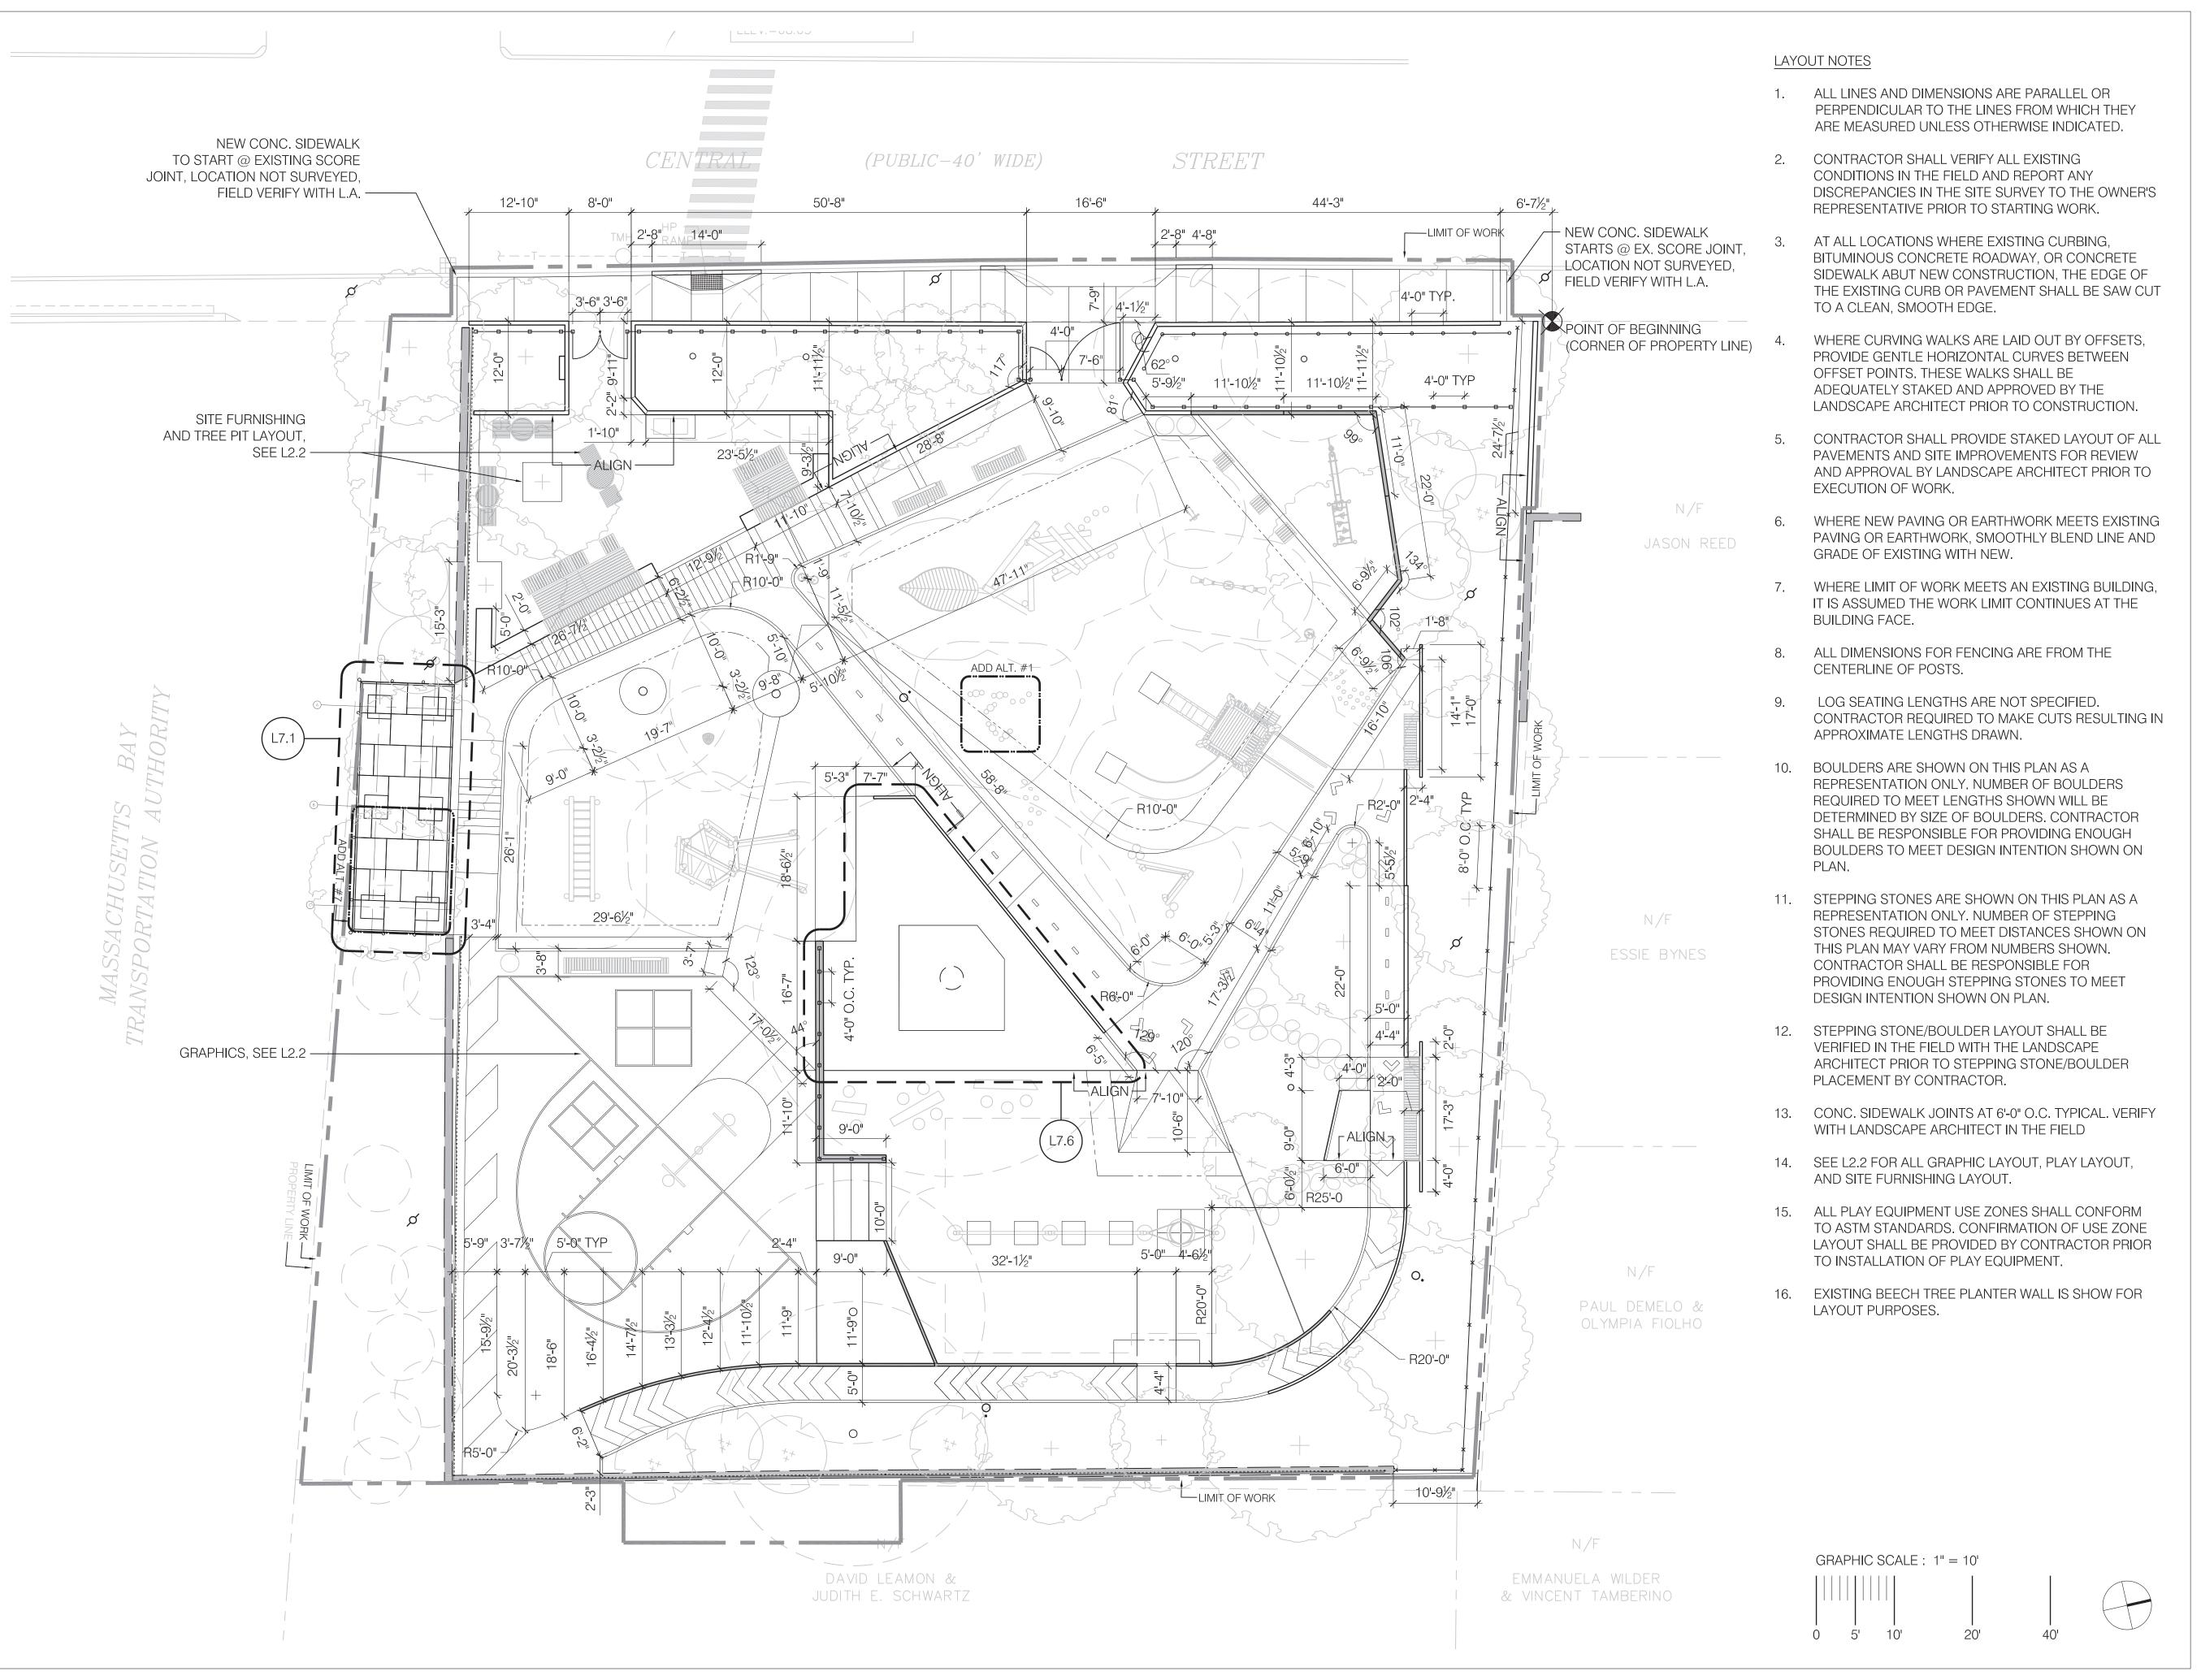DRAWN: REVIEW:

DS SK

SCALE:

1" = 10'-0"


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PROJECT: KMDG #1604

HOYT SULLIVAN PLAYGROUND

117 CENTRAL STREET SOMERVILLE, MA 02145

DRAWING:

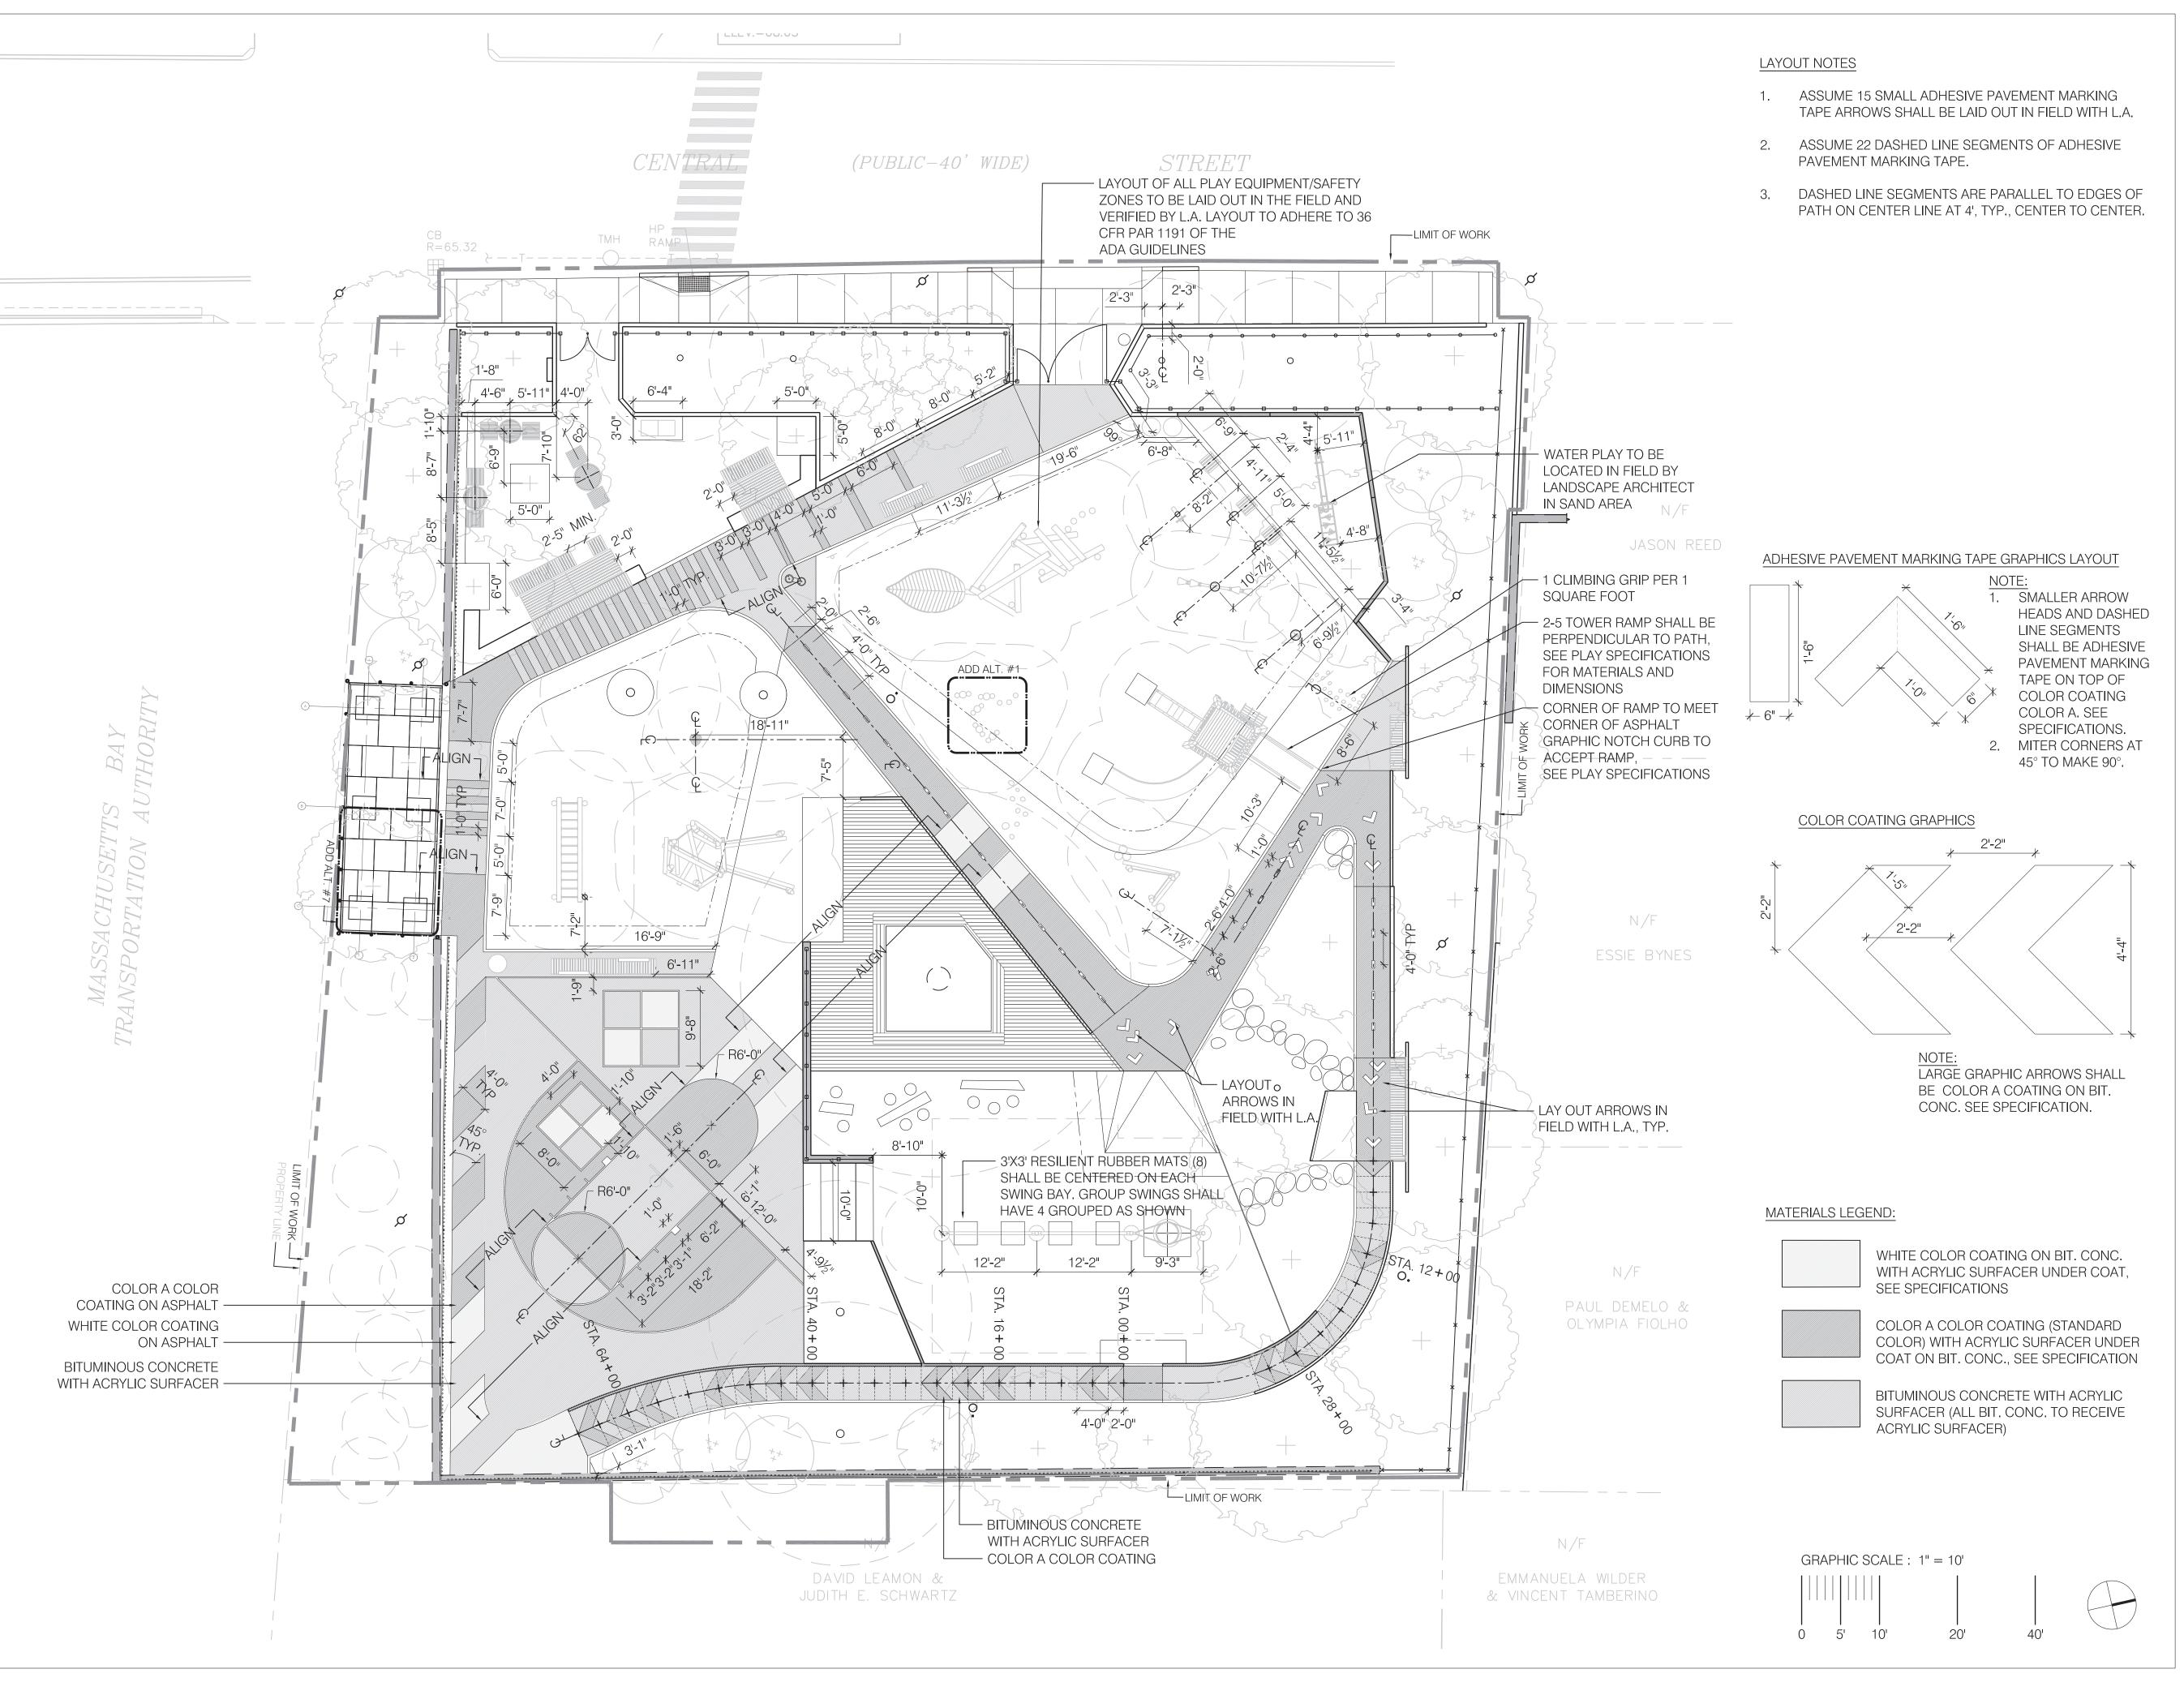GRAPHICS & FURNISHING LAYOUT PLAN

DRAWN: REVIEW:
DS SK

SCALE:

1" = 10'-0"


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PROJECT: KMDG #1604

HOYT SULLIVAN PLAYGROUND

117 CENTRAL STREET SOMERVILLE, MA 02145

DRAWING:

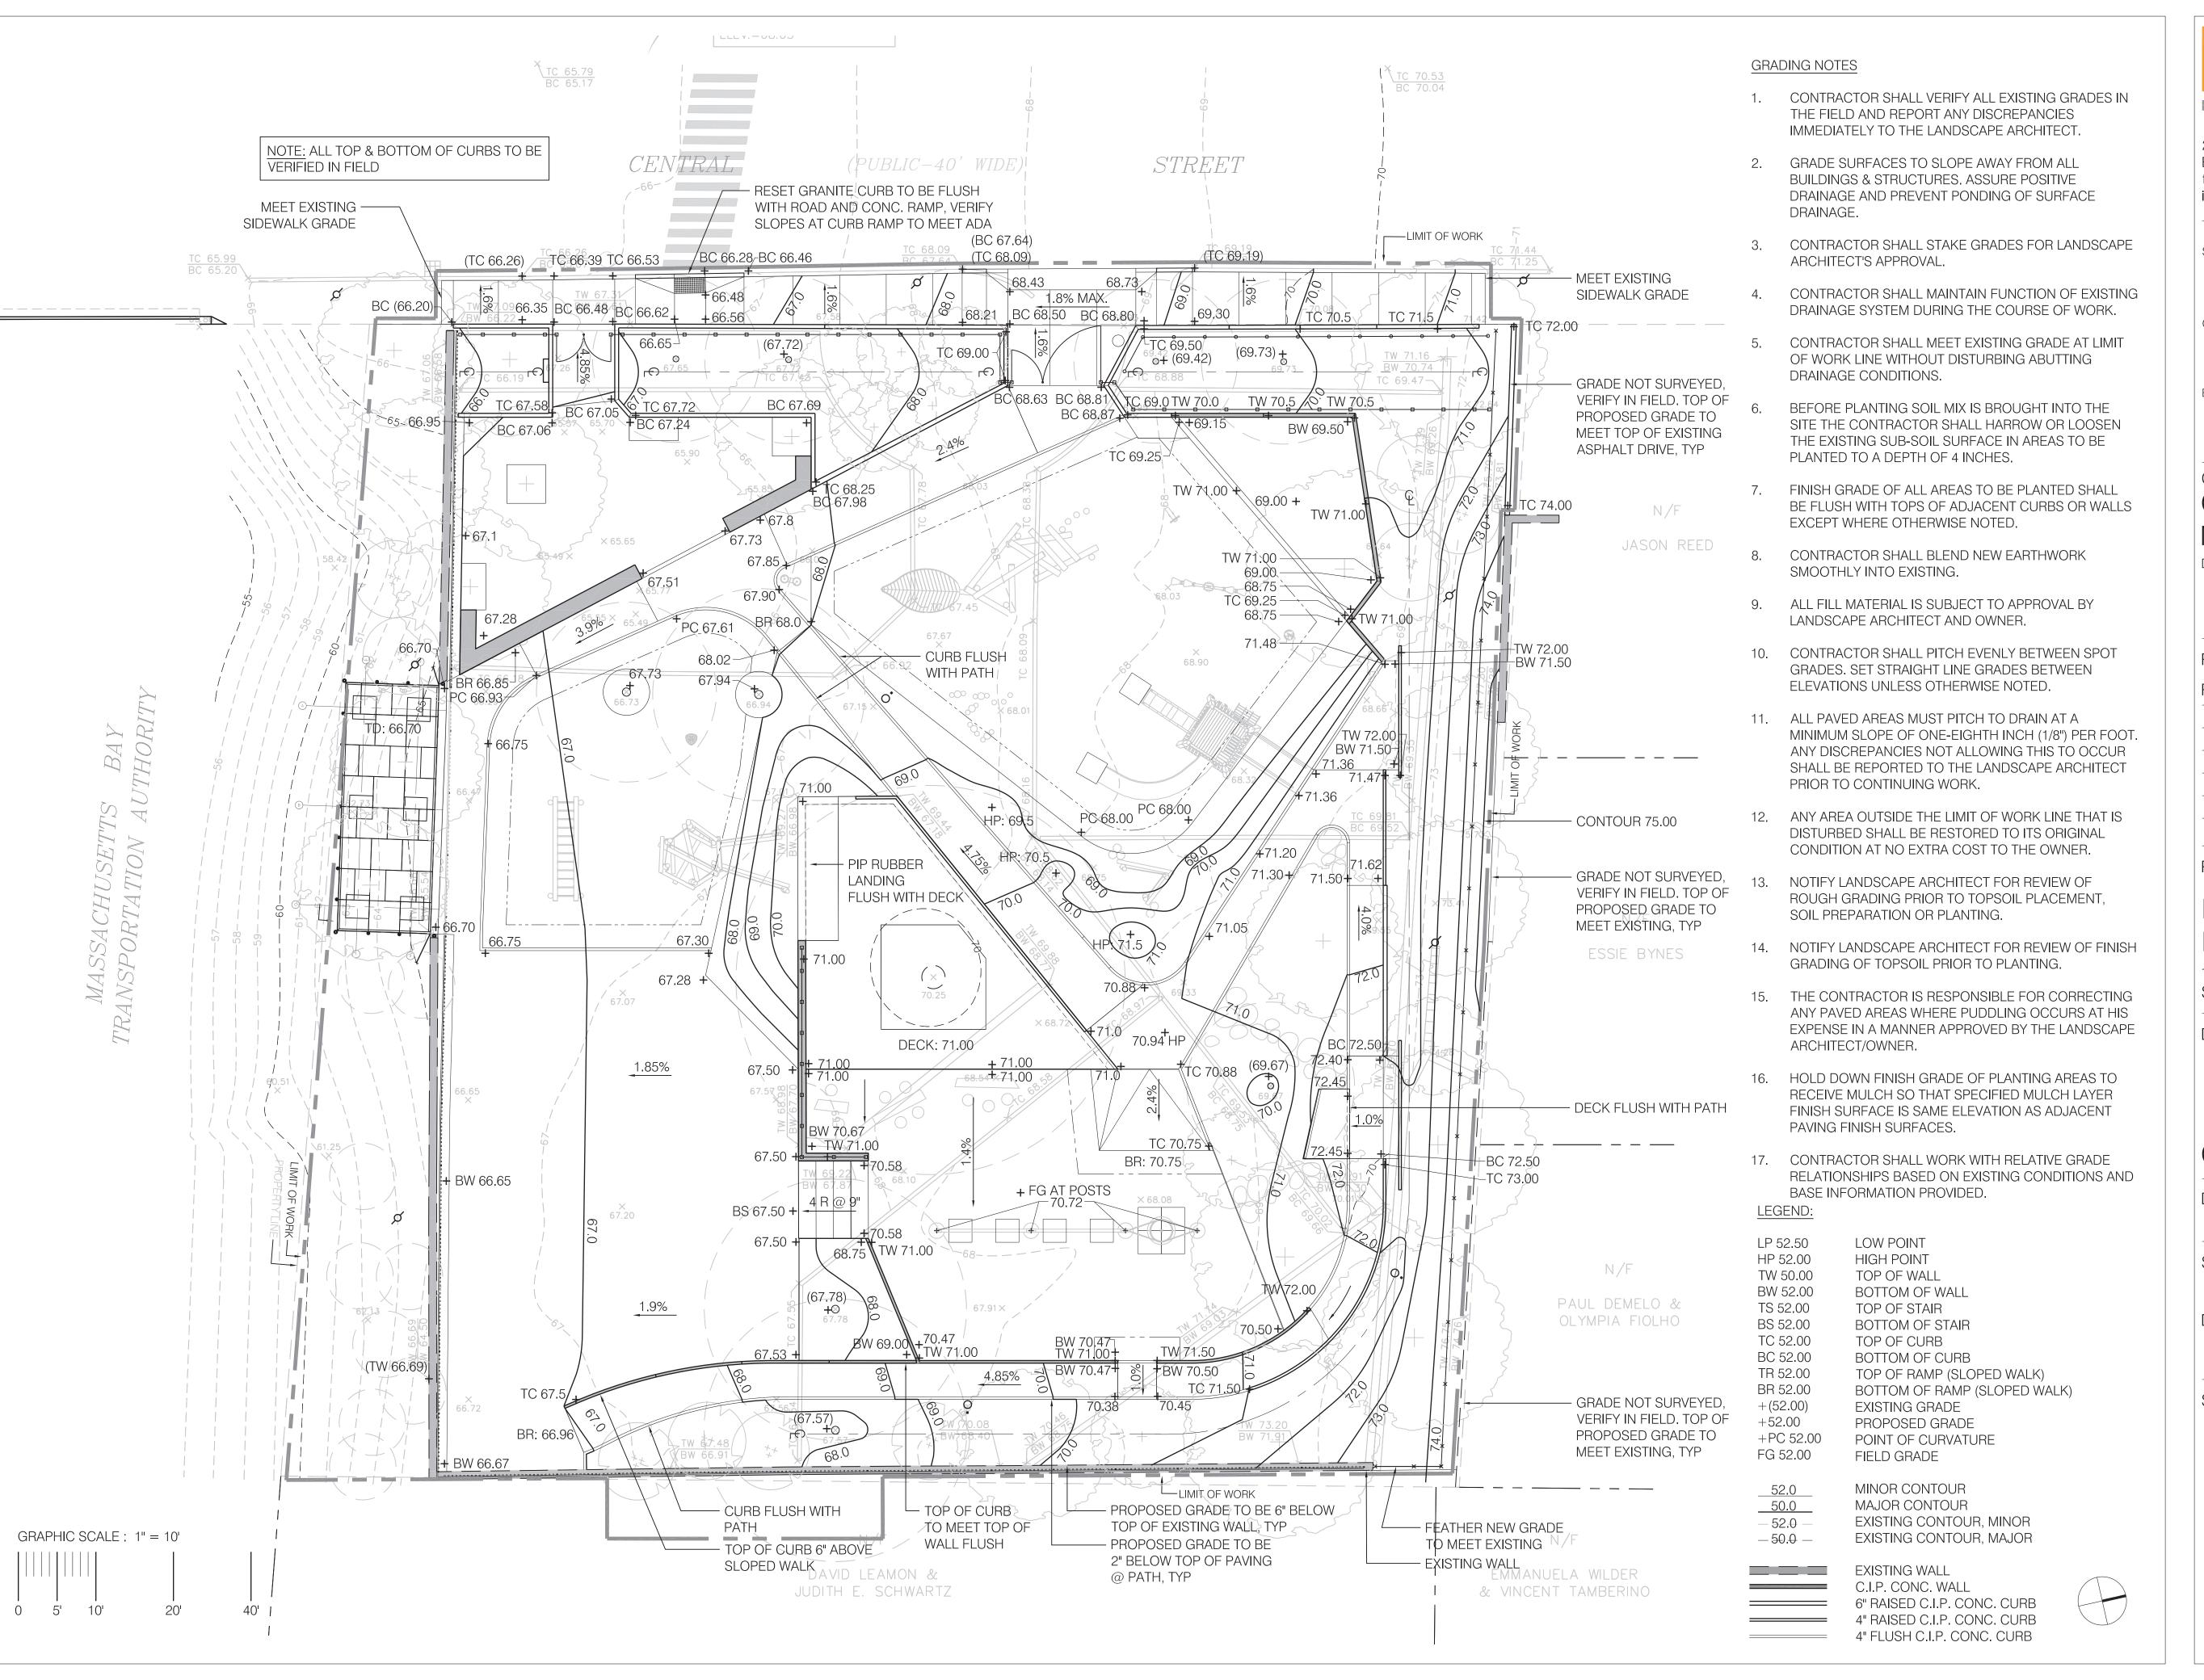GRADING PLAN

DRAWN: REVIEW:
DS SK

SCALE:

1" = 10'-0"

DATE:

16 FEBRUARY 2017

SHEET:



L3.1

PLANTING NOTES:

PLANT SCHEDULE

1,200 sf | Festuca spp.

TREES

AC

AR1

AR2

AR3

BN

GT

LS

LS

QΒ

QC

CAF

CS

FG

HV

IG

RA

RM

VD

FERNS

CP

DP

OS

FN

NW

VINE/ESPALIER

GROUND COVERS QTY

SHRUBS

- 1. ALL PLANT MATERIAL SHALL CONFORM TO THE MINIMUM GUIDELINES ESTABLISHED BY THE AMERICAN STANDARD FOR NURSERY STOCK PUBLISHED BY THE AMERICAN ASSOCIATION OF NURSERYMEN, INC.
- 2. ALL PLANTS TO BE BALLED AND BURLAPPED OR CONTAINER-GROWN UNLESS OTHERWISE NOTED ON PLANT LIST.
- 3. ANY PROPOSED SUBSTITUTIONS OF PLANT SPECIES SHALL BE MADE WITH PLANTS OF EQUIVALENT OVERALL FORM, HEIGHT, BRANCHING HABIT, FLOWER, LEAF, COLOR, FRUIT AND CULTURE ONLY AS APPROVED BY THE OWNER'S REPRESENTATIVE.
- 4. ALL PLANTS SHALL BE TAGGED AND APPROVED BY THE OWNER'S REPRESENTATIVE AT THE NURSERY PRIOR TO DIGGING OR DELIVER TO SITE. CONTRACTOR TO NOTIFY THE OWNER'S REPRESENTATIVE TWO WEEKS IN ADVANCE OF TREE TAGGING TO SCHEDULE.
- 5. CONTRACTOR SHALL LOCATE AND VERIFY ALL EXISTING UTILITY LINE PRIOR TO PLANTING AND SHALL REPORT ANY CONFLICTS TO THE LANDSCAPE ARCHITECT.
- 6. STAKE LOCATION OF ALL PROPOSED PLANTING FOR APPROVAL BY THE LANDSCAPE ARCHITECT PRIOR TO THE COMMENCEMENT OF PLANTING. ALL PLANT LOCATIONS SHALL BE APPROVED BY L.A.
- 7. PLANT MATERIAL SHALL BEAR SAME RELATIONSHIP TO GRADE AS IT BORE TO PREVIOUS GRADE. PLANT MATERIAL SHALL ALSO BE IN THE SAME SOLAR ORIENTATION AS AT NURSERY. MATERIAL SHALL BE TAGGED ON THE NORTH SIDE OF THE PLANT TO FACILITATE PROPER ORIENTATION.
- 8. THE CONTRACTOR SHALL SUPPLY ALL PLANT MATERIAL IN QUANTITIES SUFFICIENT TO COMPLETE THE PLANTING SHOWN ON ALL DRAWINGS.
- 9. ALL PLANTED AREA WITH EXCEPTION OF TREES IN FLEXI-PAVE AND SEED AREAS SHALL RECEIVE SHREDDED BARK MULCH TO COVER ENTIRE BED.
- 10. JUTE FABRIC SHALL BE INSTALLED ON SLOPE STEEPER THAN 2.5:1

2. ALL PLANTS TO BE BALLED A UNLESS OTHERWISE NOTED		R-GROWN,										1 HV 5 RA
WITH PLANTS OF EQUIVALEI	IONS OF PLANT SPECIES SHALL E NT OVERALL FORM, HEIGHT, BRA DR, FRUIT AND CULTURE ONLY AS S REPRESENTATIVE.	NCHING	1 AR3 1 AR2 4 AF 7 OS		AF			4 OS 2 AF 2 BN 5 AF				1 CAF 1 AC 1 CAF 1 GT 2 AC
REPRESENTATIVE AT THE NUTE TO SITE. CONTRACTOR TO N	GED AND APPROVED BY THE OWN JRSERY PRIOR TO DIGGING OR D NOTIFY THE OWNER'S REPRESEN' F TREE TAGGING TO SCHEDULE.	ELIVERY	20 NW 1 AR2 2 GT 2 AC 500 sf FN		9 OS— 4 AF— 56 NW— 3 DP— 4 CP— 1 GT—			3 BN 5 A 2 DP 10 O 2 CP 29 NN 46 NN	S-N-N-N-N-N-N-N-N-N-N-N-N-N-N-N-N-N-N-N		***	4 RA
	TE AND VERIFY ALL EXISTING UTII HALL REPORT ANY CONFLICTS TO		(PL1) 1 LS		6 DP	0.0					***	2 FG —1 CF —1 CS
	ROPOSED PLANTING FOR APPRO'T T PRIOR TO THE COMMENCEMEN TIONS SHALL BE APPROVED BY L	IT OF										
SAME SOLAR ORIENTATION	AR SAME RELATIONSHIP TO GRAD . PLANT MATERIAL SHALL ALSO B AS AT NURSERY. MATERIAL SHAL DE OF THE PLANT TO FACILITATE	E IN THE // L BE /					0, 0,000	8 2				T OF WORK
	UPPLY ALL PLANT MATERIAL IN COMPLETE THE PLANTING SHOV		DD ALT #7									
	(CEPTION OF TREES IN FLEXI-PAV E SHREDDED BARK MULCH TO C								-69-			1 AR1 —1 AM
10. JUTE FABRIC SHALL BE INST	FALLED ON SLOPE STEEPER THAI	N 2.5:1										1 HV 1 AR1 1 CS 14 RA ES
DULE												1 FG 2 CP
BOTANICAL NAME	COMMON NAME	SIZE	REMARKS									1 CF
Amelanchier canadensis	Canadian Serviceberry	7/8` ht. clump B&B			/							2 RA 2 CP
Acer rubrum `Bowhall`	Bowhall Red Maple	2.5-3" cal. B&B			/							
Acer rubrum `Brandywine`	Red Maple	2.5-3" cal. B&B	8' branching height	3 3 3 1 1	/							
Acer rubrum `Red Sunset`	Red Sunset Maple	2.5-3" cal. B&B			/							
Betula nigra	River Birch	1.5-2.5" cal. B&B	single stem only	/	/	· Andrews			1 AR2			
Cornus florida `Appalachian Snow`	Dogwood Appalachian Snow	1.5"/2" cal. B&B	or `Appalachian Spring`	19-				i <u>V</u>	1 CF			
Gleditsia triacanthos inermis `Skyline`	Skyline Thornless Honey Locust	2.5-3" cal. B&B	8' branching height						00 sf FN			
Liquidambar styraciflua	American Sweet Gum	2.5" -3" Cal.										
Liquidambar styraciflua	American Sweet Gum	2.5" -3" Cal.	ADD ALT #7		1 VD— 3 CP—							
Quercus bicolor	Swamp White Oak	3-3.5" cal. B&B	8' branching height	j	17 NW—\\\			[FO3]				
Quercus coccinea	Scarlet Oak	3-3.5" cal. B&B			3 FG—\\\ 2 AC—\\\		3 08	68)	6 RA		0.	
		_			2 CS¬\\ \\		5 OS	/	/ 1 QC 1 CP			
BOTANICAL NAME	COMMON NAME	SIZE	REMARKS		2 CP \\\\\\\\\\\\\\\\\\\\\\\\\\\\\\\\\\\		-27 N → 3 CP	,	1 QC — \ \ — 1 CF			1 POCUL
Aronia melanocarpa	Chokeberry	#3 pot	3` O.C.		~ \ \ \ 1 CAF \ \ \ \		1 CP	,	─	\ \ \ \ \ \ \ \ \ \ \ \ \ \ \ \ \ \ \		4 RAYMF 2 IG
Calycanthus floridus	Sweet Shrub	#3 pot	3` O.C.				(+) · N VAIT-		2 IG			1 RM
Cornus sericea	Red Twig Dogwood	#3 pot	3` O.C.									80 NW 1 CP
Fothergilla gardenii	Dwarf Fothergilla	#3 pot	3` O.C.			A COLOR		(+) (+)	+		+ 1	1 QC 1 IG
Hamamelis vernalis	Spring Blooming Witchhazel	#7 pot	8` O.C. 3` O.C.			13 + 25				- 1		— 1 G — 4 RM
Ilex glabra Rhus aromatica `Gro-Low`	Inkberry Holly Gro-Low Fragrant Sumac	24/30" B&B #2 pot	24" O.C.			***			+ + +		<u>/</u>	
Rhododendron maximum	Rose Bay	5-6` B&B	8` O.C.		N							
Viburnum dentatum	Viburnum	3-4` B&B	8` O.C.					1 AC	LIMT OF W	/UHK		
Viburnum lentago	Nannyberry	3-4` B&B	8` O.C.				IN/	1 LS— 1 CV— 4 CV				N/F
BOTANICAL NAME	COMMON NAME	SIZE	REMARKS	. = 0 = : : =				3 CV—			I E	MMANUELA WI
Athyrium filix-femina	Common Lady Fern	#1	2` O.C., ADD ALT #3	LEGEND		6	_					
Comptonia peregrina	Sweet Fern	#1	2` O.C., ADD ALT #3	(PL1)	NO MOW SEED MIX	$ \begin{pmatrix} 6 \\ L6.9 \end{pmatrix} $	TREE PLANT	/				
Dennstaedtia punctilobula	Hay-scented Fern	#1	2` O.C., ADD ALT #3				$\left(\begin{array}{c}+\end{array}\right)$	CAL L6.8				
Onoclea sensibilis	Sensitive Fern	#1	2` O.C., ADD ALT #3	* * * * * * * * * * * * * * * * * * *	BULB PLANTING, ADD ALT #3	5 L6.9	IN SAI	ND (5) L6.8				
BOTANICAL NAME	COMMON NAME	SIZE	REMARKS	⊕ (+)	PERENNIAL PLANTIN	NG, $\frac{4}{L6.9}$		6				
Clematis virginiana	Woodbine	#1	15` O.C., ADD ALT #3		ADD ALT #3		ON SI	L6.8		GRAPHIC SCALE: 1" =	= 10'	
DOT:::::-	001111011111	0	DELCO SE	+ +	SHRUB PLANTING	$ \begin{pmatrix} 2 \\ L6.9 \end{pmatrix} \begin{pmatrix} 3 \\ L6.9 \end{pmatrix} $	IN FLE	EXIBLE POROUS PAVEMI	ENT $\left(\frac{4}{16.8}\right)$			
BOTANICAL NAME	COMMON NAME	SIZE	REMARKS	\bigcap_{α}		10.0			L6.8/			
sf Festuca spp.	No Mow	seed	101000 1000	(**)	MULTI-STEM	$\begin{pmatrix} 1 \\ 160 \end{pmatrix}$					201 421	
Narcissus x `White Mixture`	White Daffodil	bulb	12" O.C., ADD ALT #3		TREE PLANTING	L6.9				0 5' 10'	20' 40'	



—LIMIT OF WORK

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REVISIONS:

REV DATE NOTE

PROJECT: KMDG #1604

HOYT SULLIVAN PLAYGROUND

117 CENTRAL STREET SOMERVILLE, MA 02145

DRAWING:

PLANTING PLAN

REVIEW: DRAWN:

EΗ SK

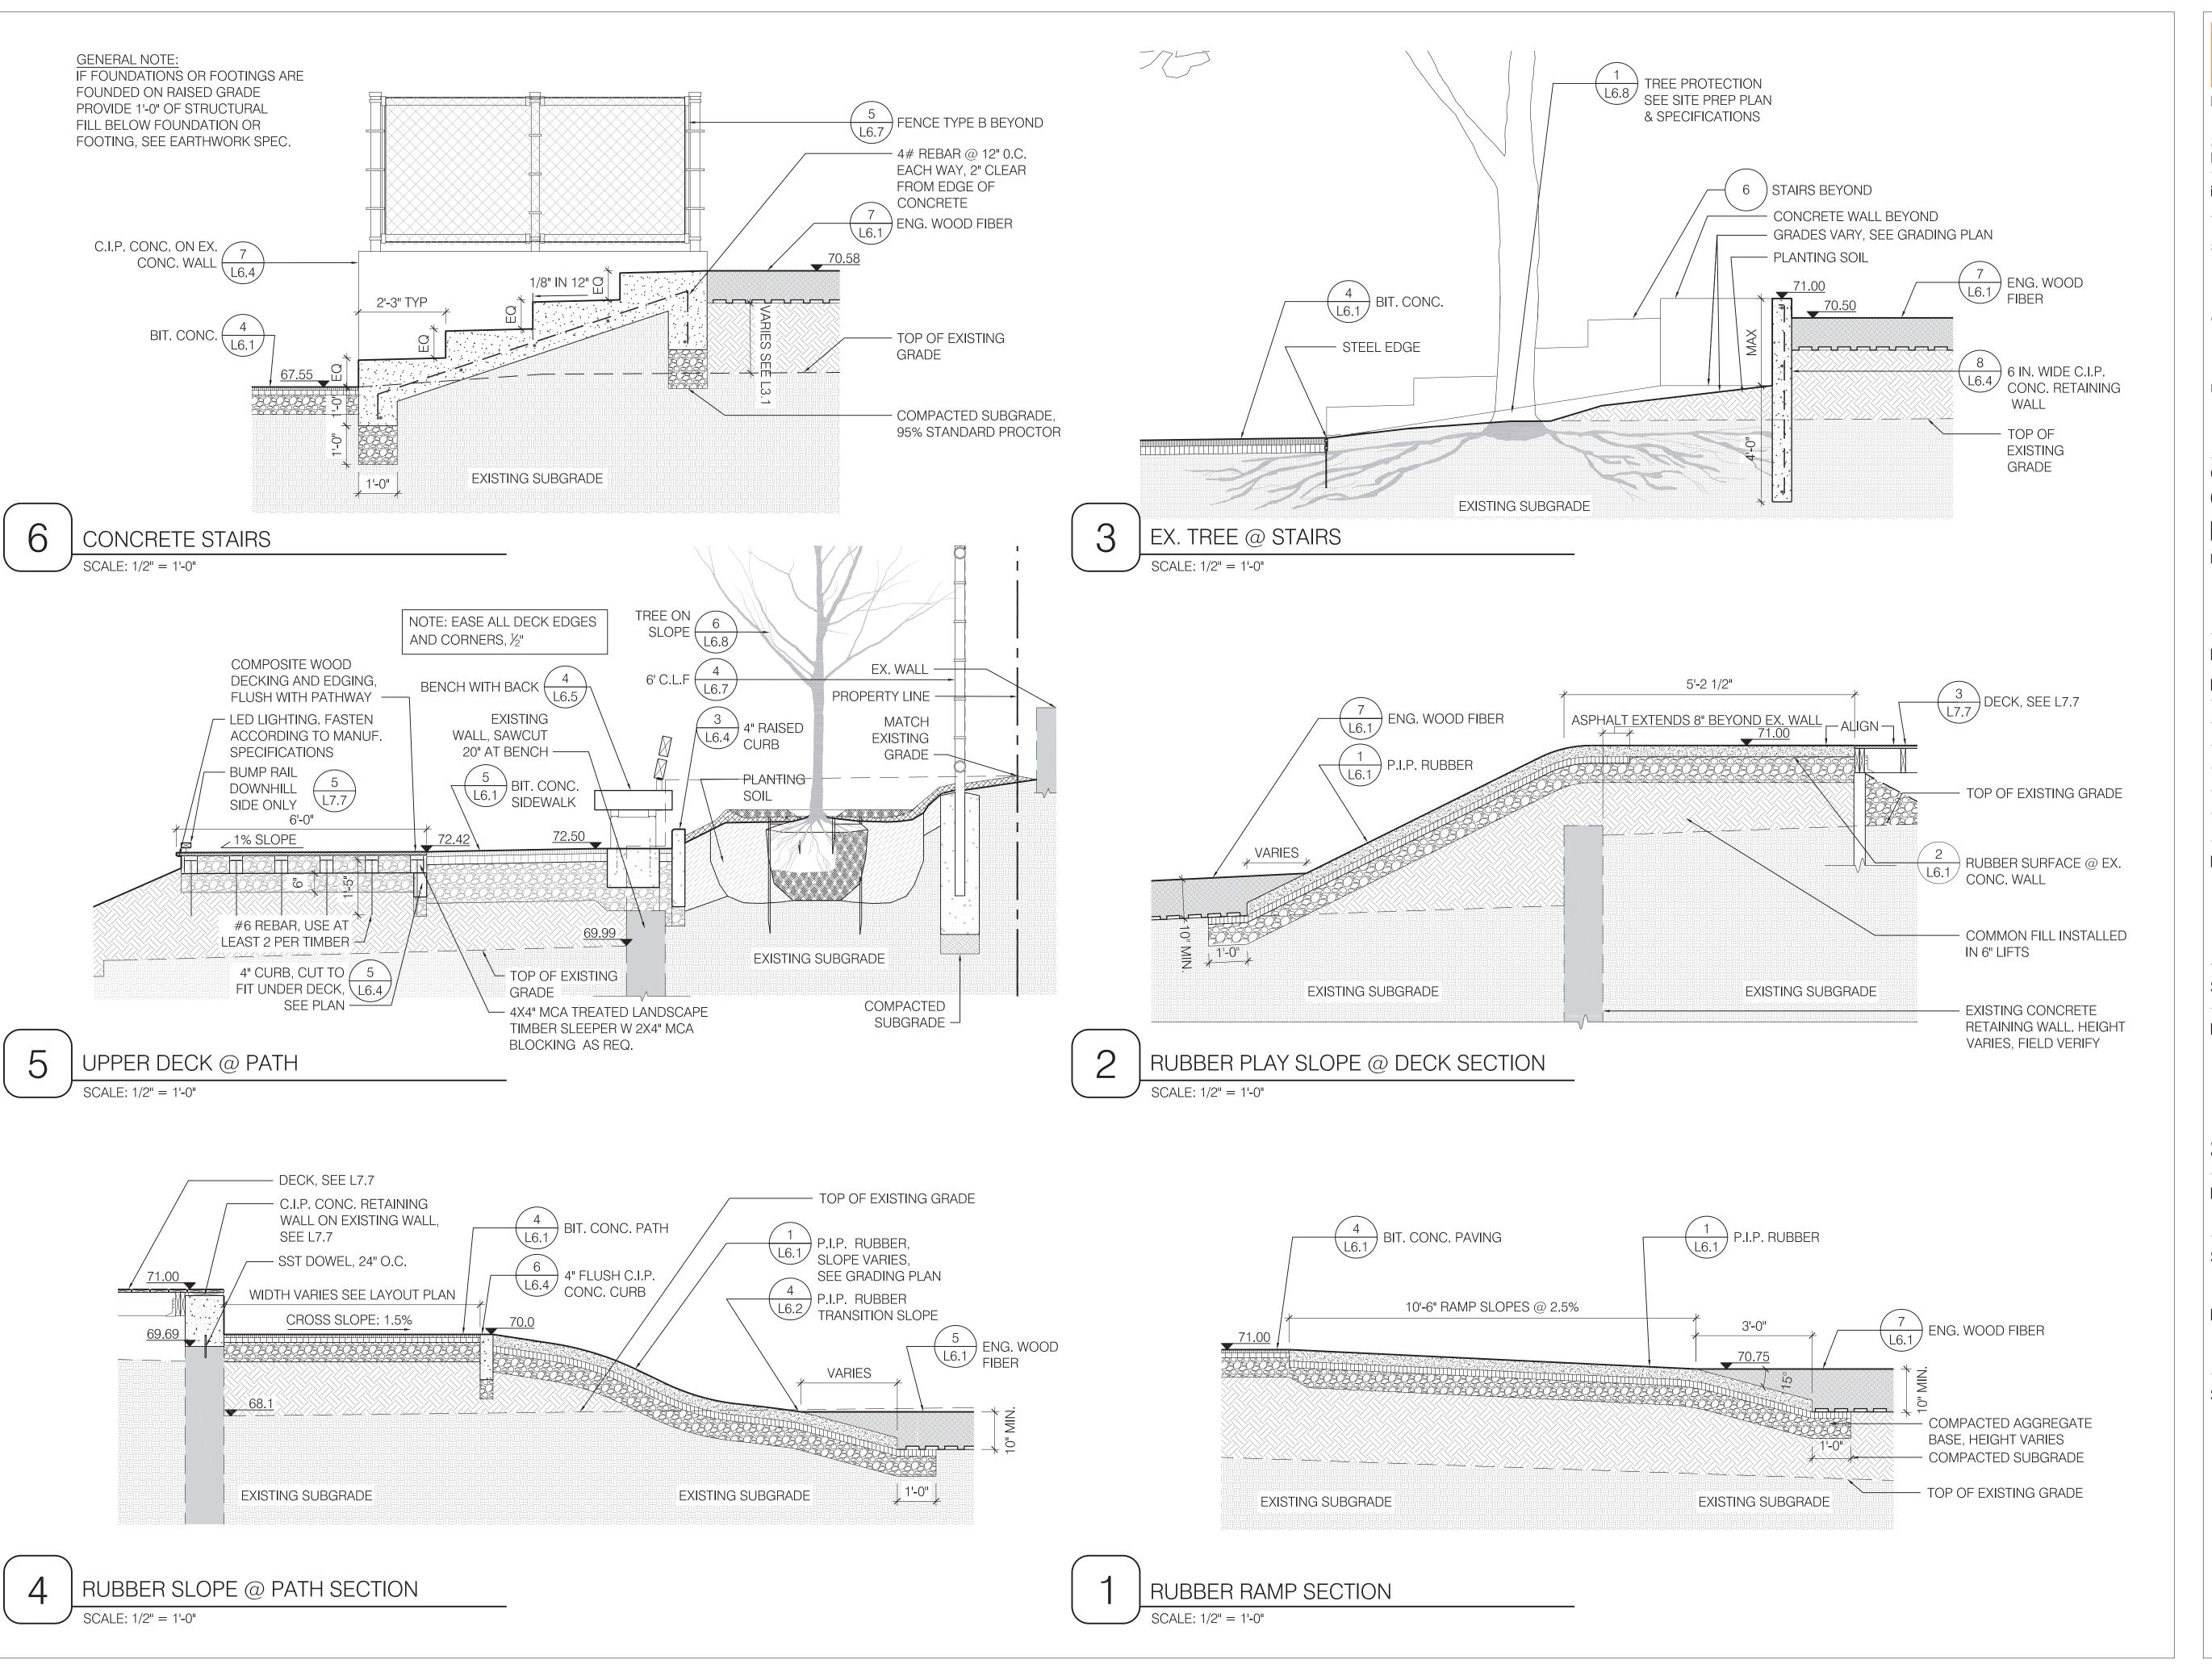
SCALE:

1" = 10'-0"

DATE:

16 FEBRUARY 2017





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REVISIONS:

REV DATE NOTE

PROJECT: KMDG #1604

HOYT SULLIVAN **PLAYGROUND**

117 CENTRAL STREET SOMERVILLE, MA 02145

DRAWING:

SECTIONS

DRAWN: REVIEW: DS/EH SK

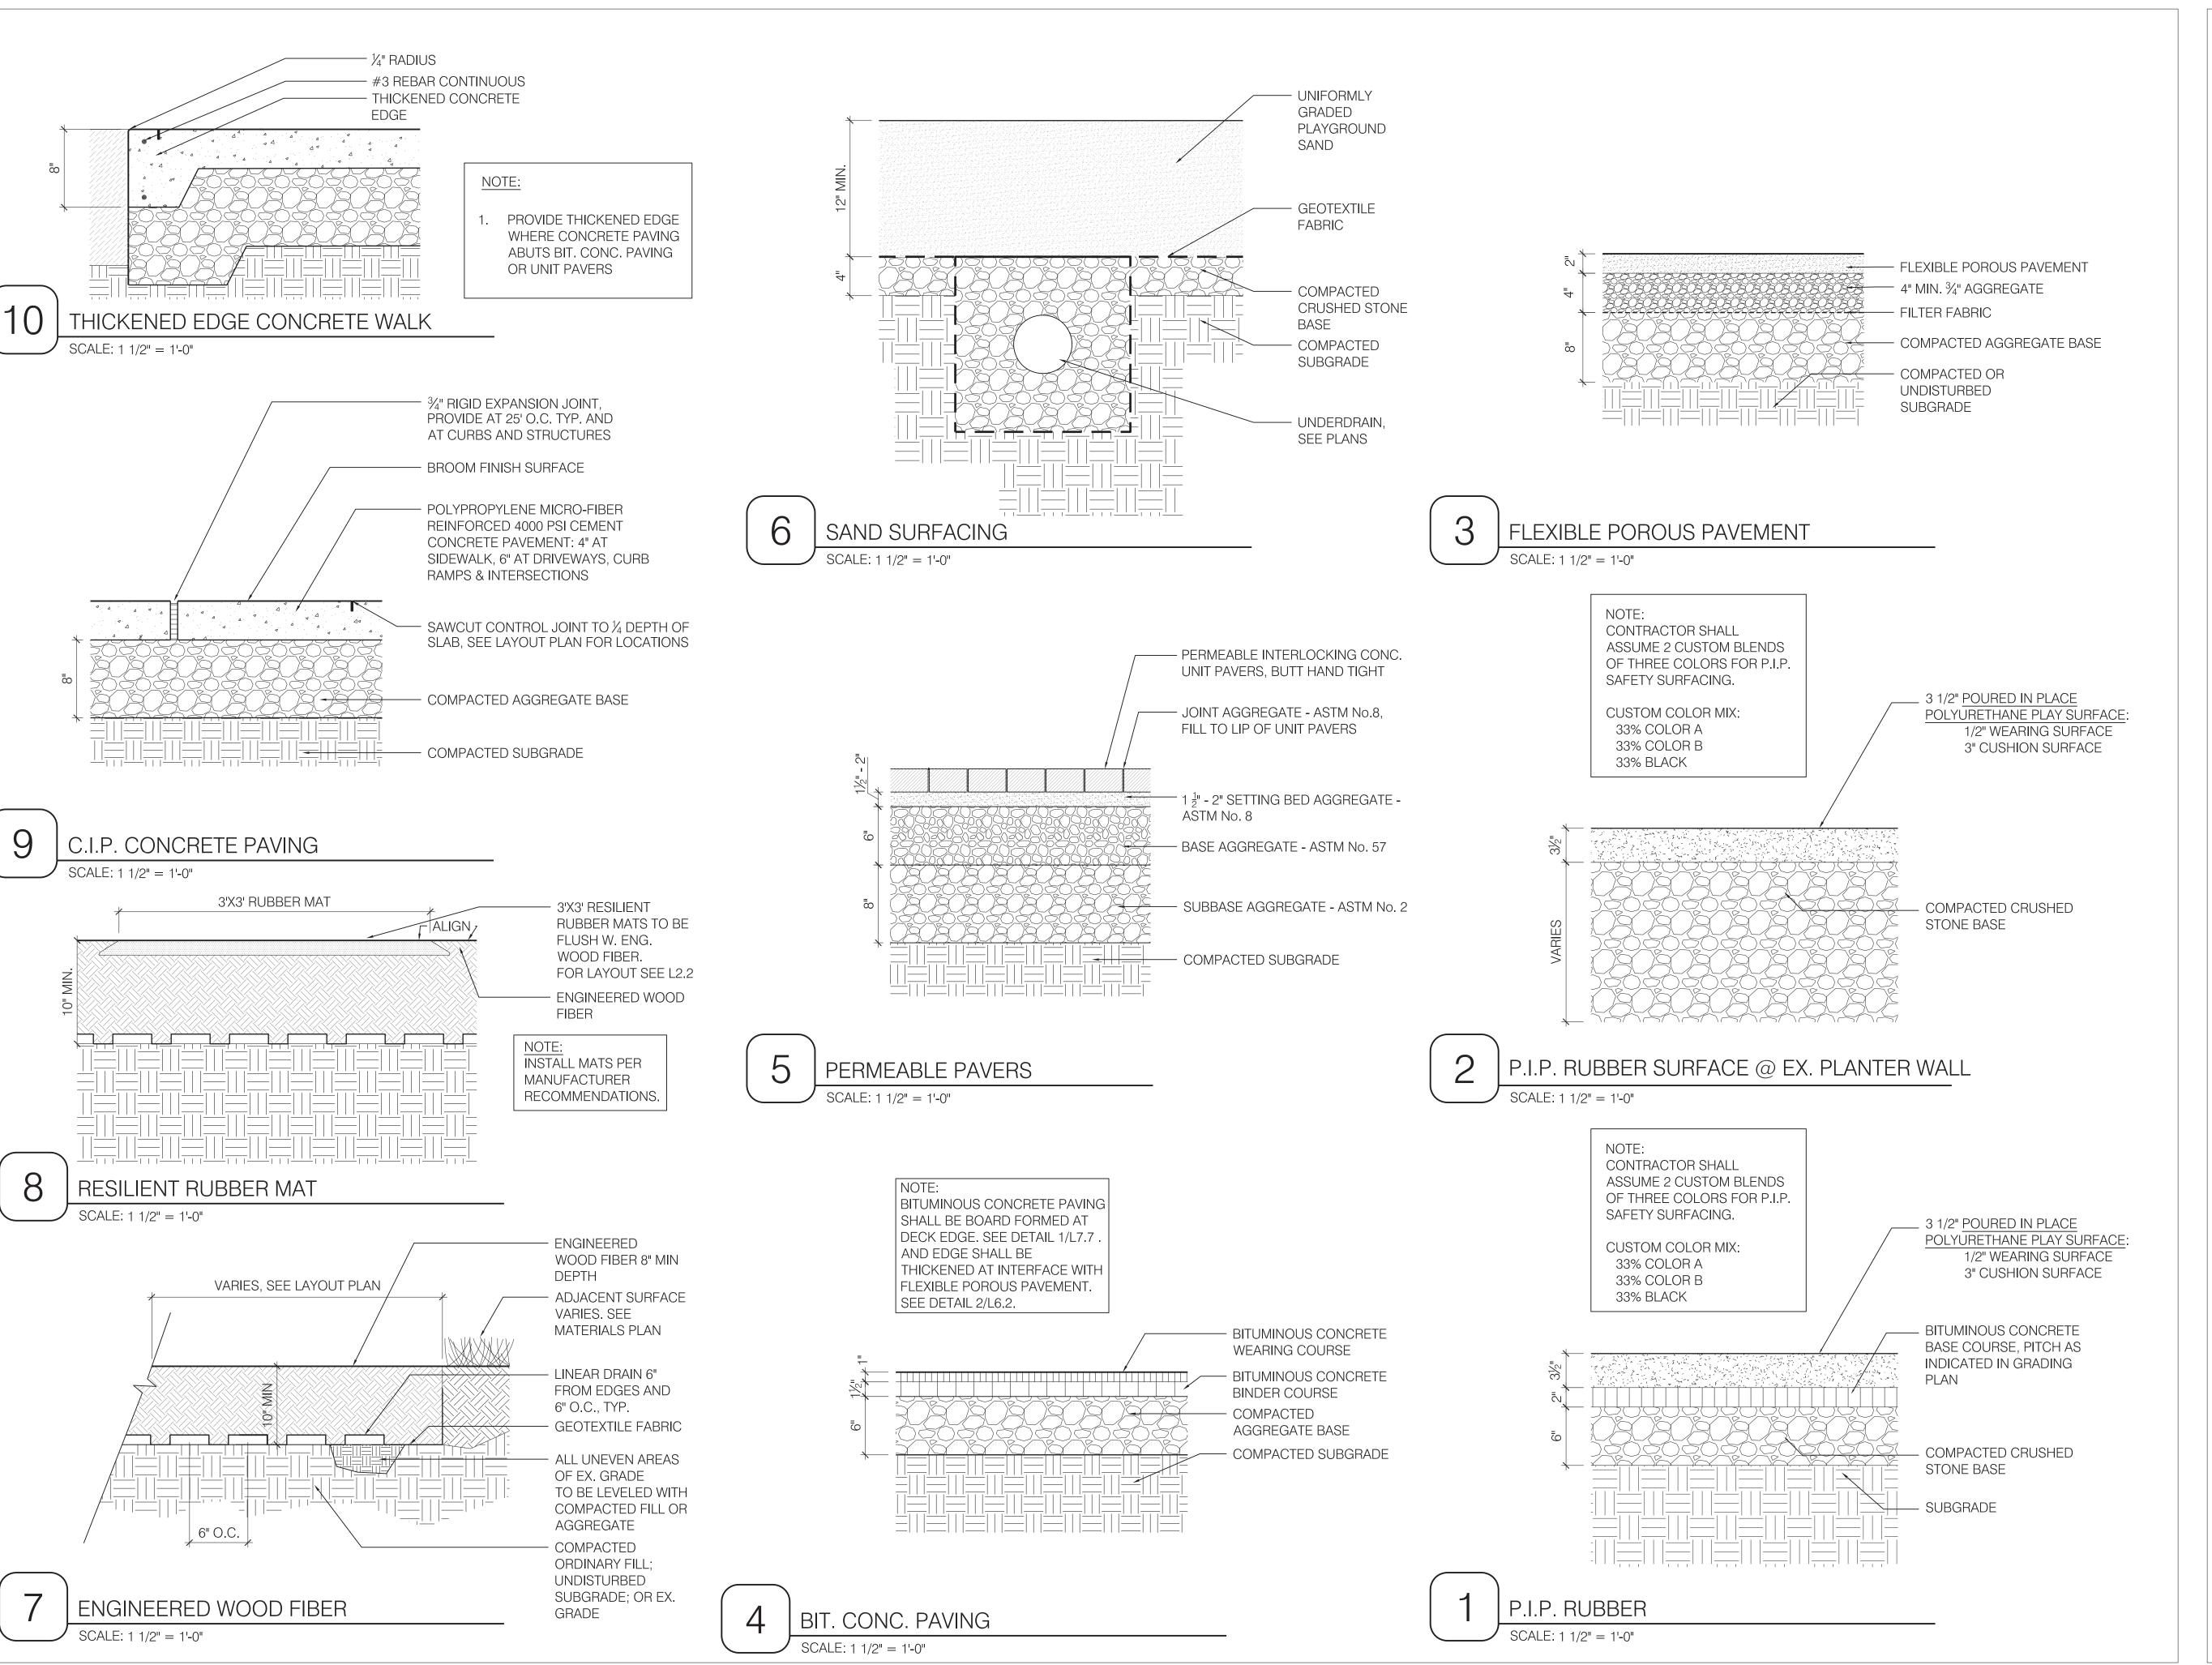
SCALE:

AS NOTED

DATE

16 FEBRUARY 2017





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REV DATE NOTE

PROJECT: KMDG #1604

HOYT SULLIVAN PLAYGROUND

117 CENTRAL STREET SOMERVILLE, MA 02145

DRAWING:

PAVING DETAILS

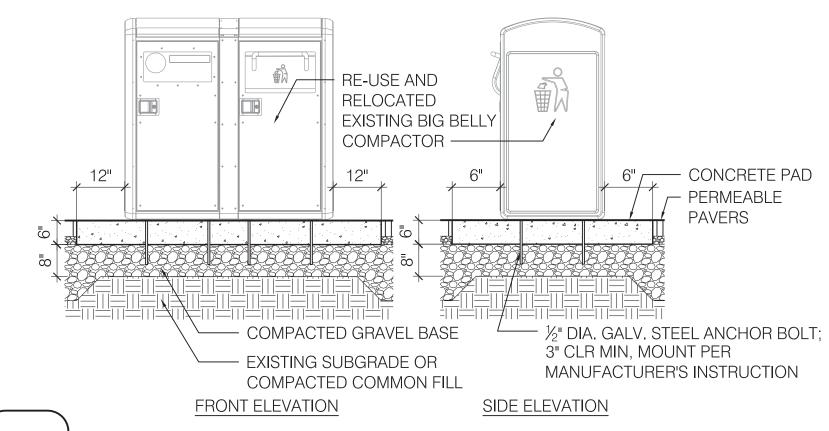
REVIEW: DRAWN: DS

SCALE: AS NOTED

DATE:

16 FEBRUARY 2017






P.I.P. RUBBER TRANSTION SLOPE @ BIT. CONC. SCALE: 1" = 1'-0"


-) BIT. CONC. PAVING

RE-USE EXISTING BIG BELLY COMPACTOR SCALE: 1/2" = 1'-0"


SEE SPECIFICATION FOR ANCHORING RECEPTACLE IN ASPHALT. 3/8 x 1 STEEL SLATS RECYCLE LID 5/8" DIA. STEEL ROD 1-1/2 x 3/8 STEEL BAR 38

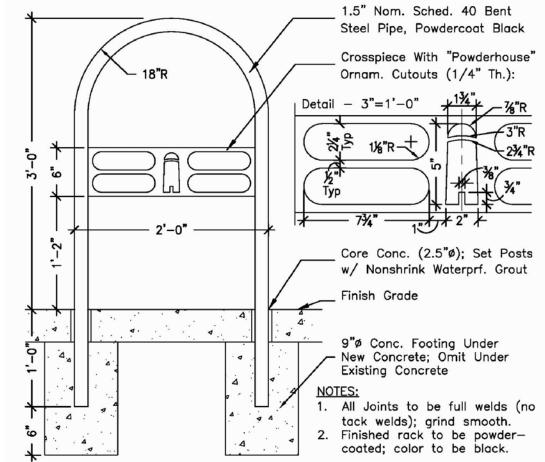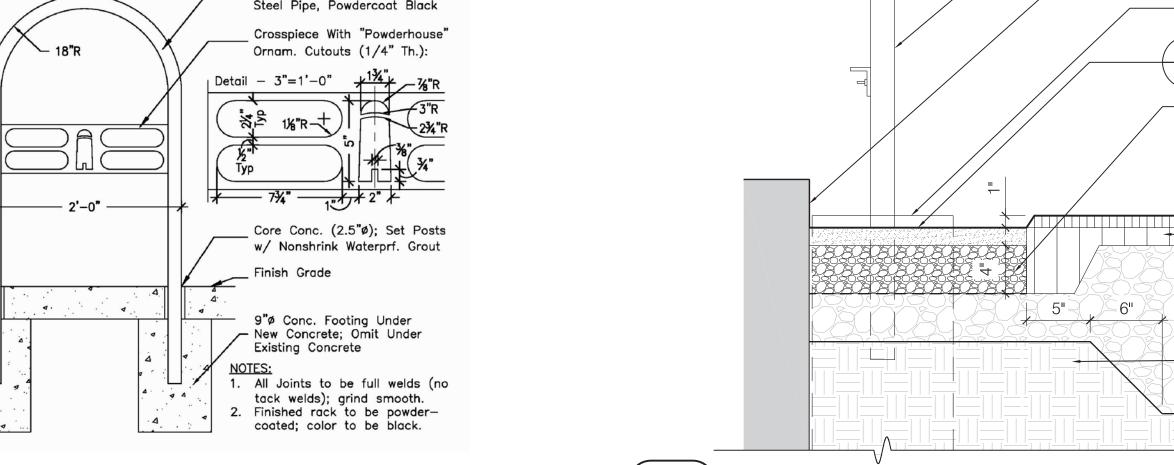
> **BIKE RACK** SCALE: 1" = 1'-0"






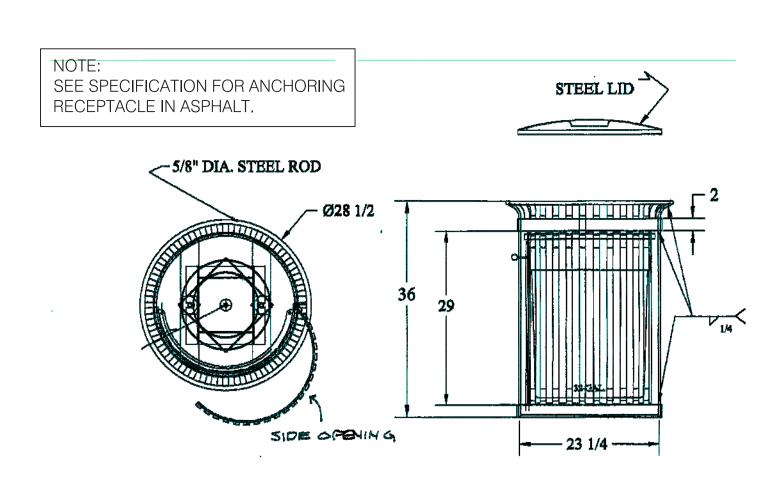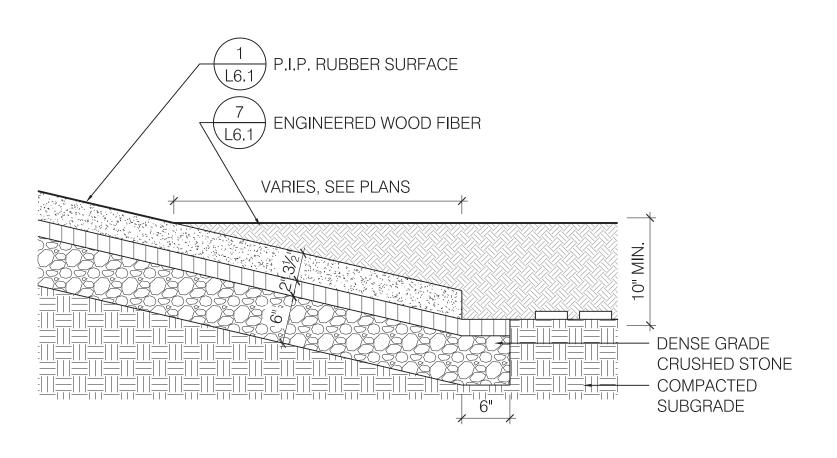FLEXIBLE POROUS PAVEMENT @ EX. WALL & BIT. CONC. PATH SCALE: 1 1/2" = 1'-0"





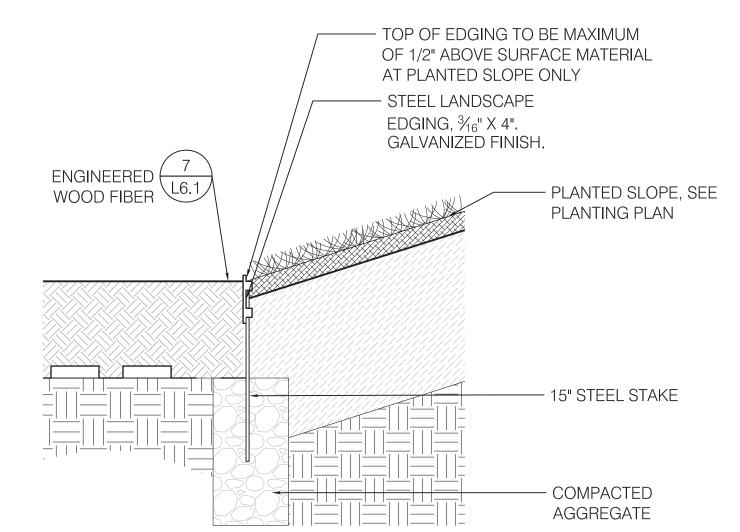P.I.P. RUBBER TRANSITION SLOPE @ RUBBER SLOPE SCALE: 1 1/2" = 1'-0" SCALE: 1" = 1'-0"



STEEL EDGING - ENG. WOOD FIBER @ PLANTED SLOPE



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4" FLUSH C.I.P CONC. CURB

ENGINEERED WOOD FIBER

┌─ DRY WELL RIM

- EX. STEEL PICKET POST TO REMAIN

EX. CONC. WALL TO REMAIN

FLEXIBLE POROUS PAVEMENT

- STABILIZED SUB BASE

- EXISITNG SUBGRADE

3/4" CRUSHED AGGREGATE

EX. CONC. FOOTER TO REMAIN (BEYOND)

1 P.I.P. RUBBER SURFACE

3'-0"

DRY WELL RISER.

DRAWINGS FOR

SEE CIVIL

DETAIL

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REVISIONS:

REV DATE NOTE

PROJECT: KMDG #1604

HOYT SULLIVAN PLAYGROUND

117 CENTRAL STREET SOMERVILLE, MA 02145

DRAWING:

PARK DETAILS 1

REVIEW: DRAWN: DS/EH

SCALE: AS NOTED

DATE:

16 FEBRUARY 2017

SHEET:



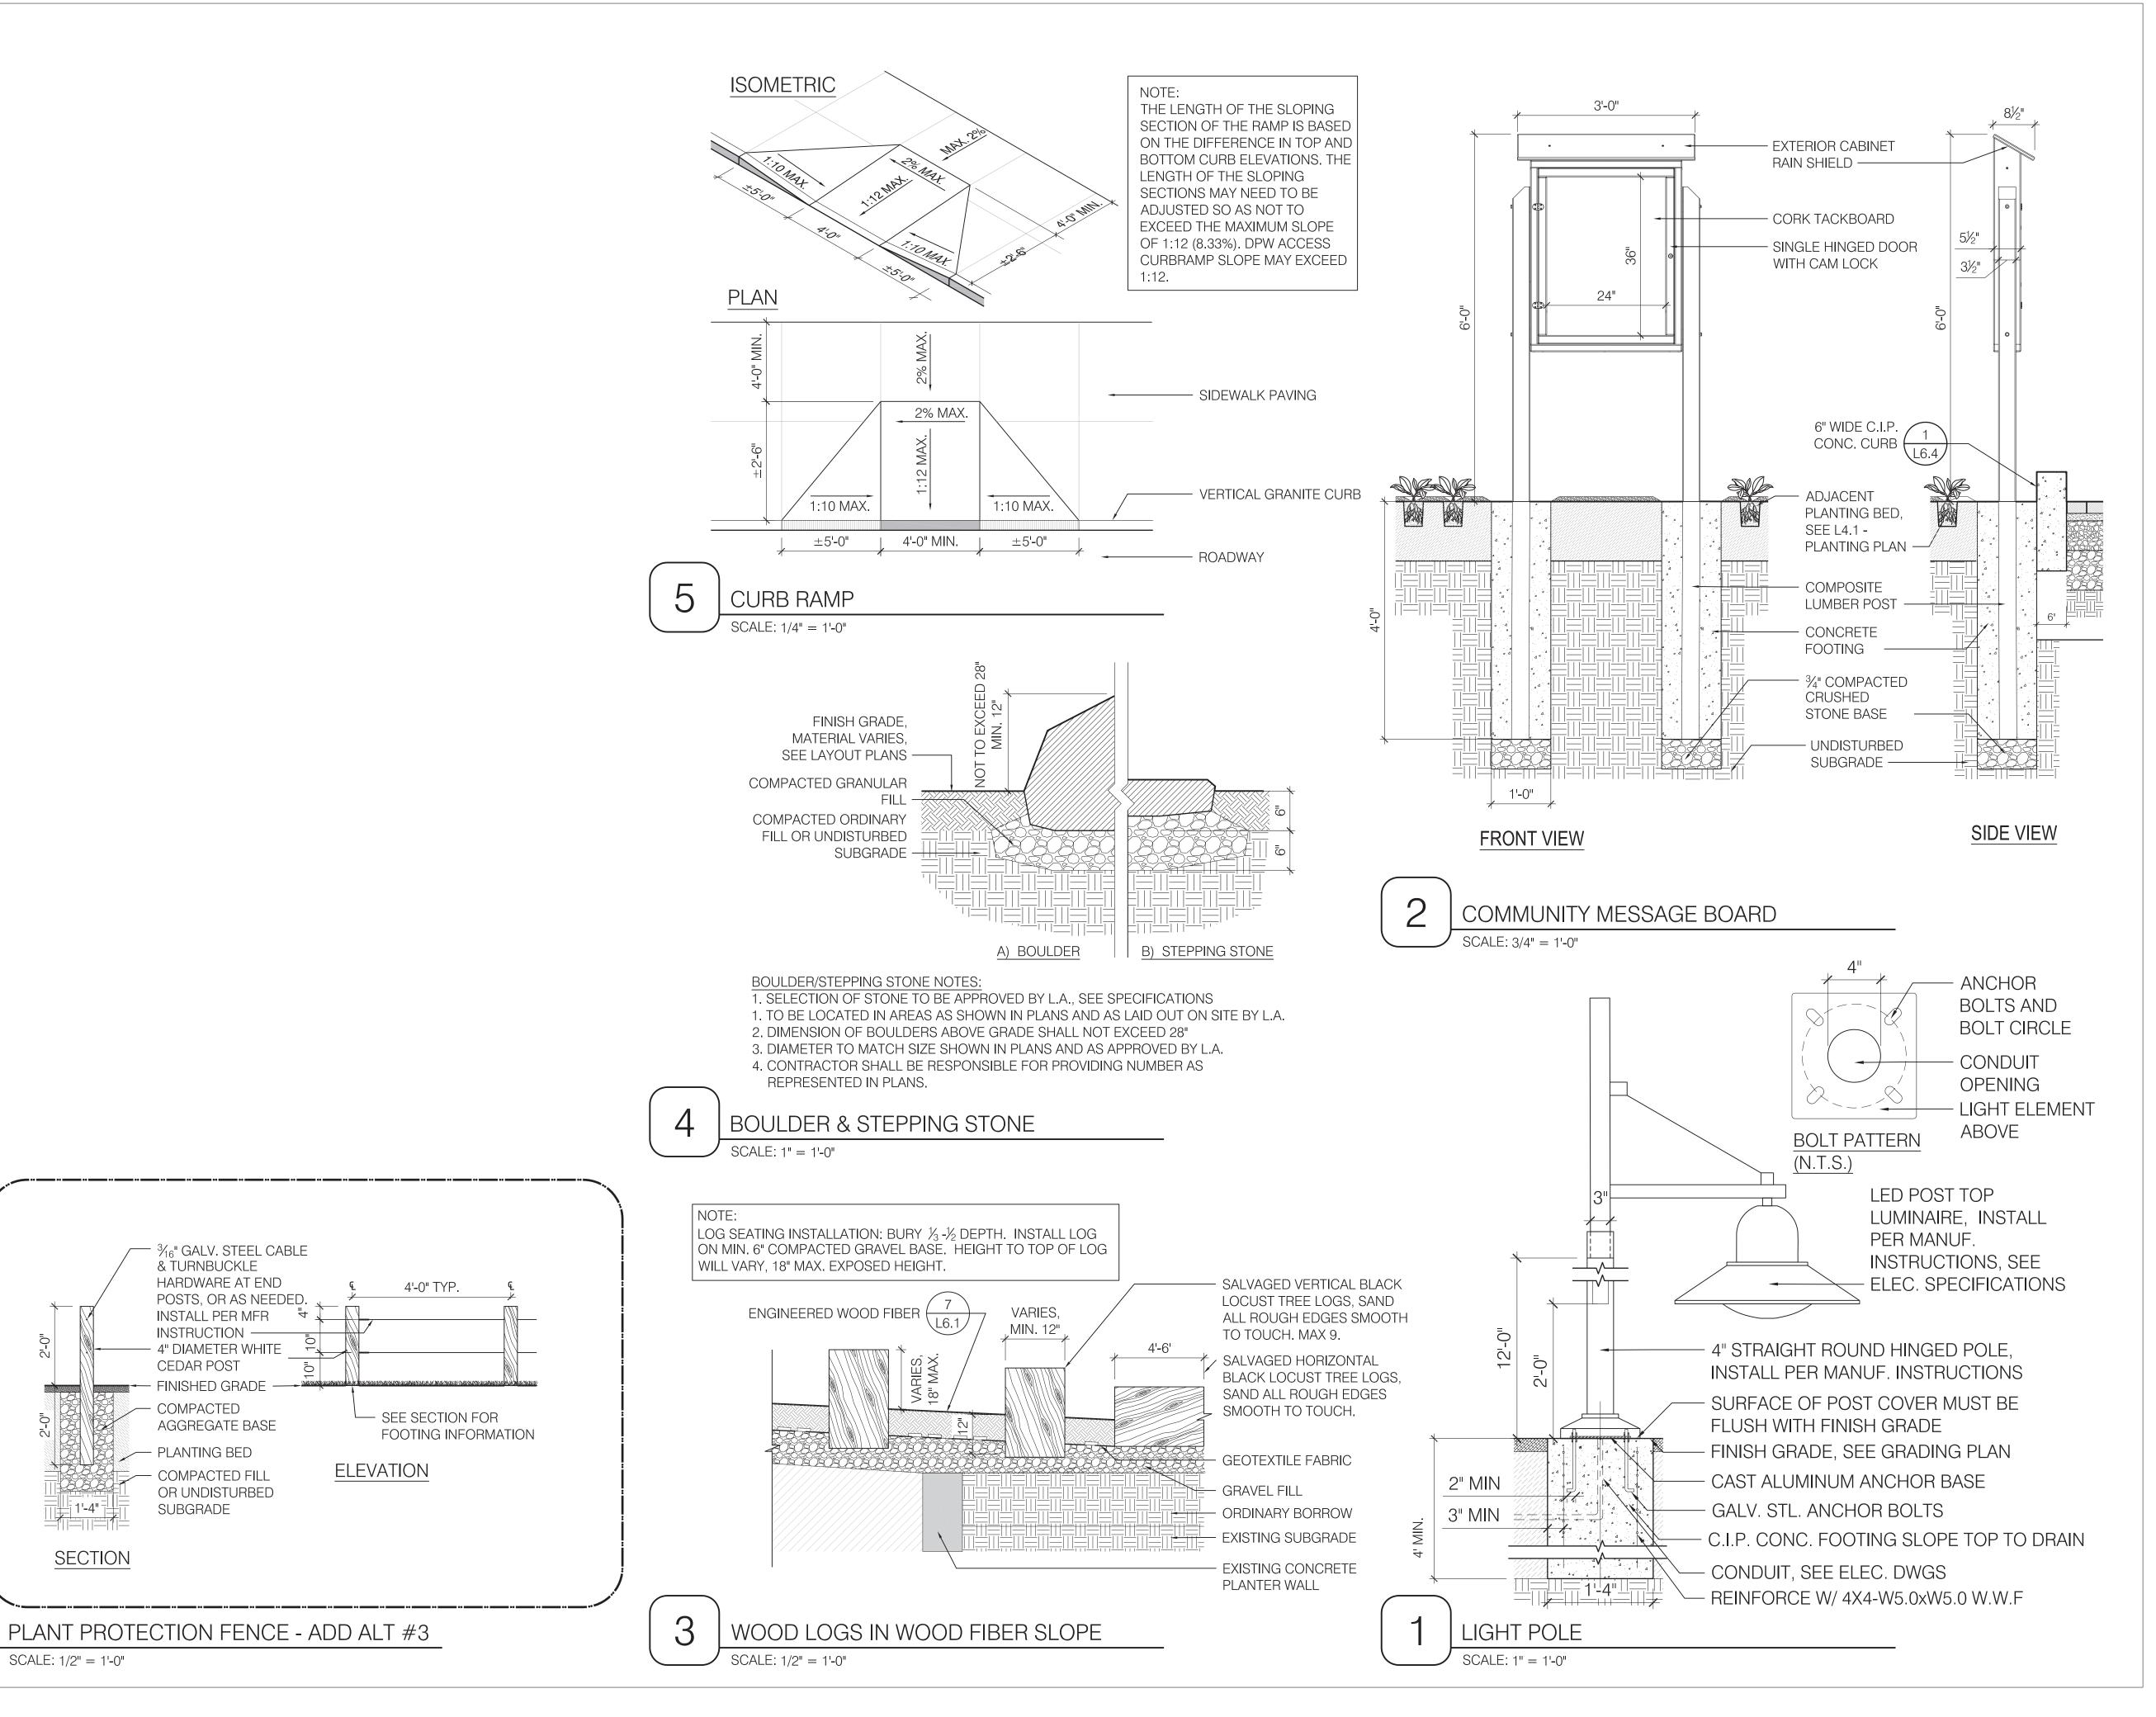


STEEL BARREL TRASH WITH DOOR

STEEL BARREL RECYCLING WITH DOOR

SCALE: 3/4" = 1'-0"

SCALE: 3/4" = 1'-0"



6

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117 CENTRAL STREET SOMERVILLE. MA 02145

DRAWING:

PARK DETAILS 2


DRAWN: REVIEW: DS/DC

| SCALE: AS NOTED

DATE:

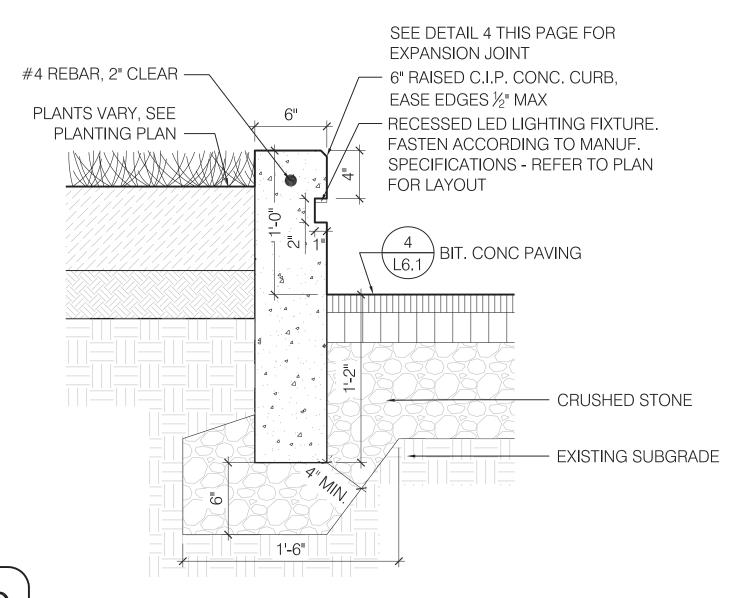
16 FEBRUARY 2017






C.I.P. CONC. CURB WITH RECESSED TAPE LIGHT FIXTURE

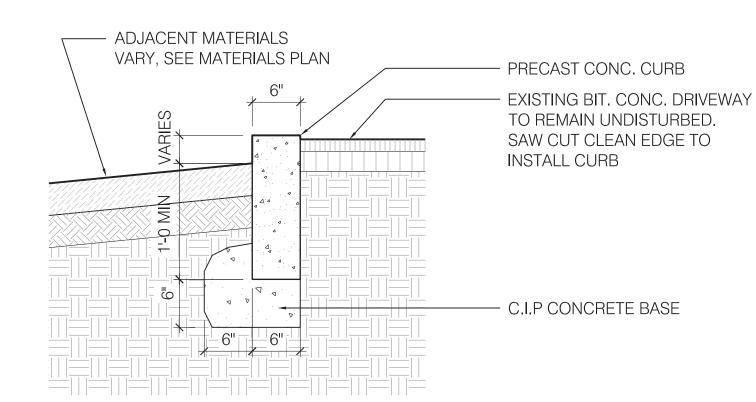SCALE: 1 1/2" = 1'-0"




(9) 6 IN. WIDE PRECAST CONC. CURB

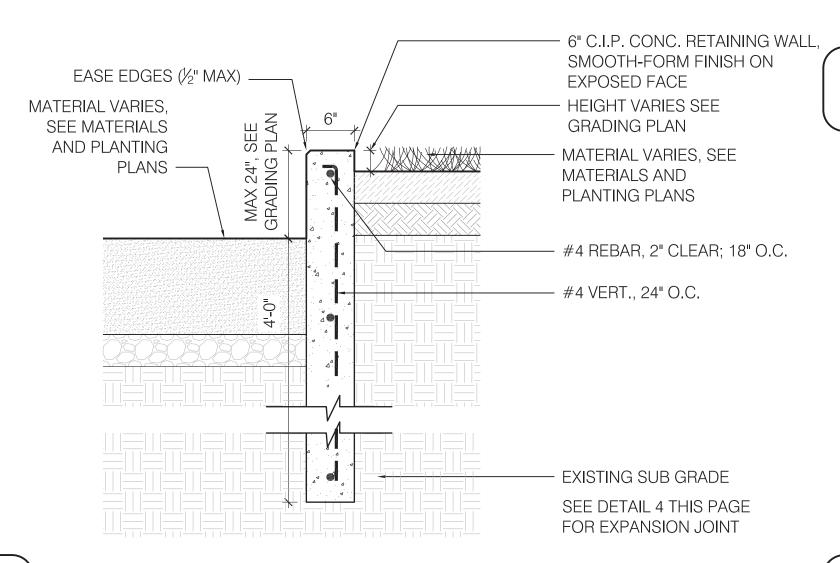SCALE: 1" = 1'-0"




8 6 IN. WIDE C.I.P. CONC. RETAINING WALL

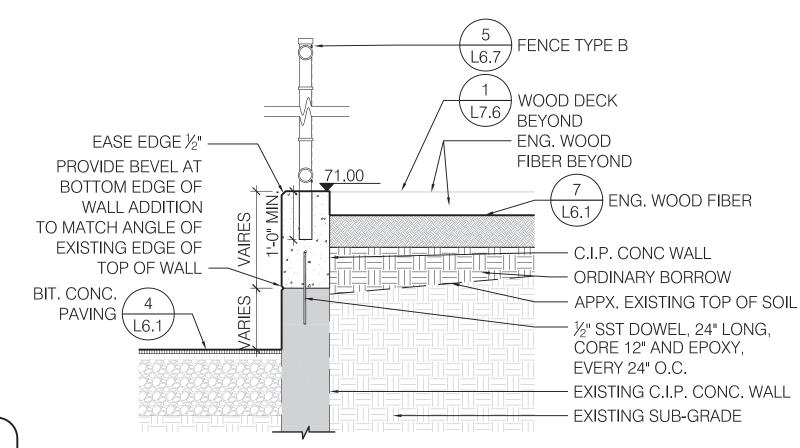SCALE: 1" = 1'-0"




7 C.I.P. CONC. WALL ON EX. CONC. WALL

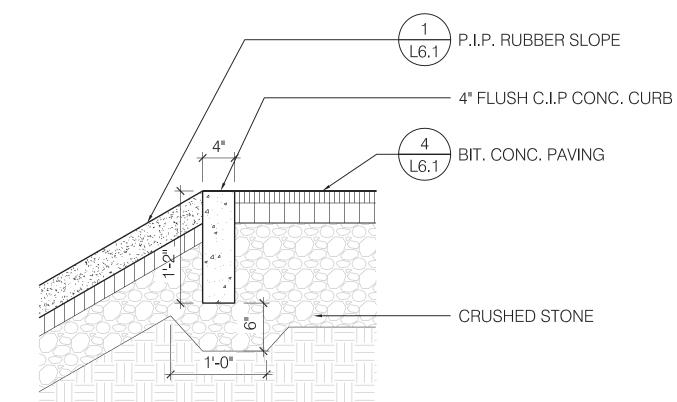SCALE: 1/2" = 1'-0"




4 IN. WIDE FLUSH C.I.P. CONC. CURB @ RUBBER SLOPE

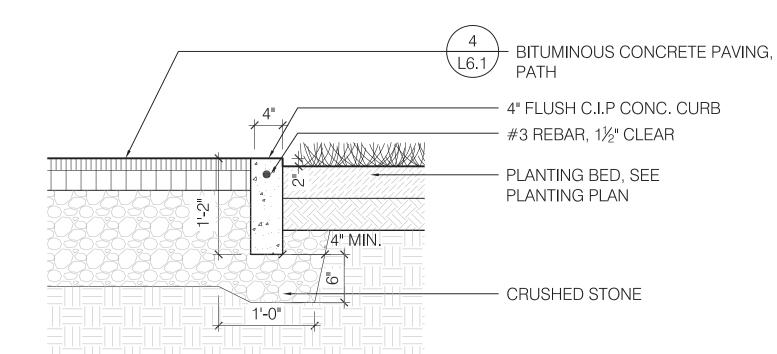SCALE: 1" = 1'-0"




4 IN. WIDE FLUSH C.I.P. CONC. CURB

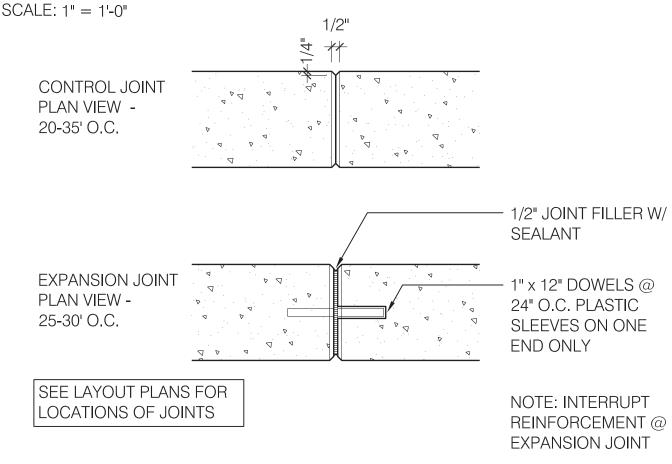


CONTROL AND EXPANSION JOINTS

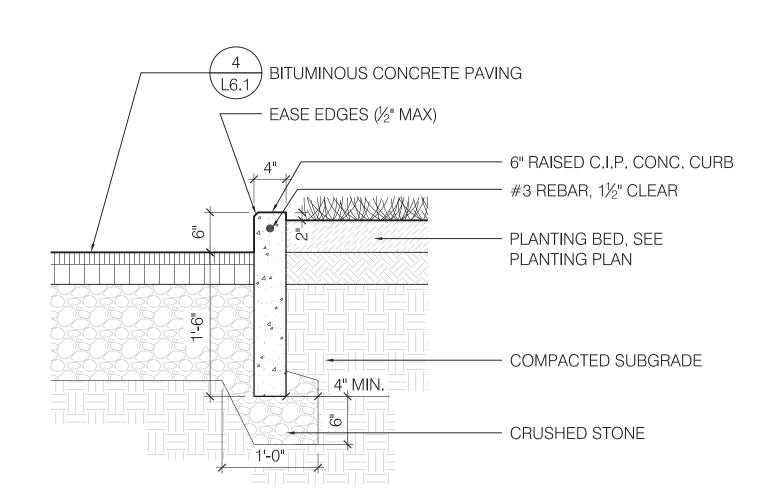SCALE: 1" = 1'-0"




4 IN. WIDE RAISED C.I.P. CONC. CURB @ PLANTING

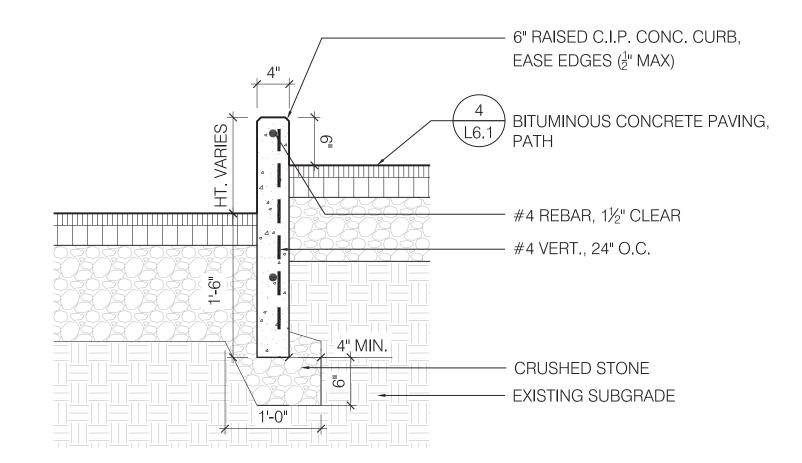SCALE: 1" = 1'-0"



4 IN. WIDE RAISED C.I.P. CONC. CURB - HEIGHT VARIES

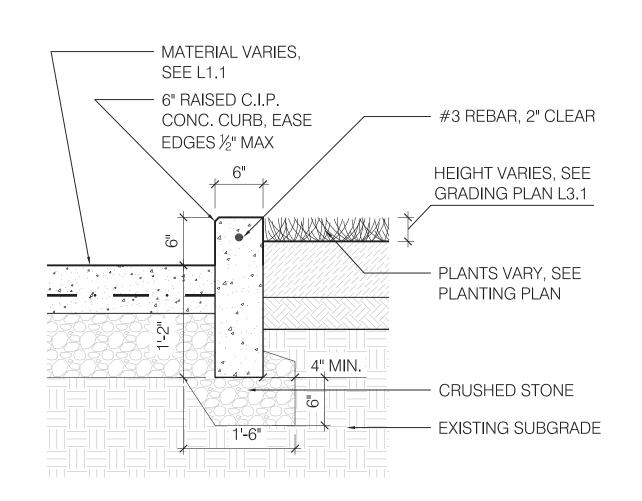SCALE: 1" = 1'-0"



6 IN. WIDE RAISED C.I.P. CONC. CURB

SCALE: 1" = 1'-0"



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REVISIONS:

	REV	DATE	NOTE
ı			

PROJECT: KMDG #1604

HOYT SULLIVAN PLAYGROUND

117 CENTRAL STREET SOMERVILLE, MA 02145

DRAWING:

WALL & CURB DETAILS

DRAWN: REVIEW: SK

SCALE:

AS NOTED


DATE:

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SHEET:



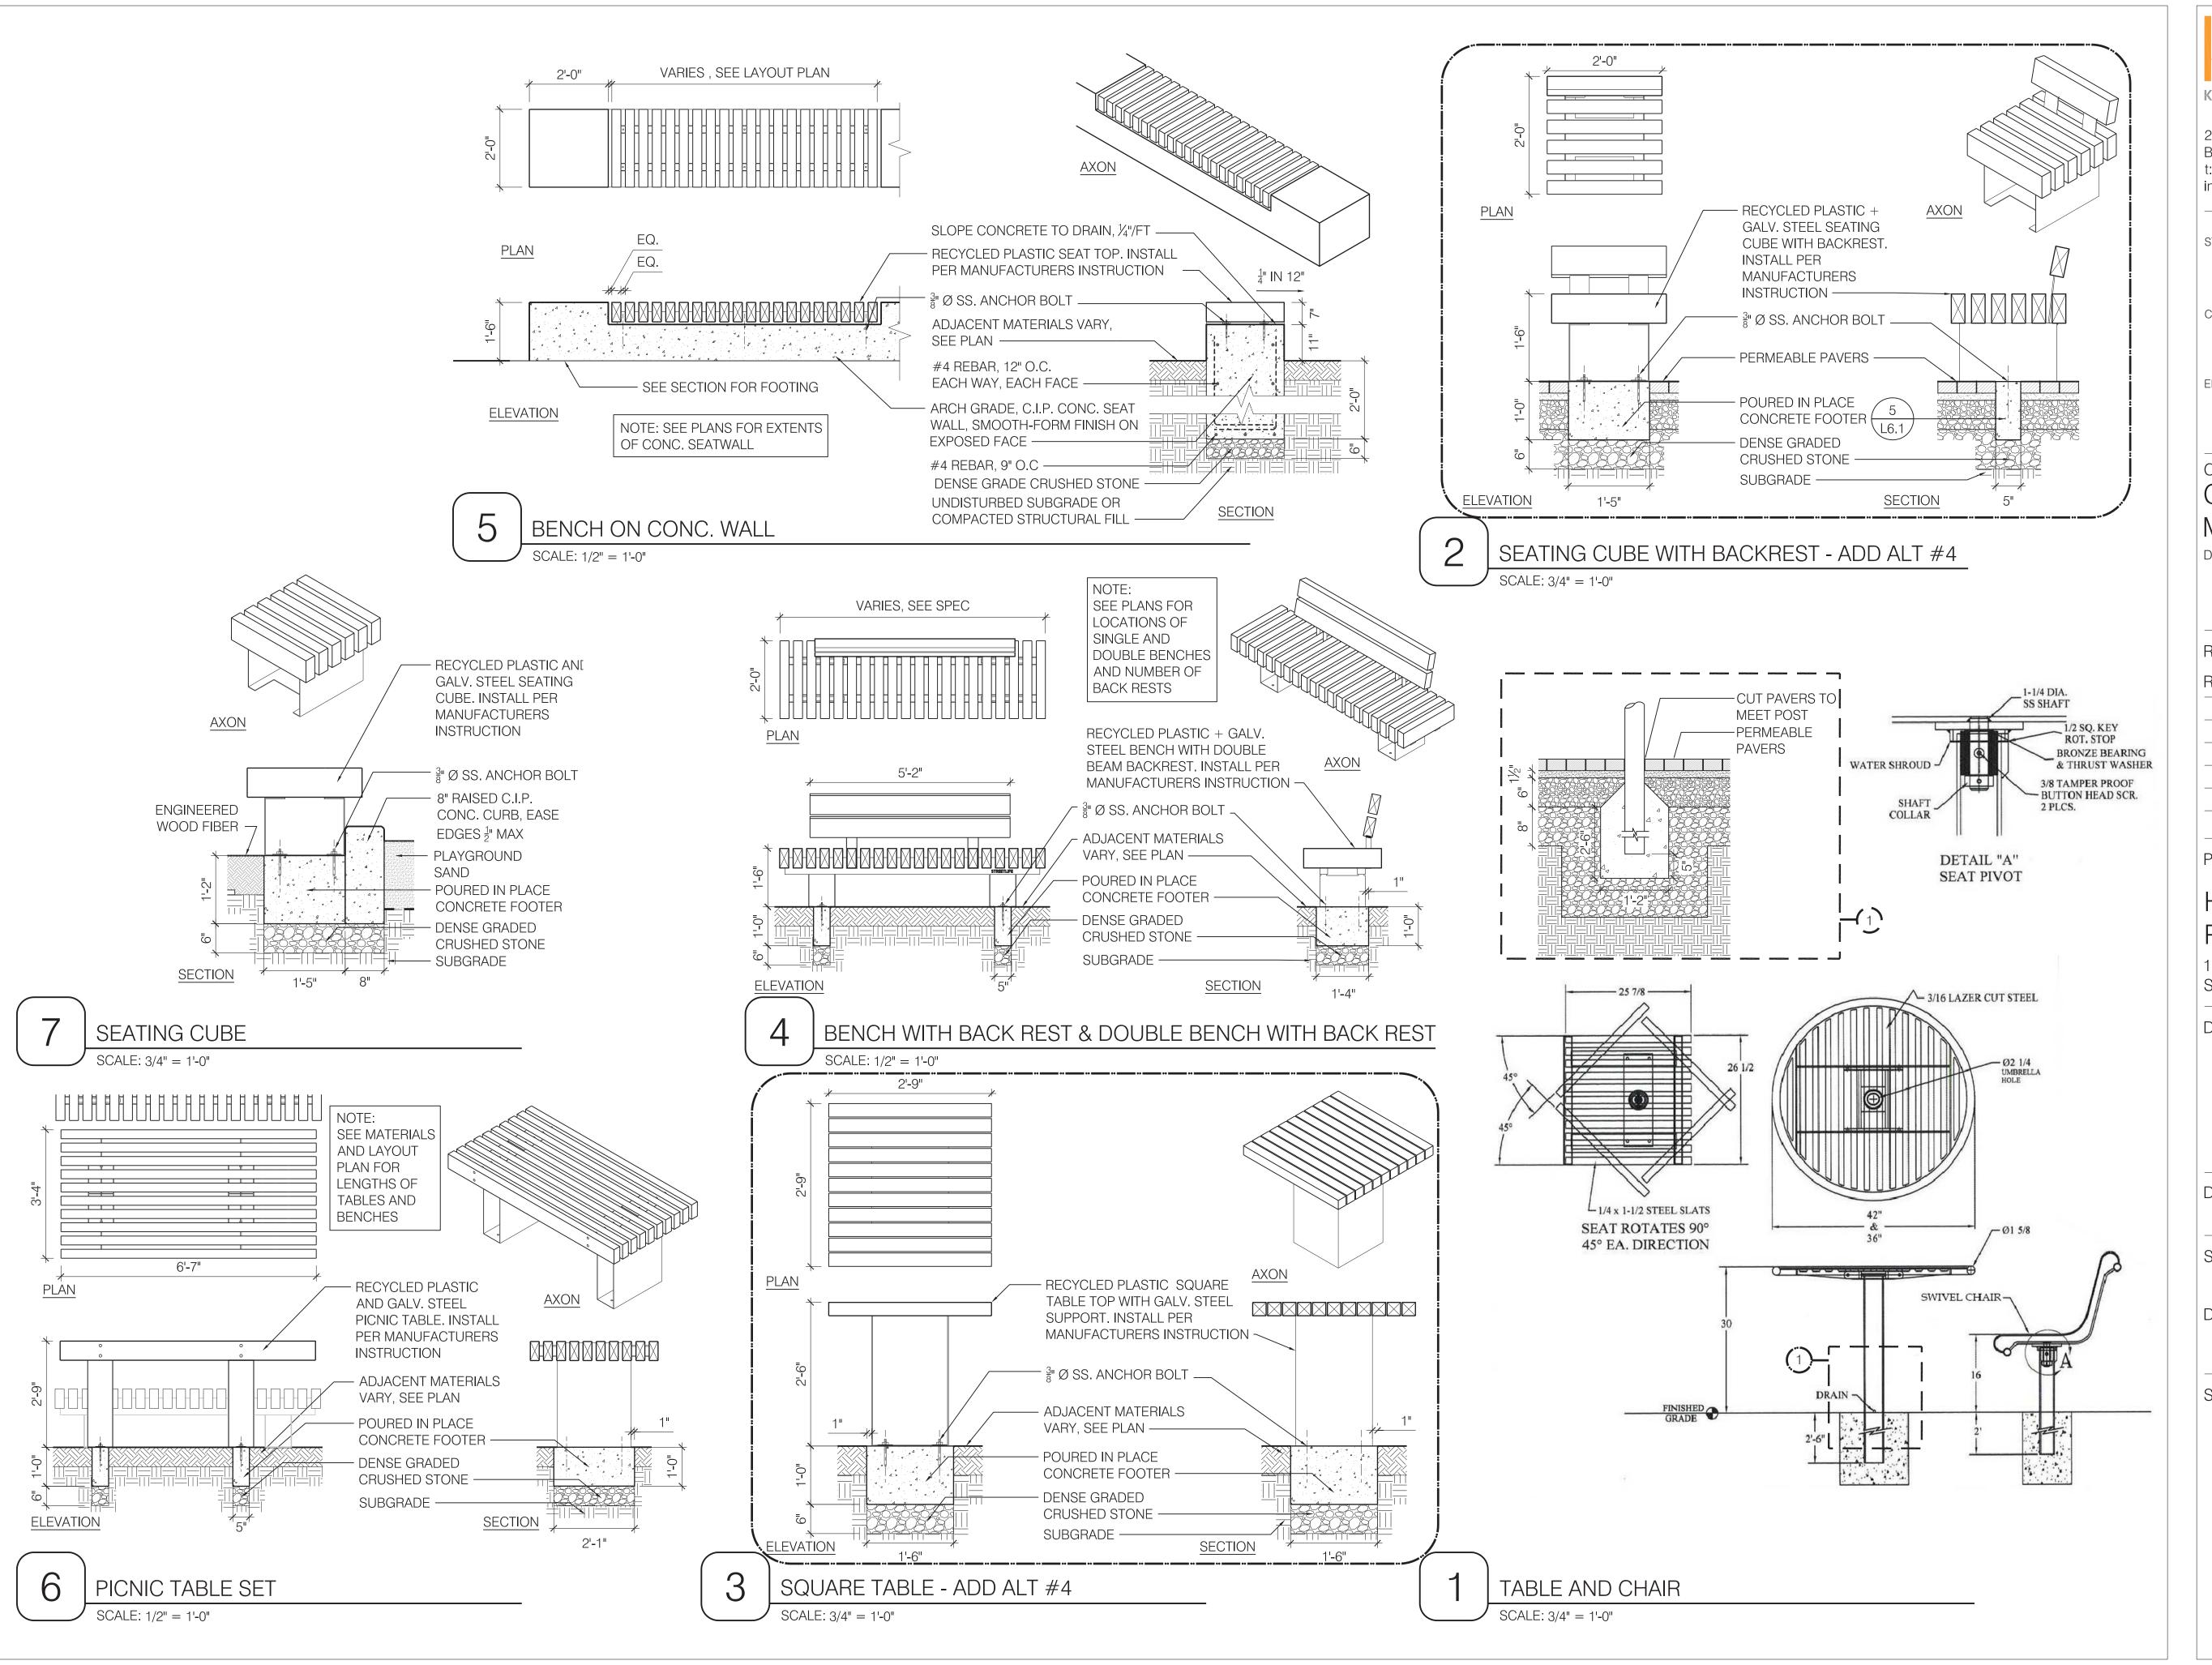L6.4



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REV DATE NOTE

PROJECT: KMDG #1604

HOYT SULLIVAN PLAYGROUND

117 CENTRAL STREET SOMERVILLE, MA 02145

DRAWING:

SITE FURNISHINGS

DRAWN: REVIEW:

SCALE:

AS NOTED


DATE:

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SHEET:



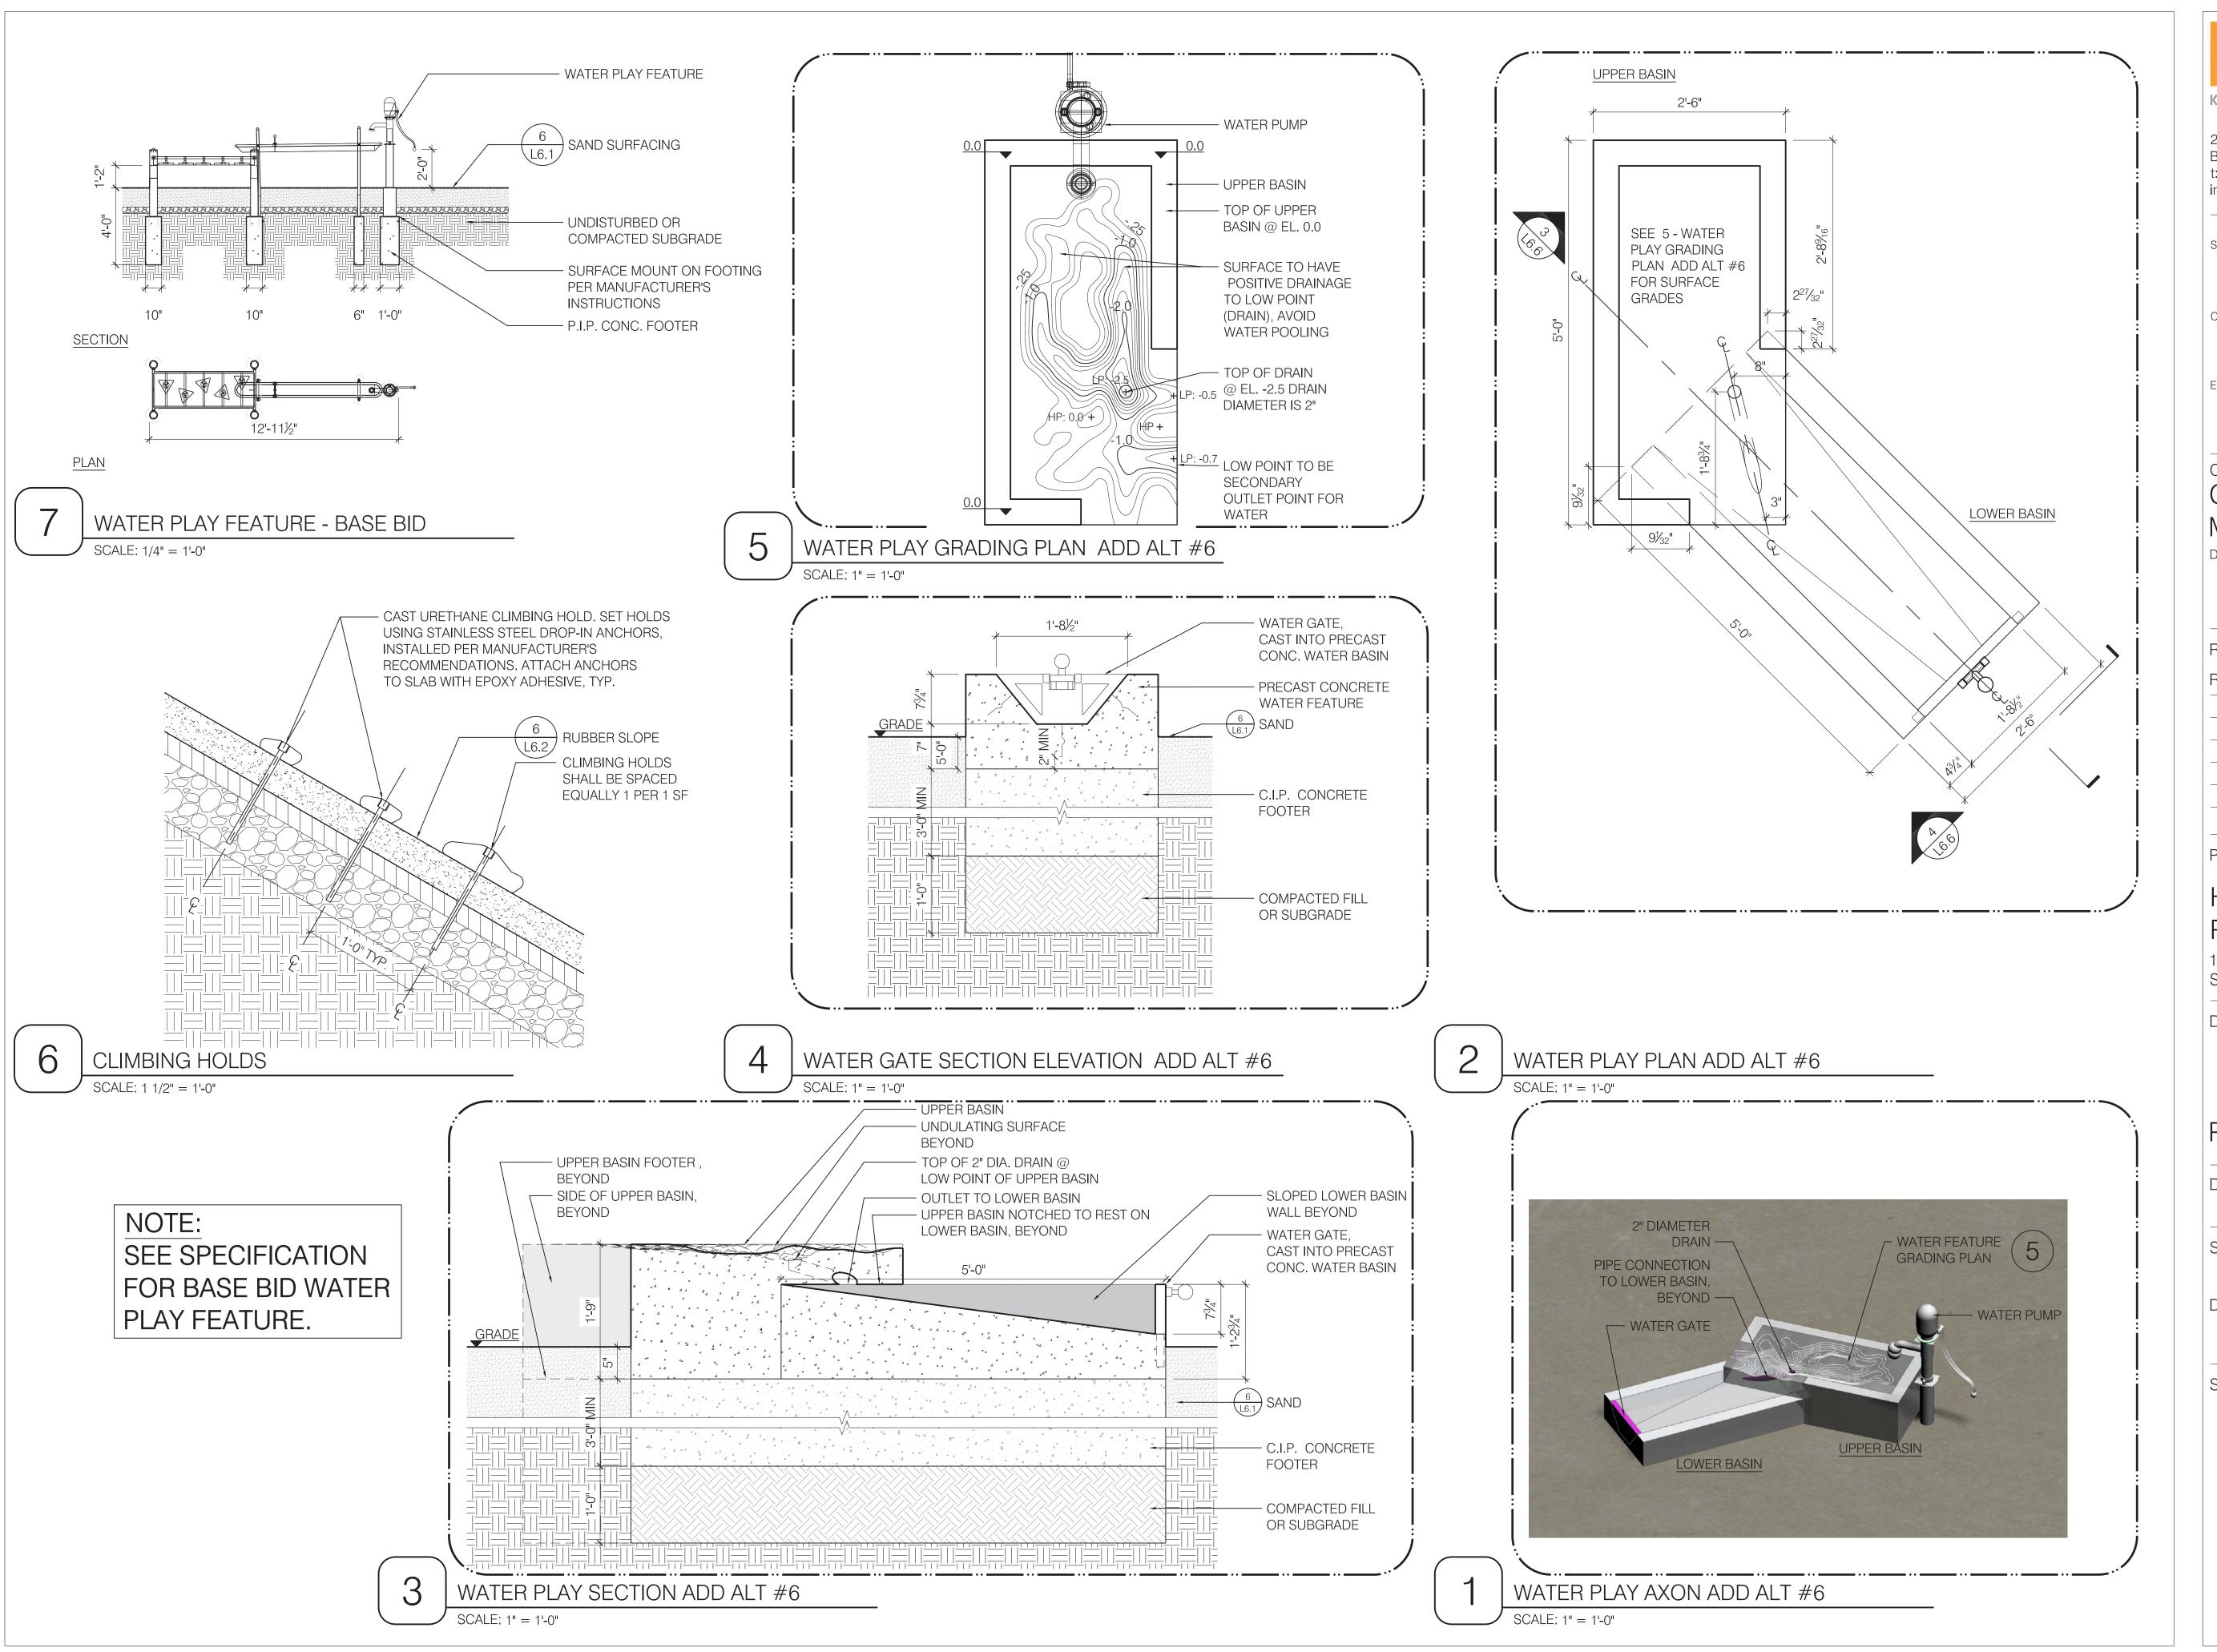L6.5



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HOYT SULLIVAN PLAYGROUND

117 CENTRAL STREET SOMERVILLE. MA 02145

DRAWING:

PLAY DETAILS

DRAWN: DS/EH

REVIEW: EH SK

SCALE: AS NOTED


DATE:

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SHEET:



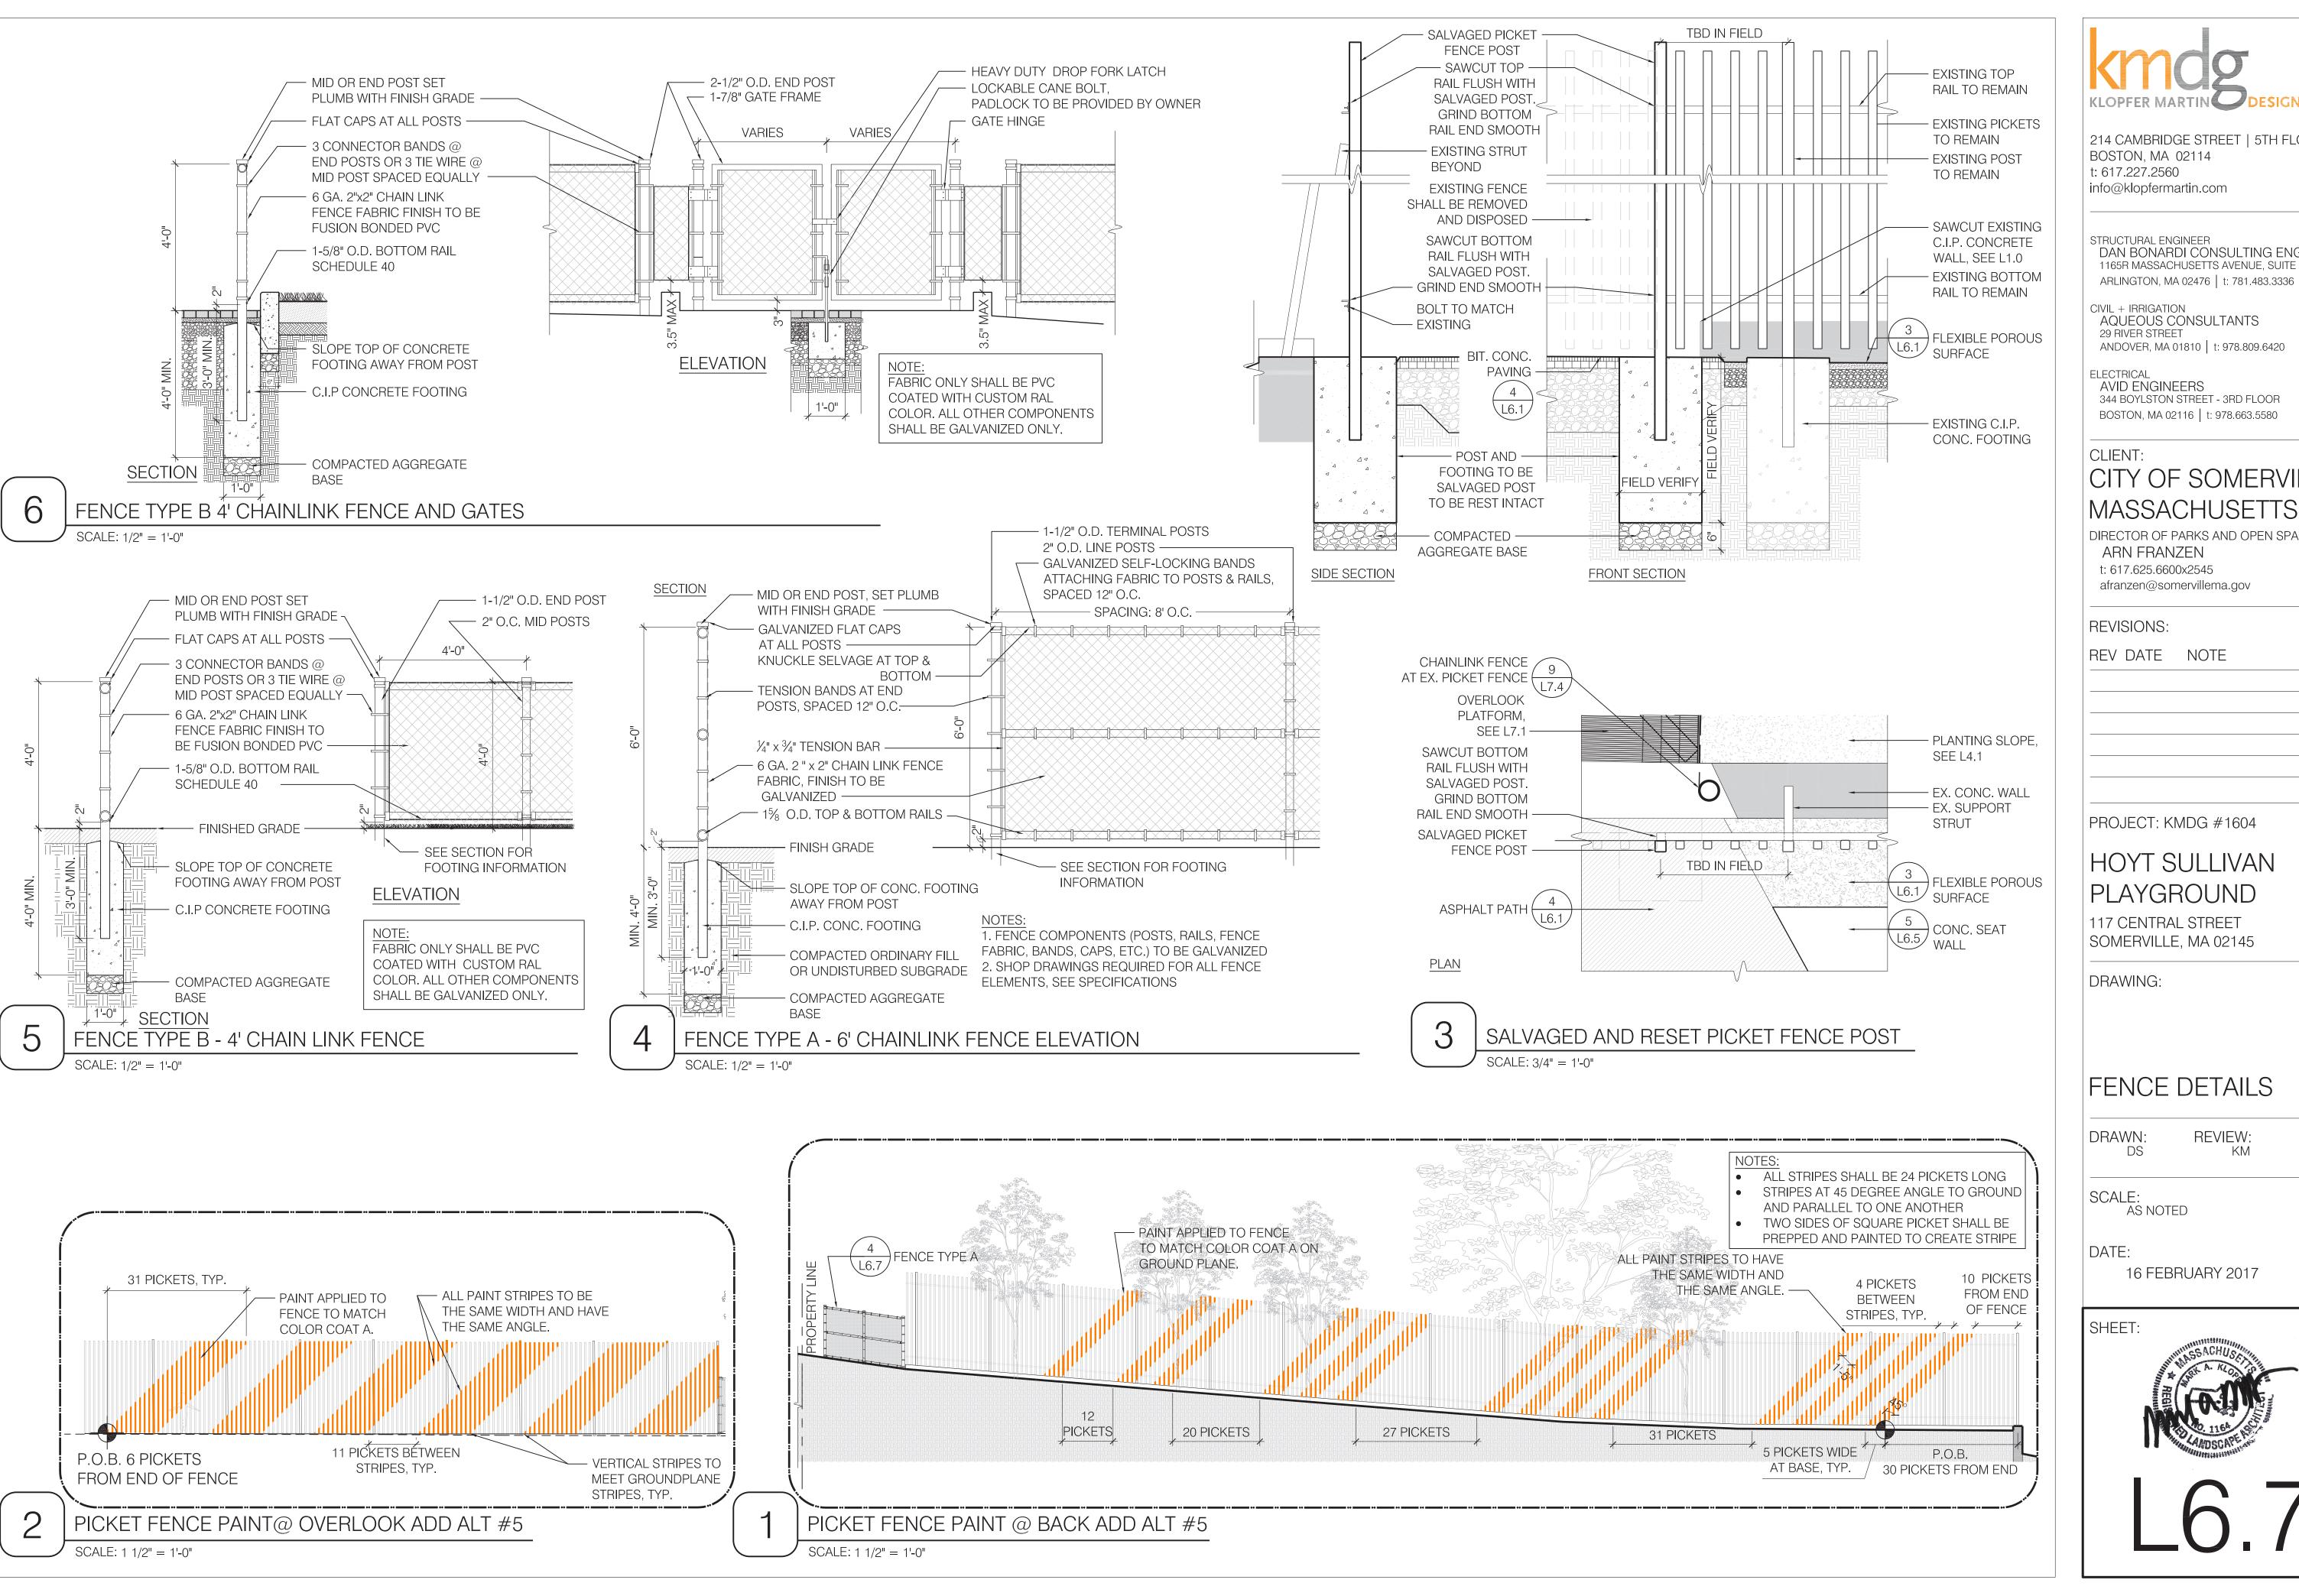L6.6



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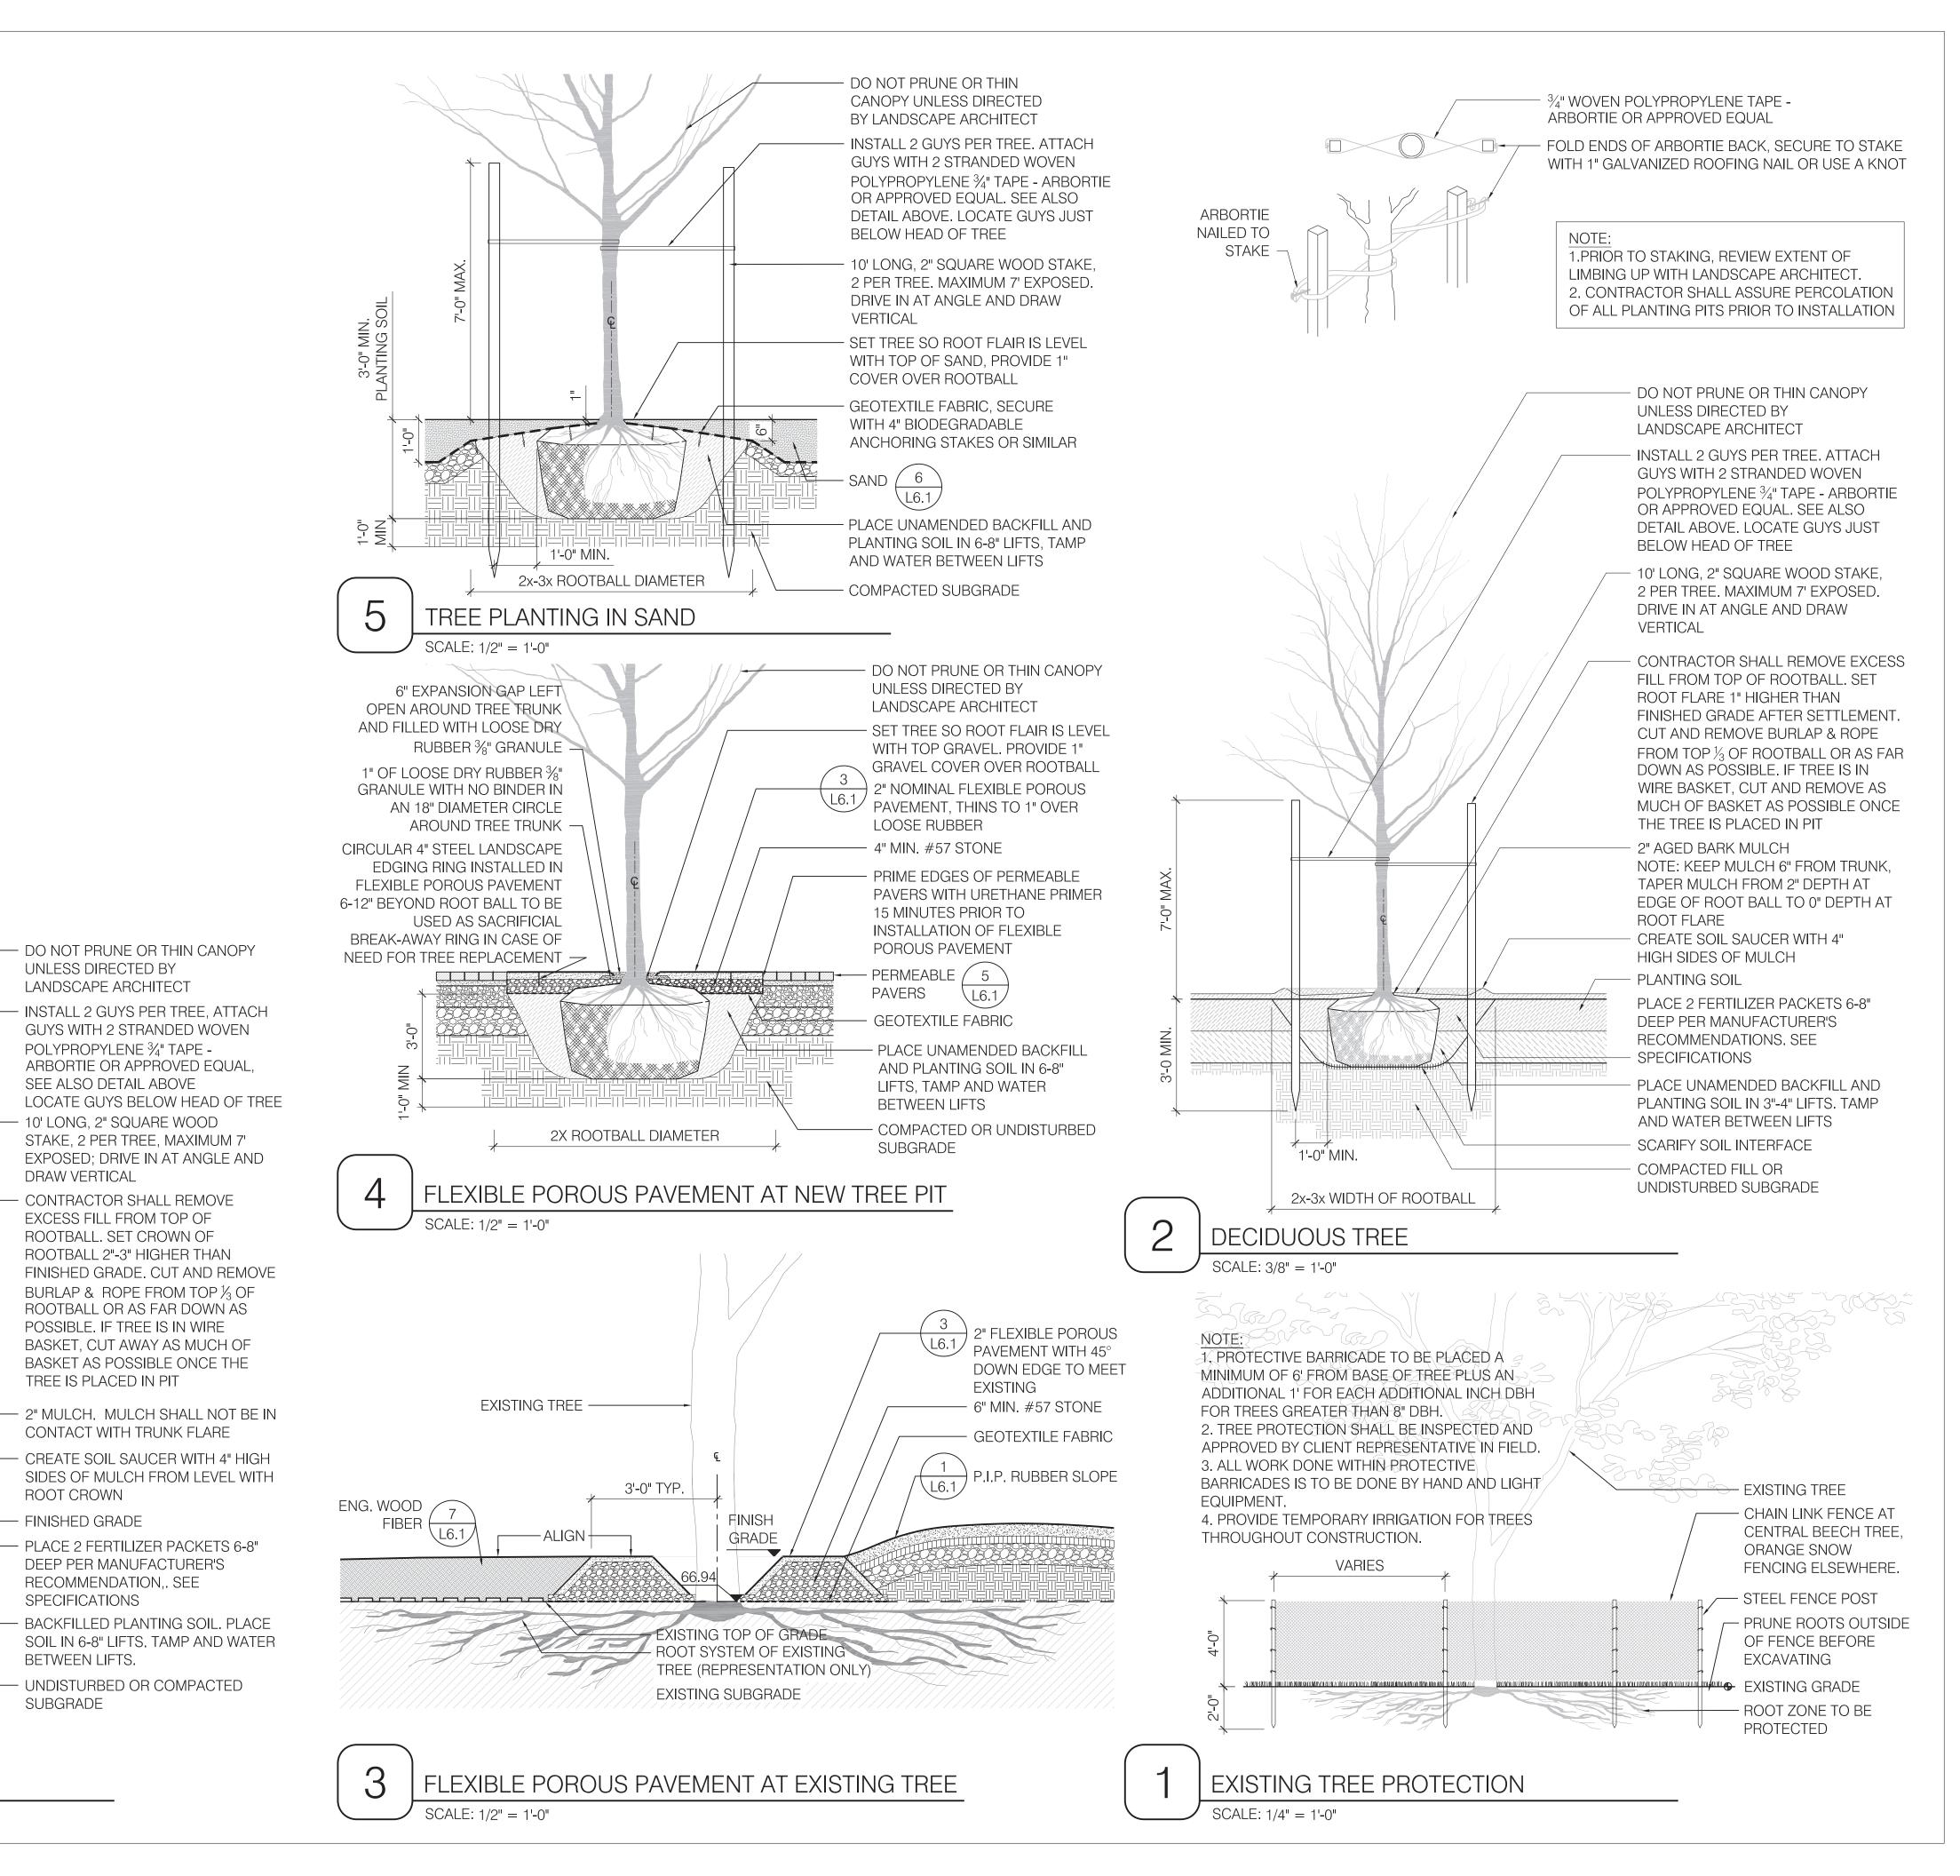
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HOYT SULLIVAN PLAYGROUND

117 CENTRAL STREET SOMERVILLE, MA 02145

DRAWING:

PLANTING DETAILS 1

DRAWN: REVIEW: EΗ

SCALE: AS NOTED

DATE:

16 FEBRUARY 2017

SHEET:



1'-0" MIN.

2X ROOTBALL DIAMETER

UNLESS DIRECTED BY

LANDSCAPE ARCHITECT

SEE ALSO DETAIL ABOVE

DRAW VERTICAL

TREE IS PLACED IN PIT

ROOT CROWN

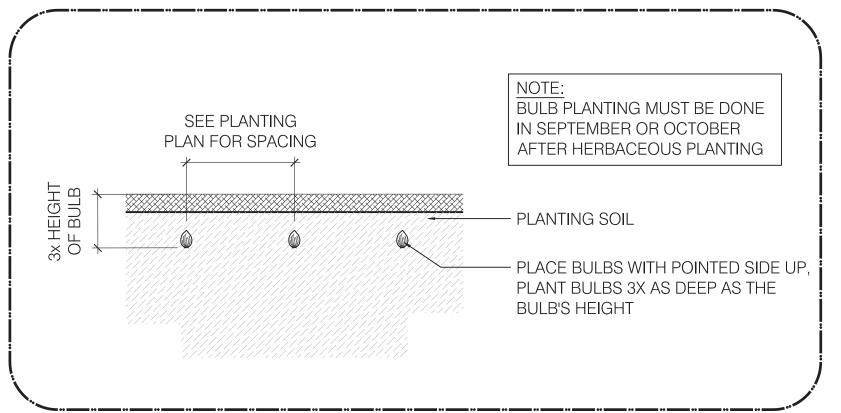
FINISHED GRADE

SPECIFICATIONS

BETWEEN LIFTS.

SUBGRADE

RECOMMENDATION.. SEE



5 BULB PLANTING ADD ALT #3

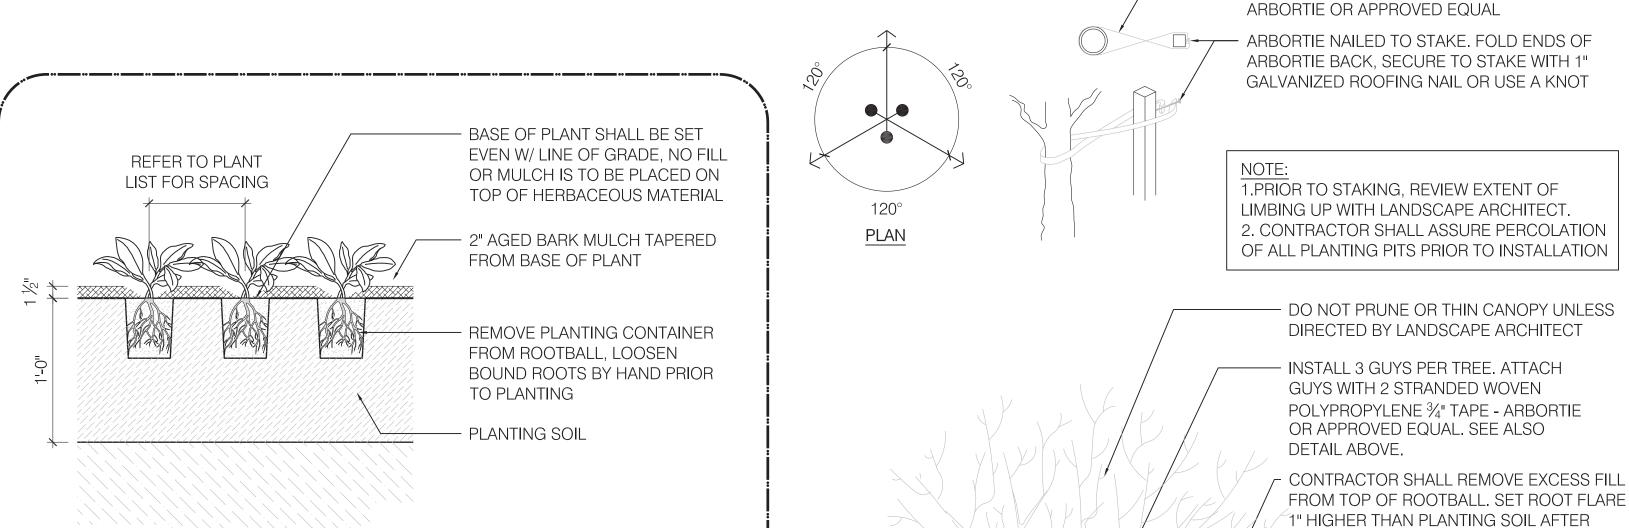
SCALE: 1 1/2" = 1'-0"

2x WIDTH OF ROOTBALL

DECOMPACTED SUBGRADE


INDIVIDUAL SHRUB PLANTING

SCALE: 3/4" = 1'-0"



GROUNDCOVER PLANTING ADD ALT #3

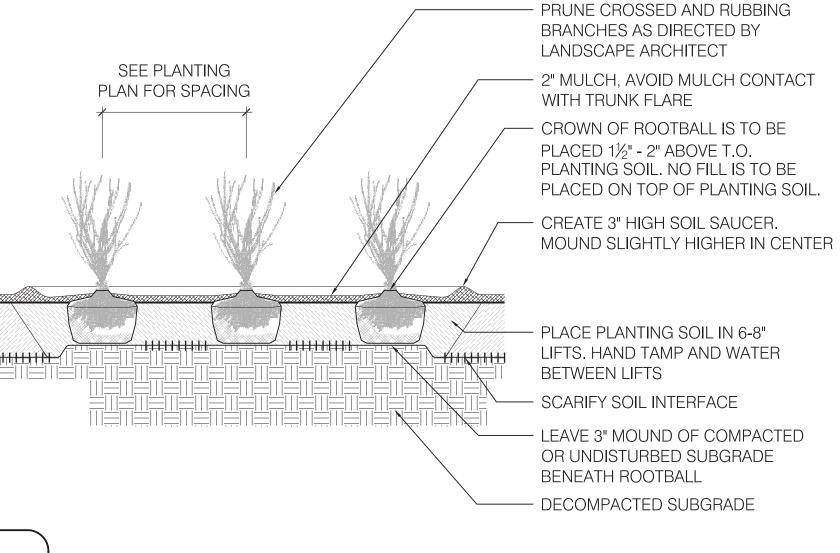SCALE: 1 1/2" = 1'-0"




MULTISTEM TREE PLANTING

SCALE: 3/8" = 1'-0"

2-3x WIDTH OF ROOTBALL

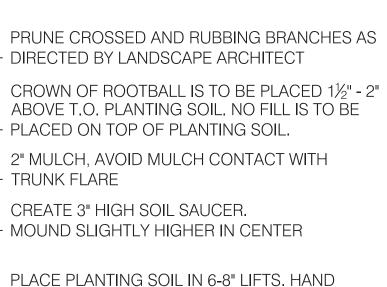1'-0" MIN



- SCARIFY SOIL INTERFACE

3/4" WOVEN POLYPROPYLENE TAPE -

- LEAVE 3" MOUND OF COMPACTED OR

UNDISTURBED SUBGRADE BENEATH ROOTBALL

SETTLEMENT. CUT AND REMOVE BURLAP & ROPE FROM TOP ½ OF ROOTBALL OR AS

WIRE BASKET, CUT AND REMOVE AS MUCH

OF BASKET AS POSSIBLE ONCE THE TREE

10' LONG, 2" SQUARE WOOD STAKE, 3 PER TREE. MAXIMUM 7' EXPOSED. DRIVE IN AT

NOTE: KEEP MULCH 6" FROM TRUNK,

EDGE OF ROOT BALL TO 0" DEPTH AT

CREATE SOIL SAUCER WITH 4" HIGH SIDES

MANUFACTURER'S RECOMMENDATIONS.

PLACE UNAMENDED BACKFILL AND

PLANTING SOIL IN 6-8" LIFTS, TAMP

LEAVE 3" MOUND OF COMPACTED

AND WATER BETWEEN LIFTS

OR UNDISTURBED SUBGRADE

DECOMPACTED SUBGRADE

SCARIFY SOIL INTERFACE

BENEATH ROOTBALL

TAPER MULCH FROM 2" DEPTH AT

ANGLE AND DRAW VERTICAL.

2" AGED BARK MULCH

PLACE FERTILIZER PER

- SEE SPECIFICATIONS

FAR DOWN AS POSSIBLE. IF TREE IS IN

IS PLACED IN PIT.

ROOT FLARE

OF MULCH

PLACE PLANTING SOIL IN 6-8" LIFTS. HAND

- TAMP AND WATER BETWEEN LIFTS

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REV DATE NOTE

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HOYT SULLIVAN PLAYGROUND

117 CENTRAL STREET SOMERVILLE, MA 02145

DRAWING:

PLANTING DETAILS 2

DRAWN: EH

REVIEW: SK

SCALE: AS NOTED

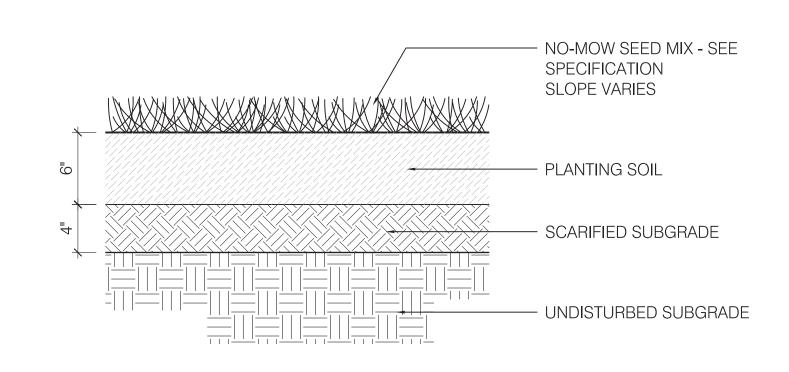
DATE:

16 FEBRUARY 2017

SHEET:



L6.9



6 NO MOW

SCALE: 1 1/2" = 1'-0"

3 SHRUB PLANTING

SCALE: 1/2" = 1'-0"



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REV DATE NOTE

HOYT SULLIVAN **PLAYGROUND**

117 CENTRAL STREET SOMERVILLE, MA 02145

DRAWING:

PLATFORM PLANS

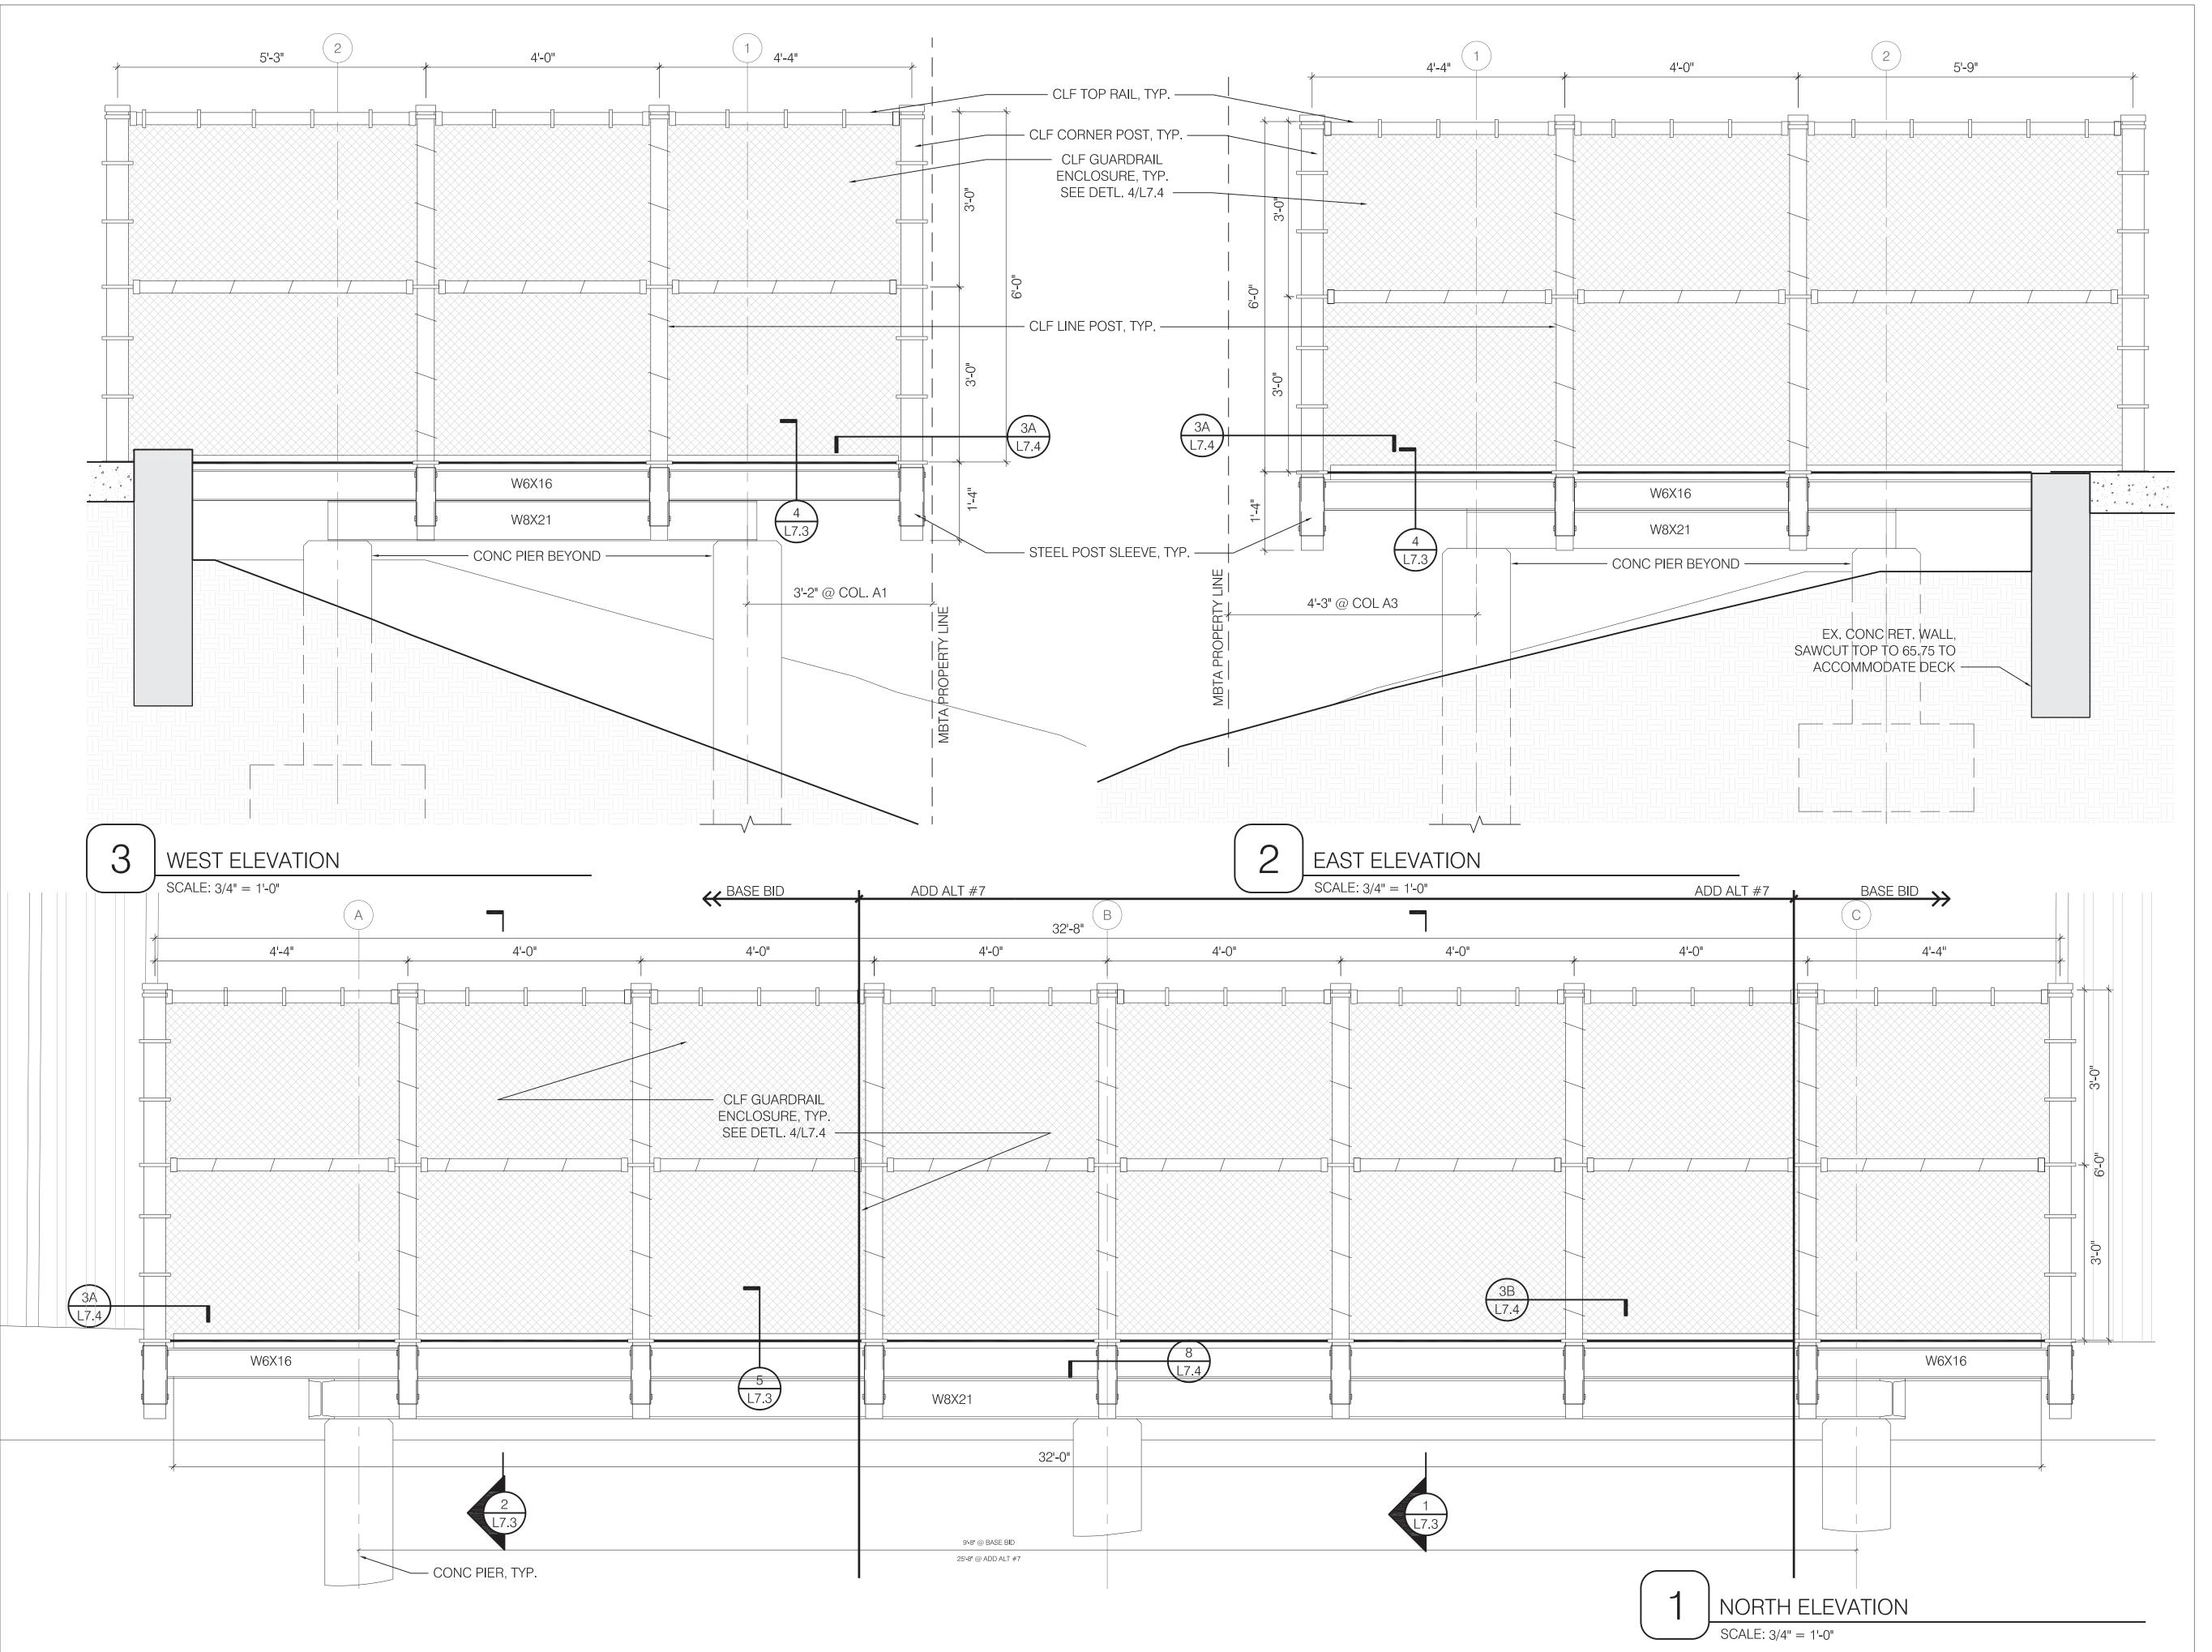
DRAWN: REVIEW: DC/DS

SCALE: AS NOTED

DATE:

16 FEBRUARY 2017







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REVISIONS:

REV DATE NOTE

PROJECT: KMDG #1604

HOYT SULLIVAN PLAYGROUND

117 CENTRAL STREET SOMERVILLE, MA 02145

DRAWING:

PLATFORM ELEVATIONS

DRAWN: REVIEW: KP

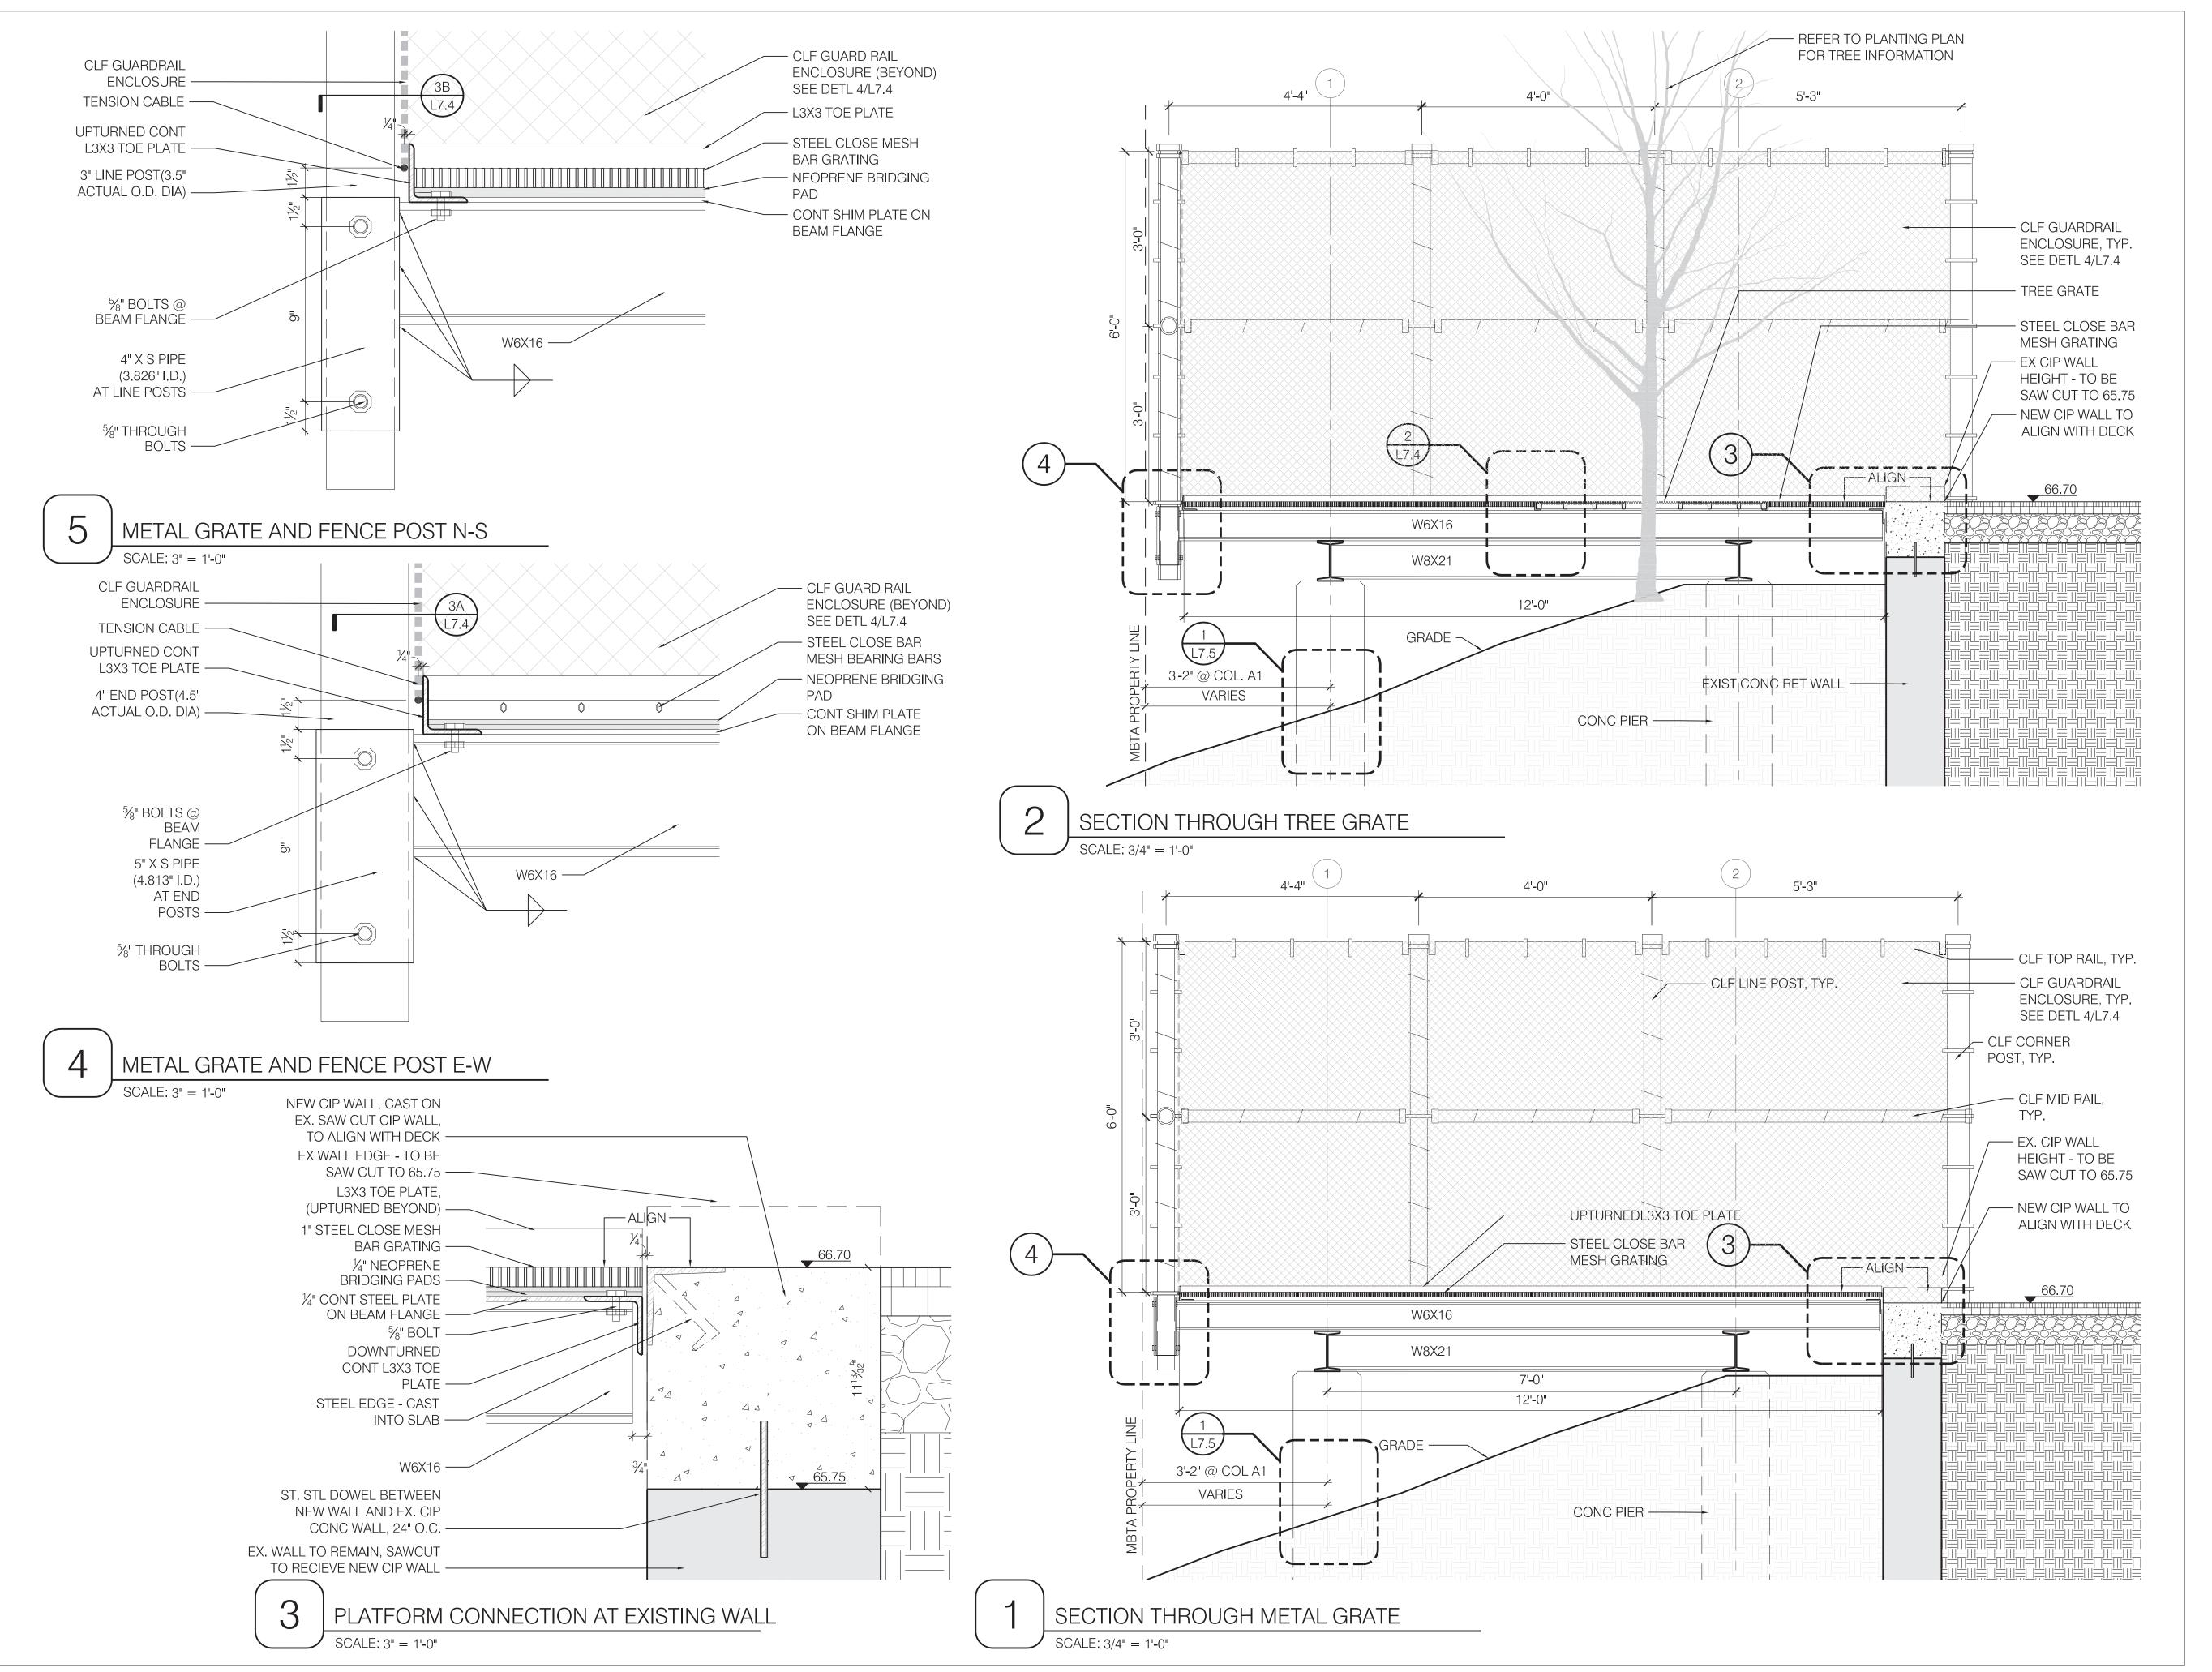
SCALE: AS NOTED

DATE:

16 FEBRUARY 2017

SHEET:







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HOYT SULLIVAN PLAYGROUND

117 CENTRAL STREET SOMERVILLE, MA 02145

DRAWING:

PLATFORM SECTIONS

DRAWN: REVIEW:
DC KP

SCALE: AS NOTED

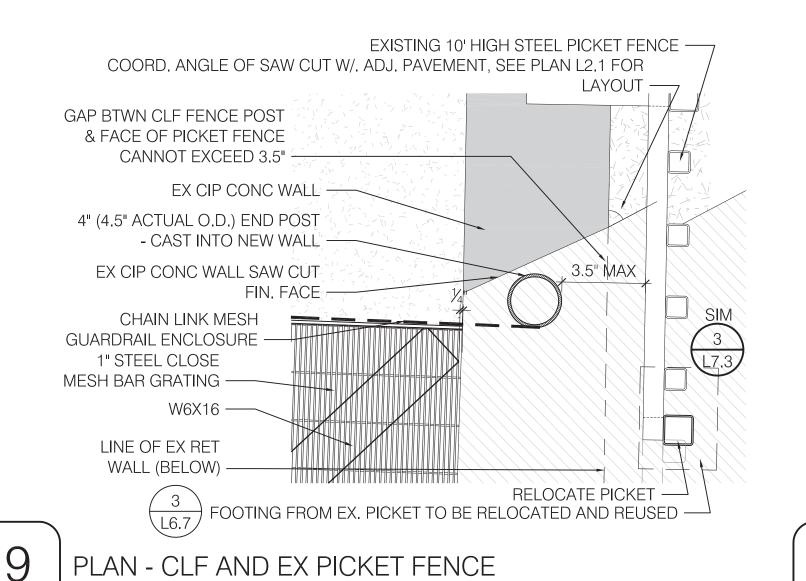
16 FEBRUARY 2017

SHEET:

DATE:



_7.3



& BEAM & PIER

SCALE: 1 1/2" = 1'-0"

W8X21 -

¾" PLATE −

3/4" ANCHOR BOLTS -

1'-2" Ø CIP CONC PIER -

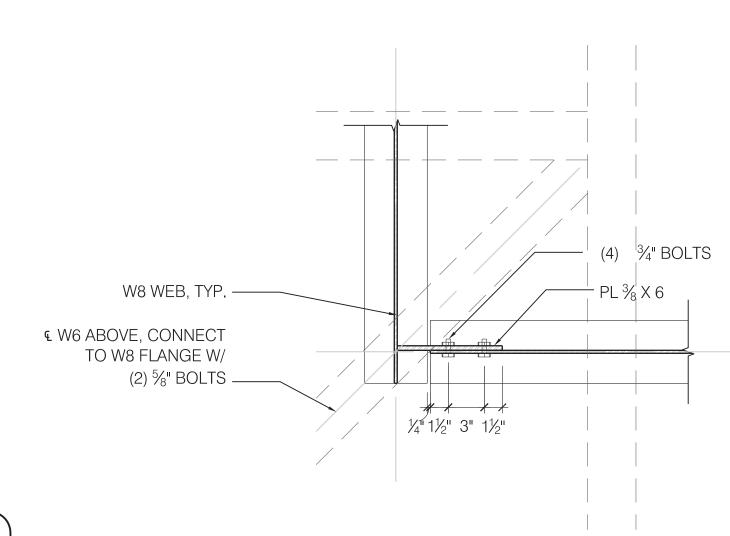
SCALE: 1 1/2" = 1'-0"

1½" 1½"


PLAN - CONCRETE PIER - BEAM SUPPORT

W6X16 (BELOW) L3X3 — 5⁄8" BOLT, TYP. — JOINT 4" END POST


PLAN - FRAMING L3X3 CONNECTION TO W6X16 SCALE: $1 \frac{1}{2} = 1'-0"$



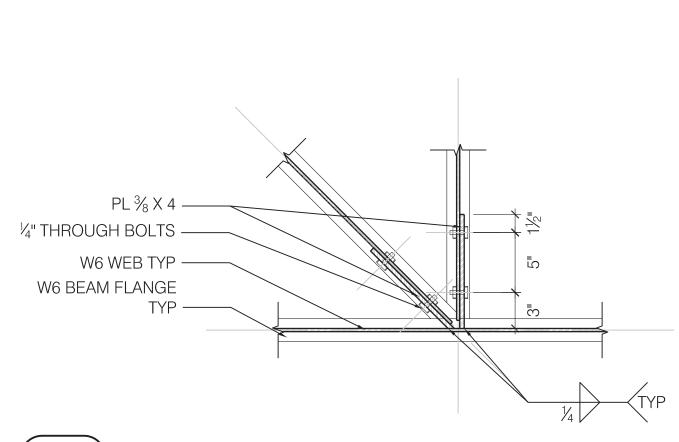
PLAN - W8X21 BEAM CONNECTION SCALE: 1 1/2" = 1'-0"




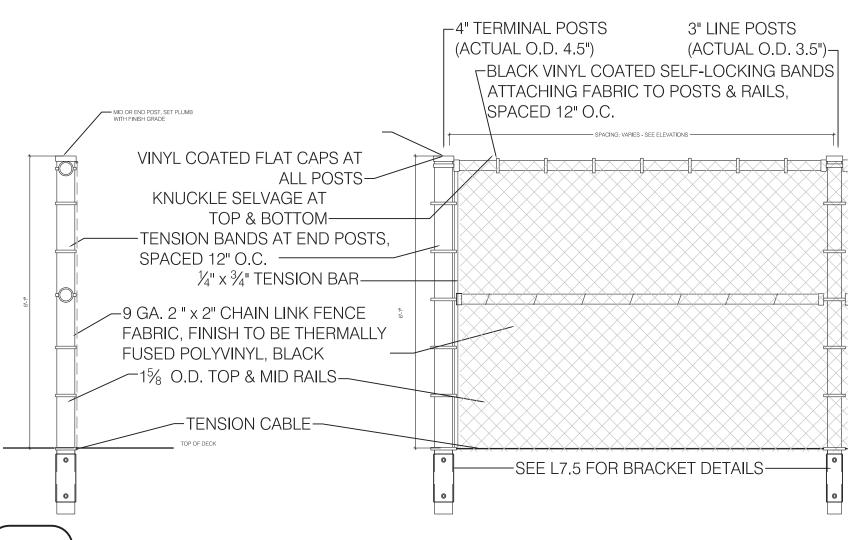PLAN - W6X16 BEAM CONNECTION SCALE: 1 1/2" = 1'-0"



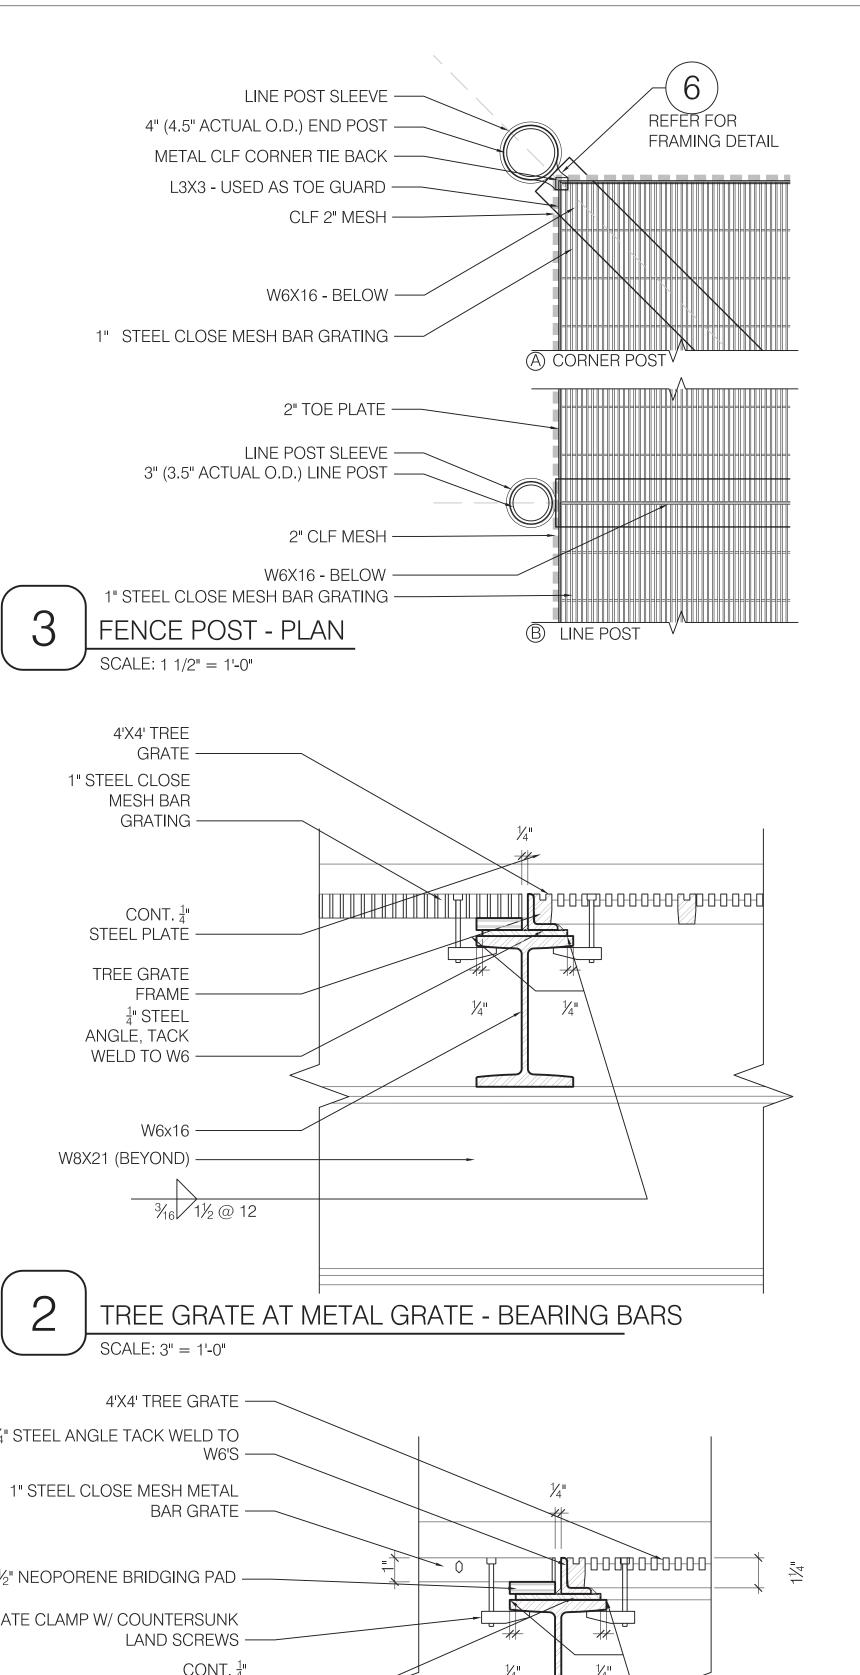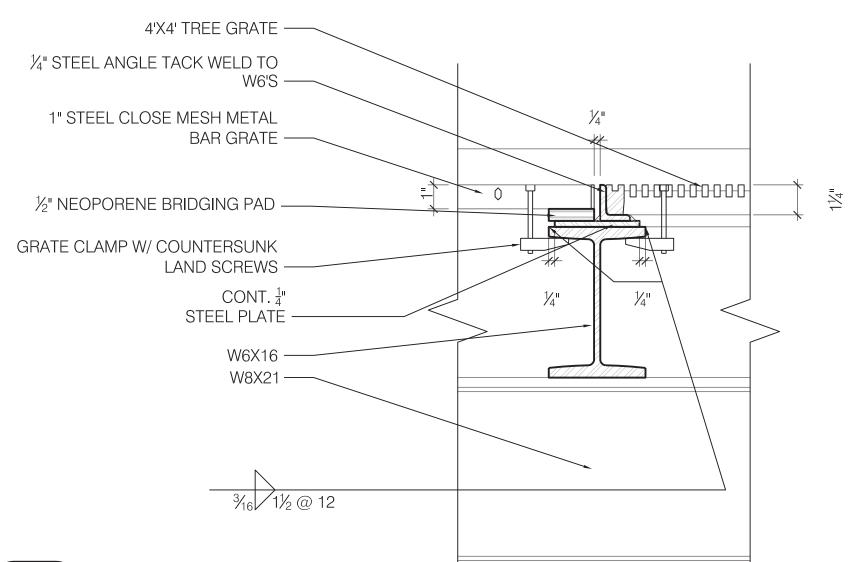TYPICAL CHAIN LINK FENCE DETAIL SCALE: 1/2" = 1'-0"





TREE GRATE AT METAL GRATE - CROSS RODS SCALE: 3" = 1'-0"

DESIGN GROUP

214 CAMBRIDGE STREET | 5TH FLOOR BOSTON, MA 02114 t: 617.227.2560 info@klopfermartin.com

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HOYT SULLIVAN **PLAYGROUND**

117 CENTRAL STREET SOMERVILLE, MA 02145

DRAWING:

PLATFORM DETAILS 1

REVIEW: DRAWN:


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HOYT SULLIVAN PLAYGROUND

117 CENTRAL STREET SOMERVILLE, MA 02145

DRAWING:

PLATFORM DETAILS 2

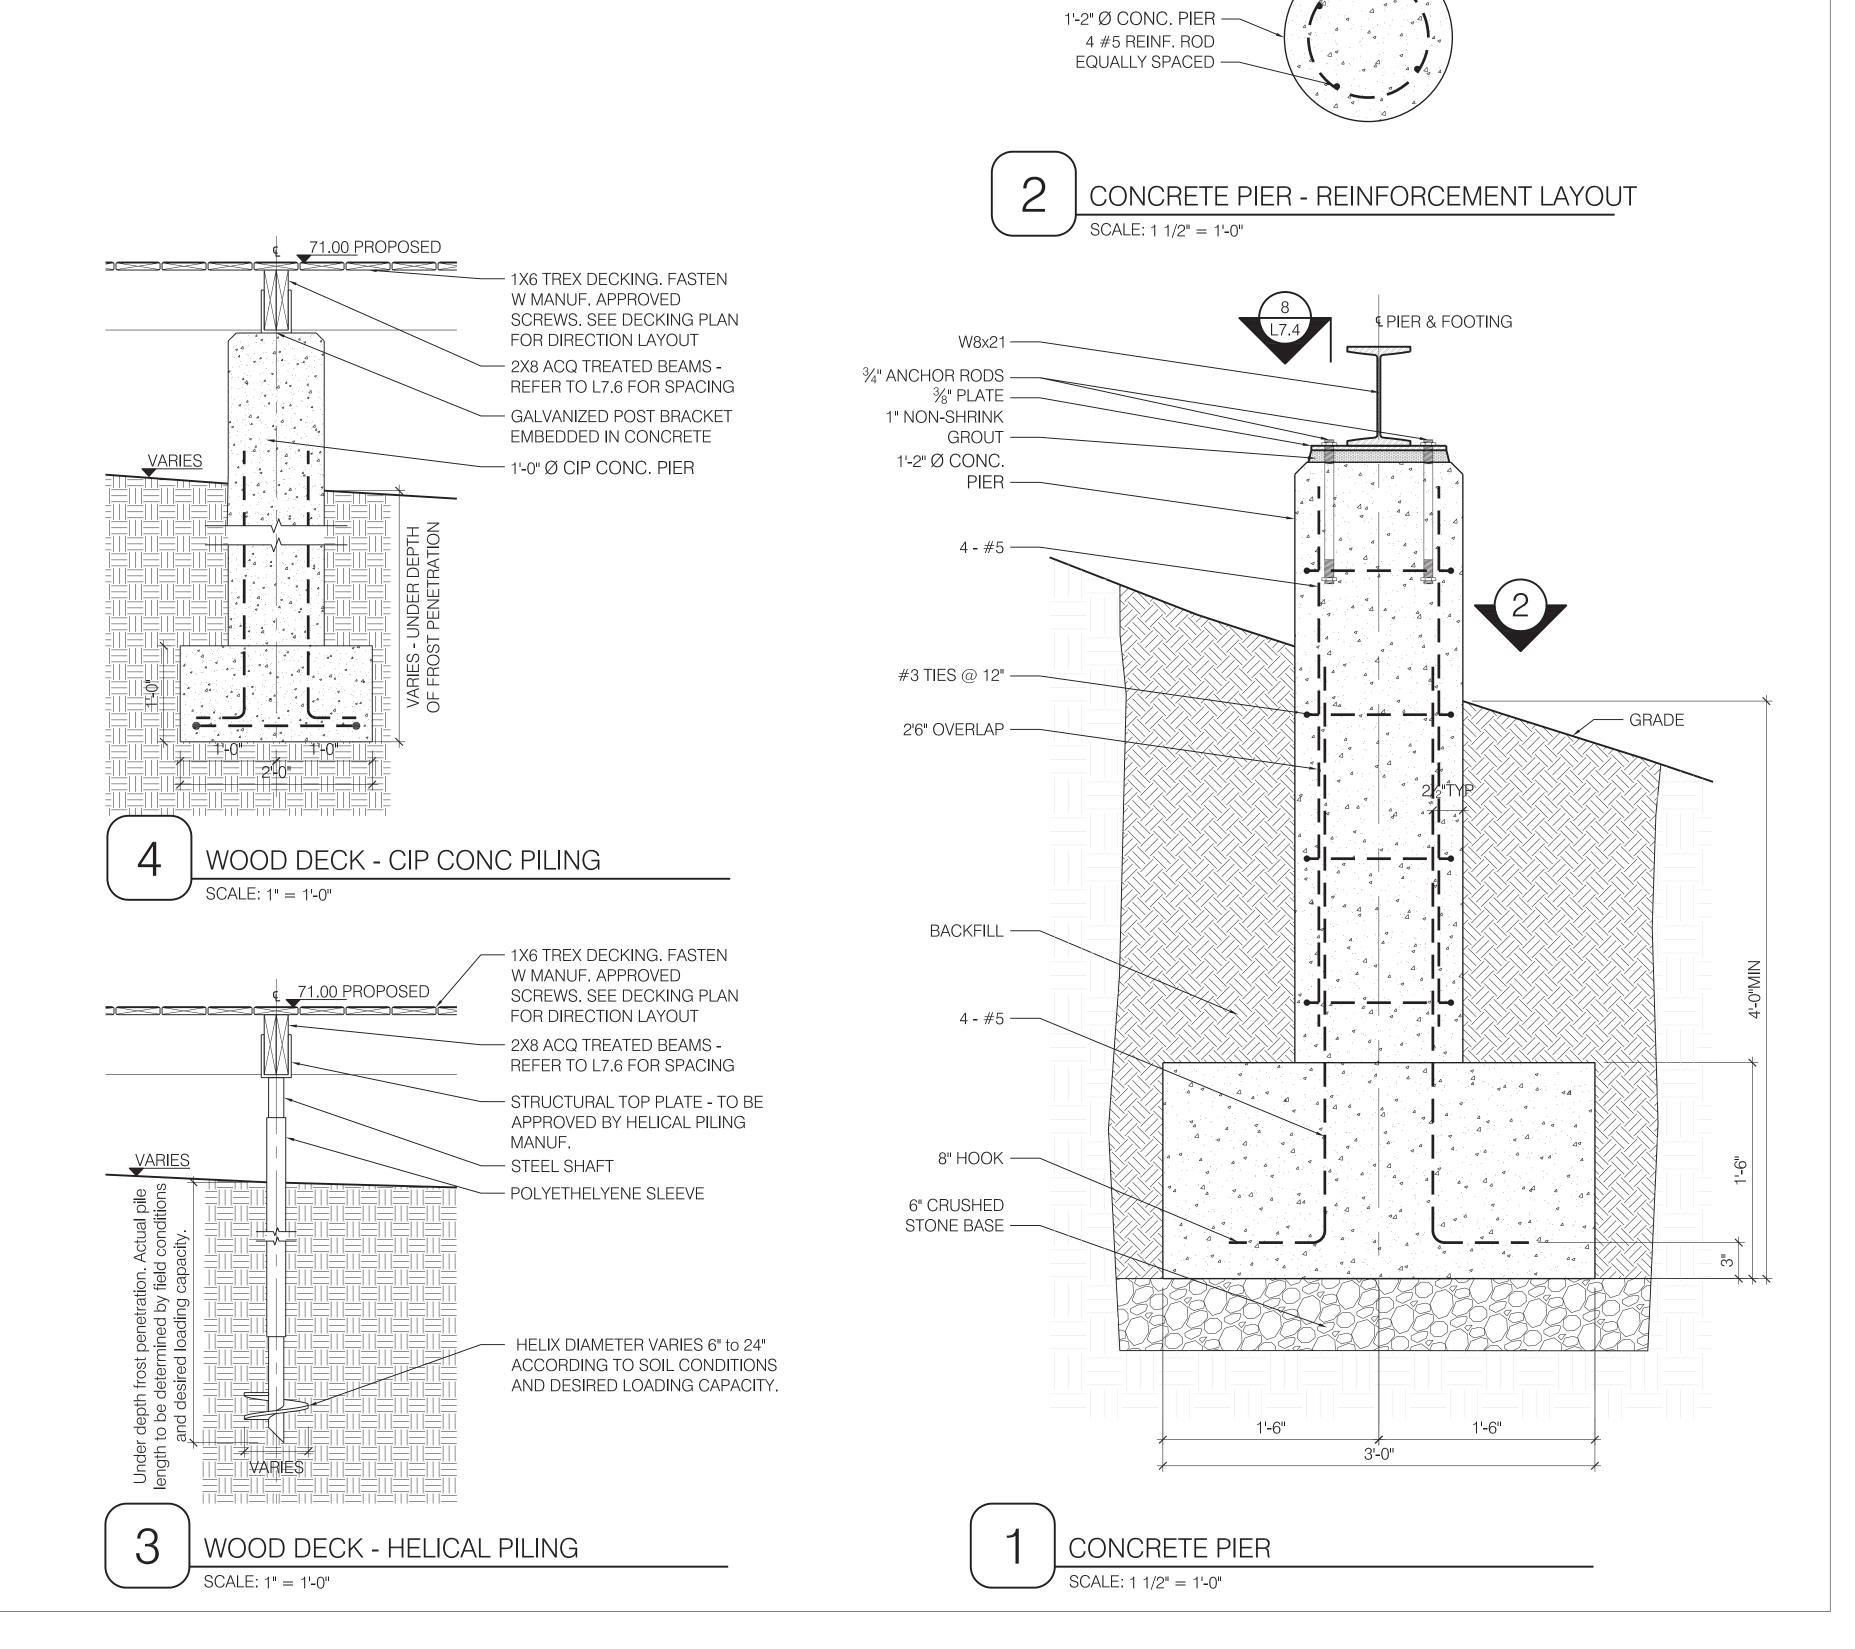DRAWN: REVIEW: KP


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117 CENTRAL STREET SOMERVILLE, MA 02145

DRAWING:

DECK PLANS

DRAWN: REVIEW: DC/DS KP


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DECK DETAILS
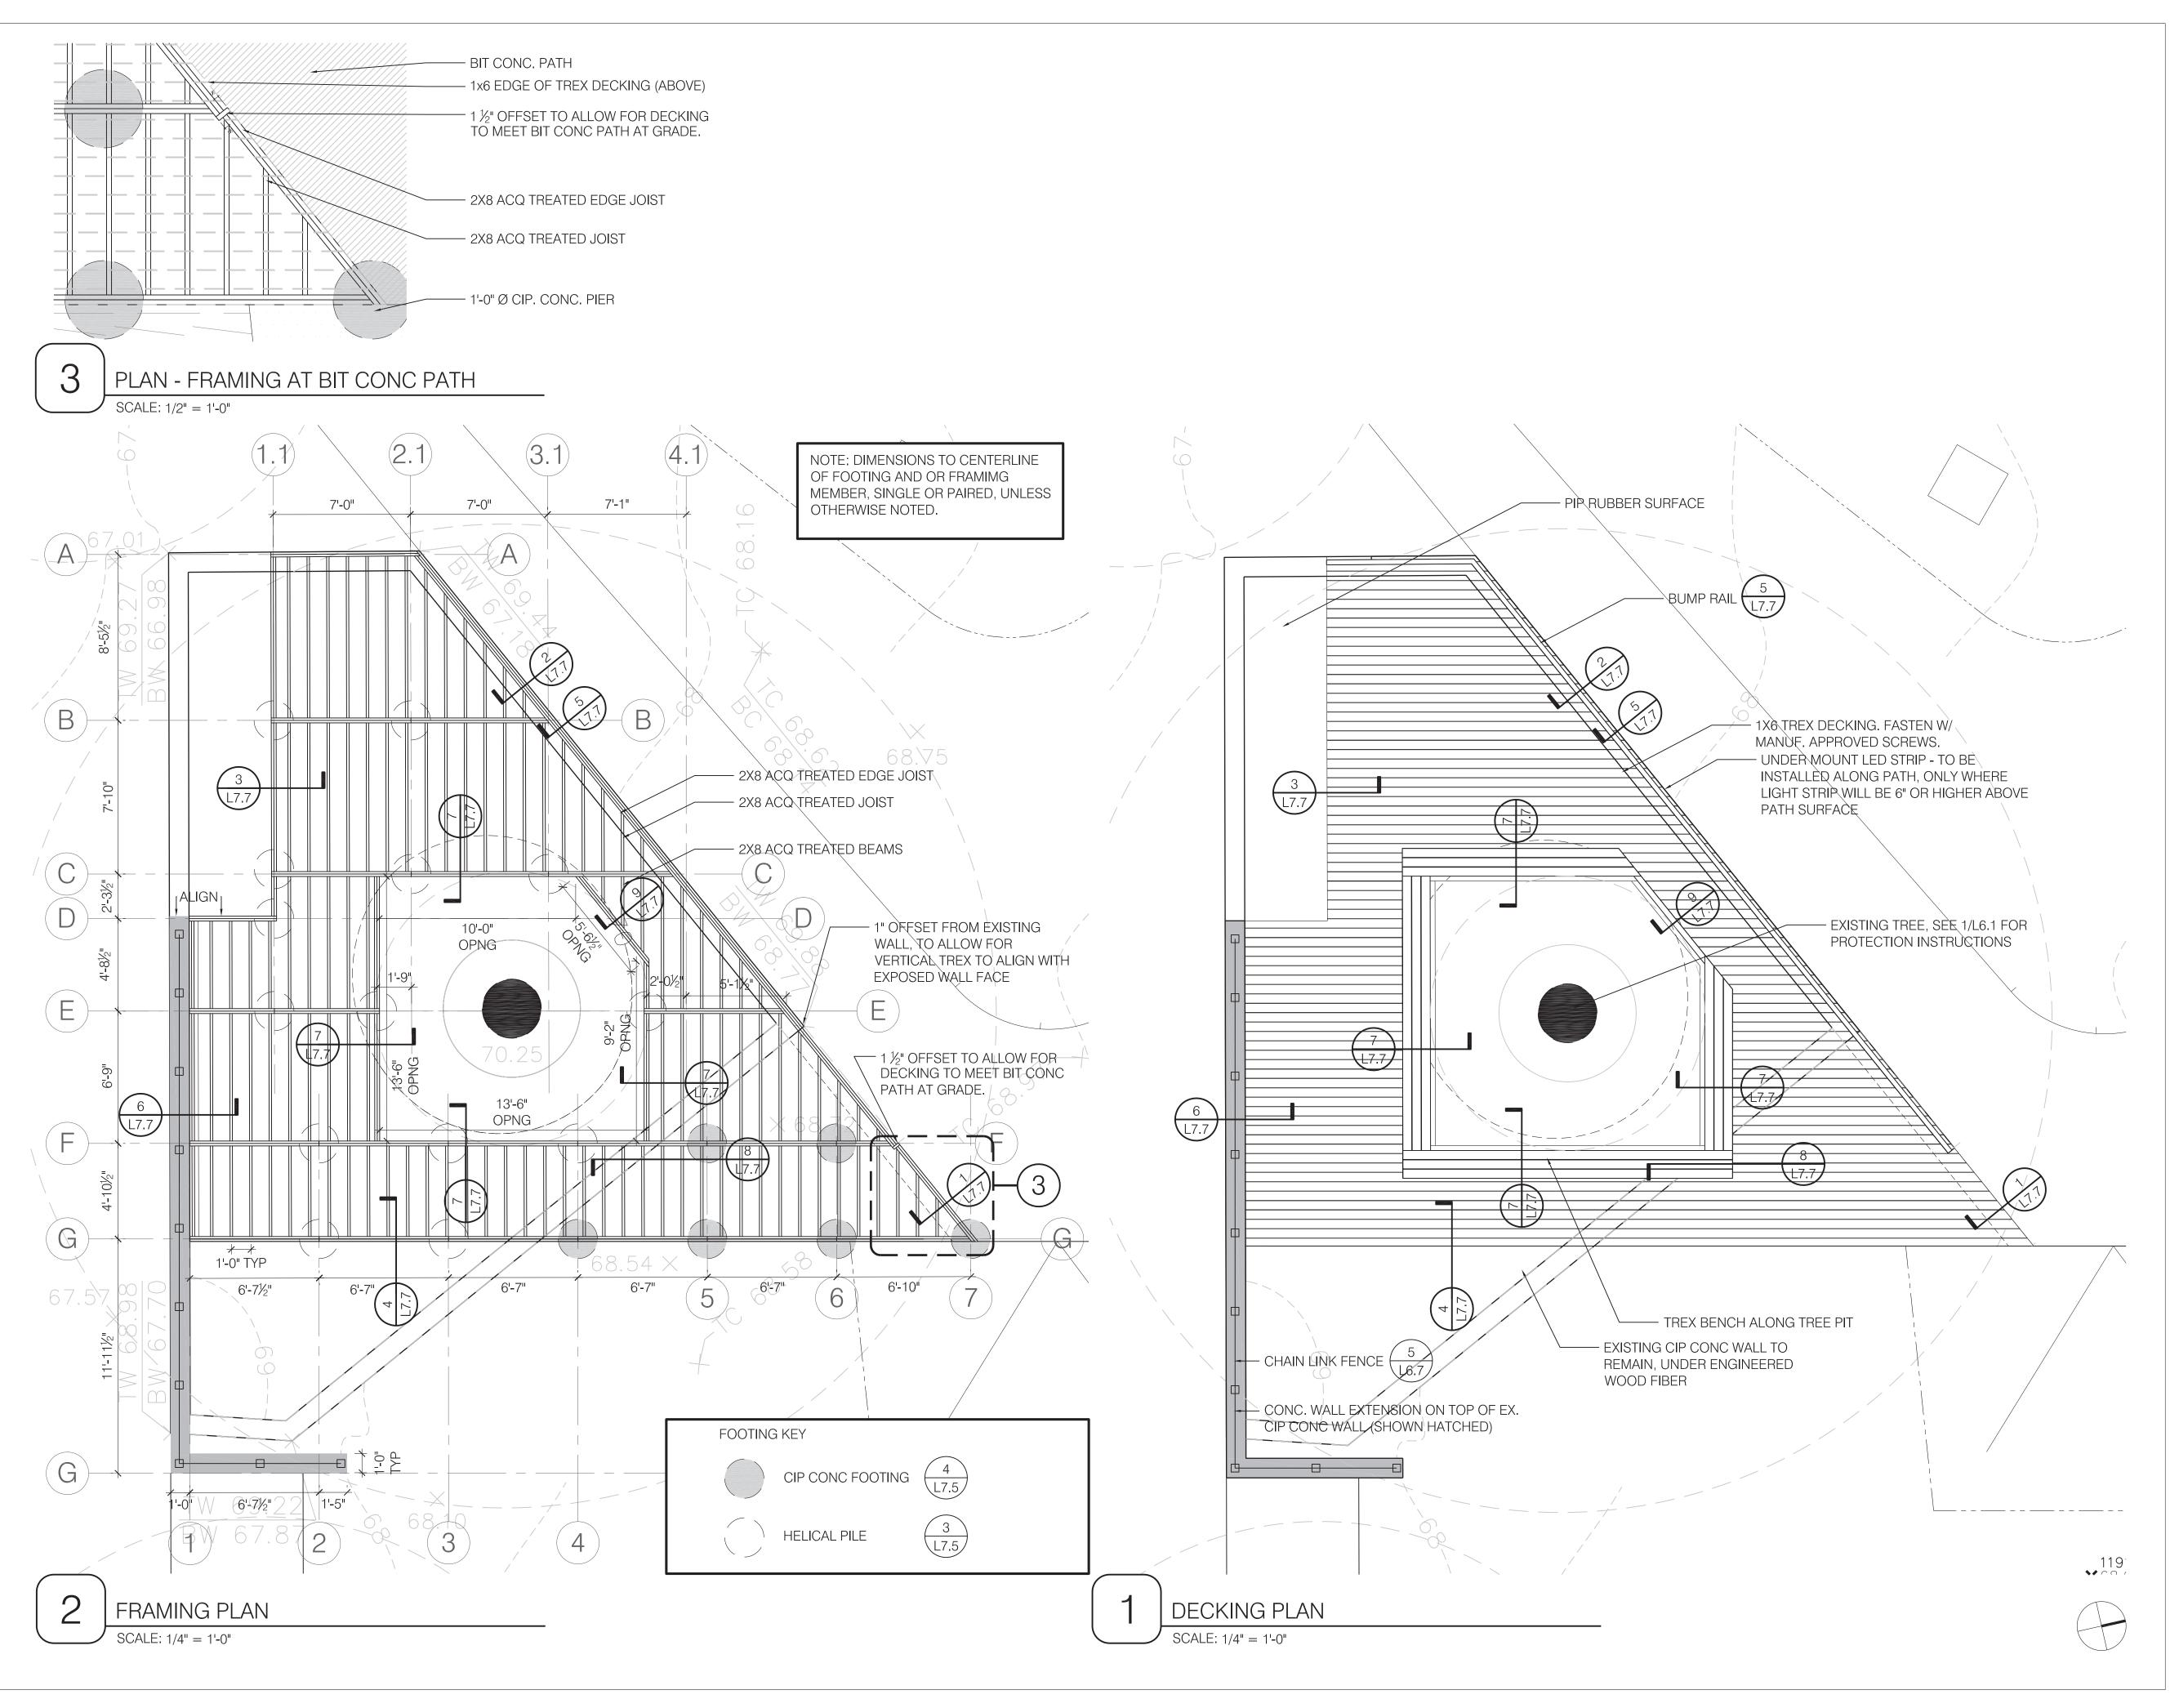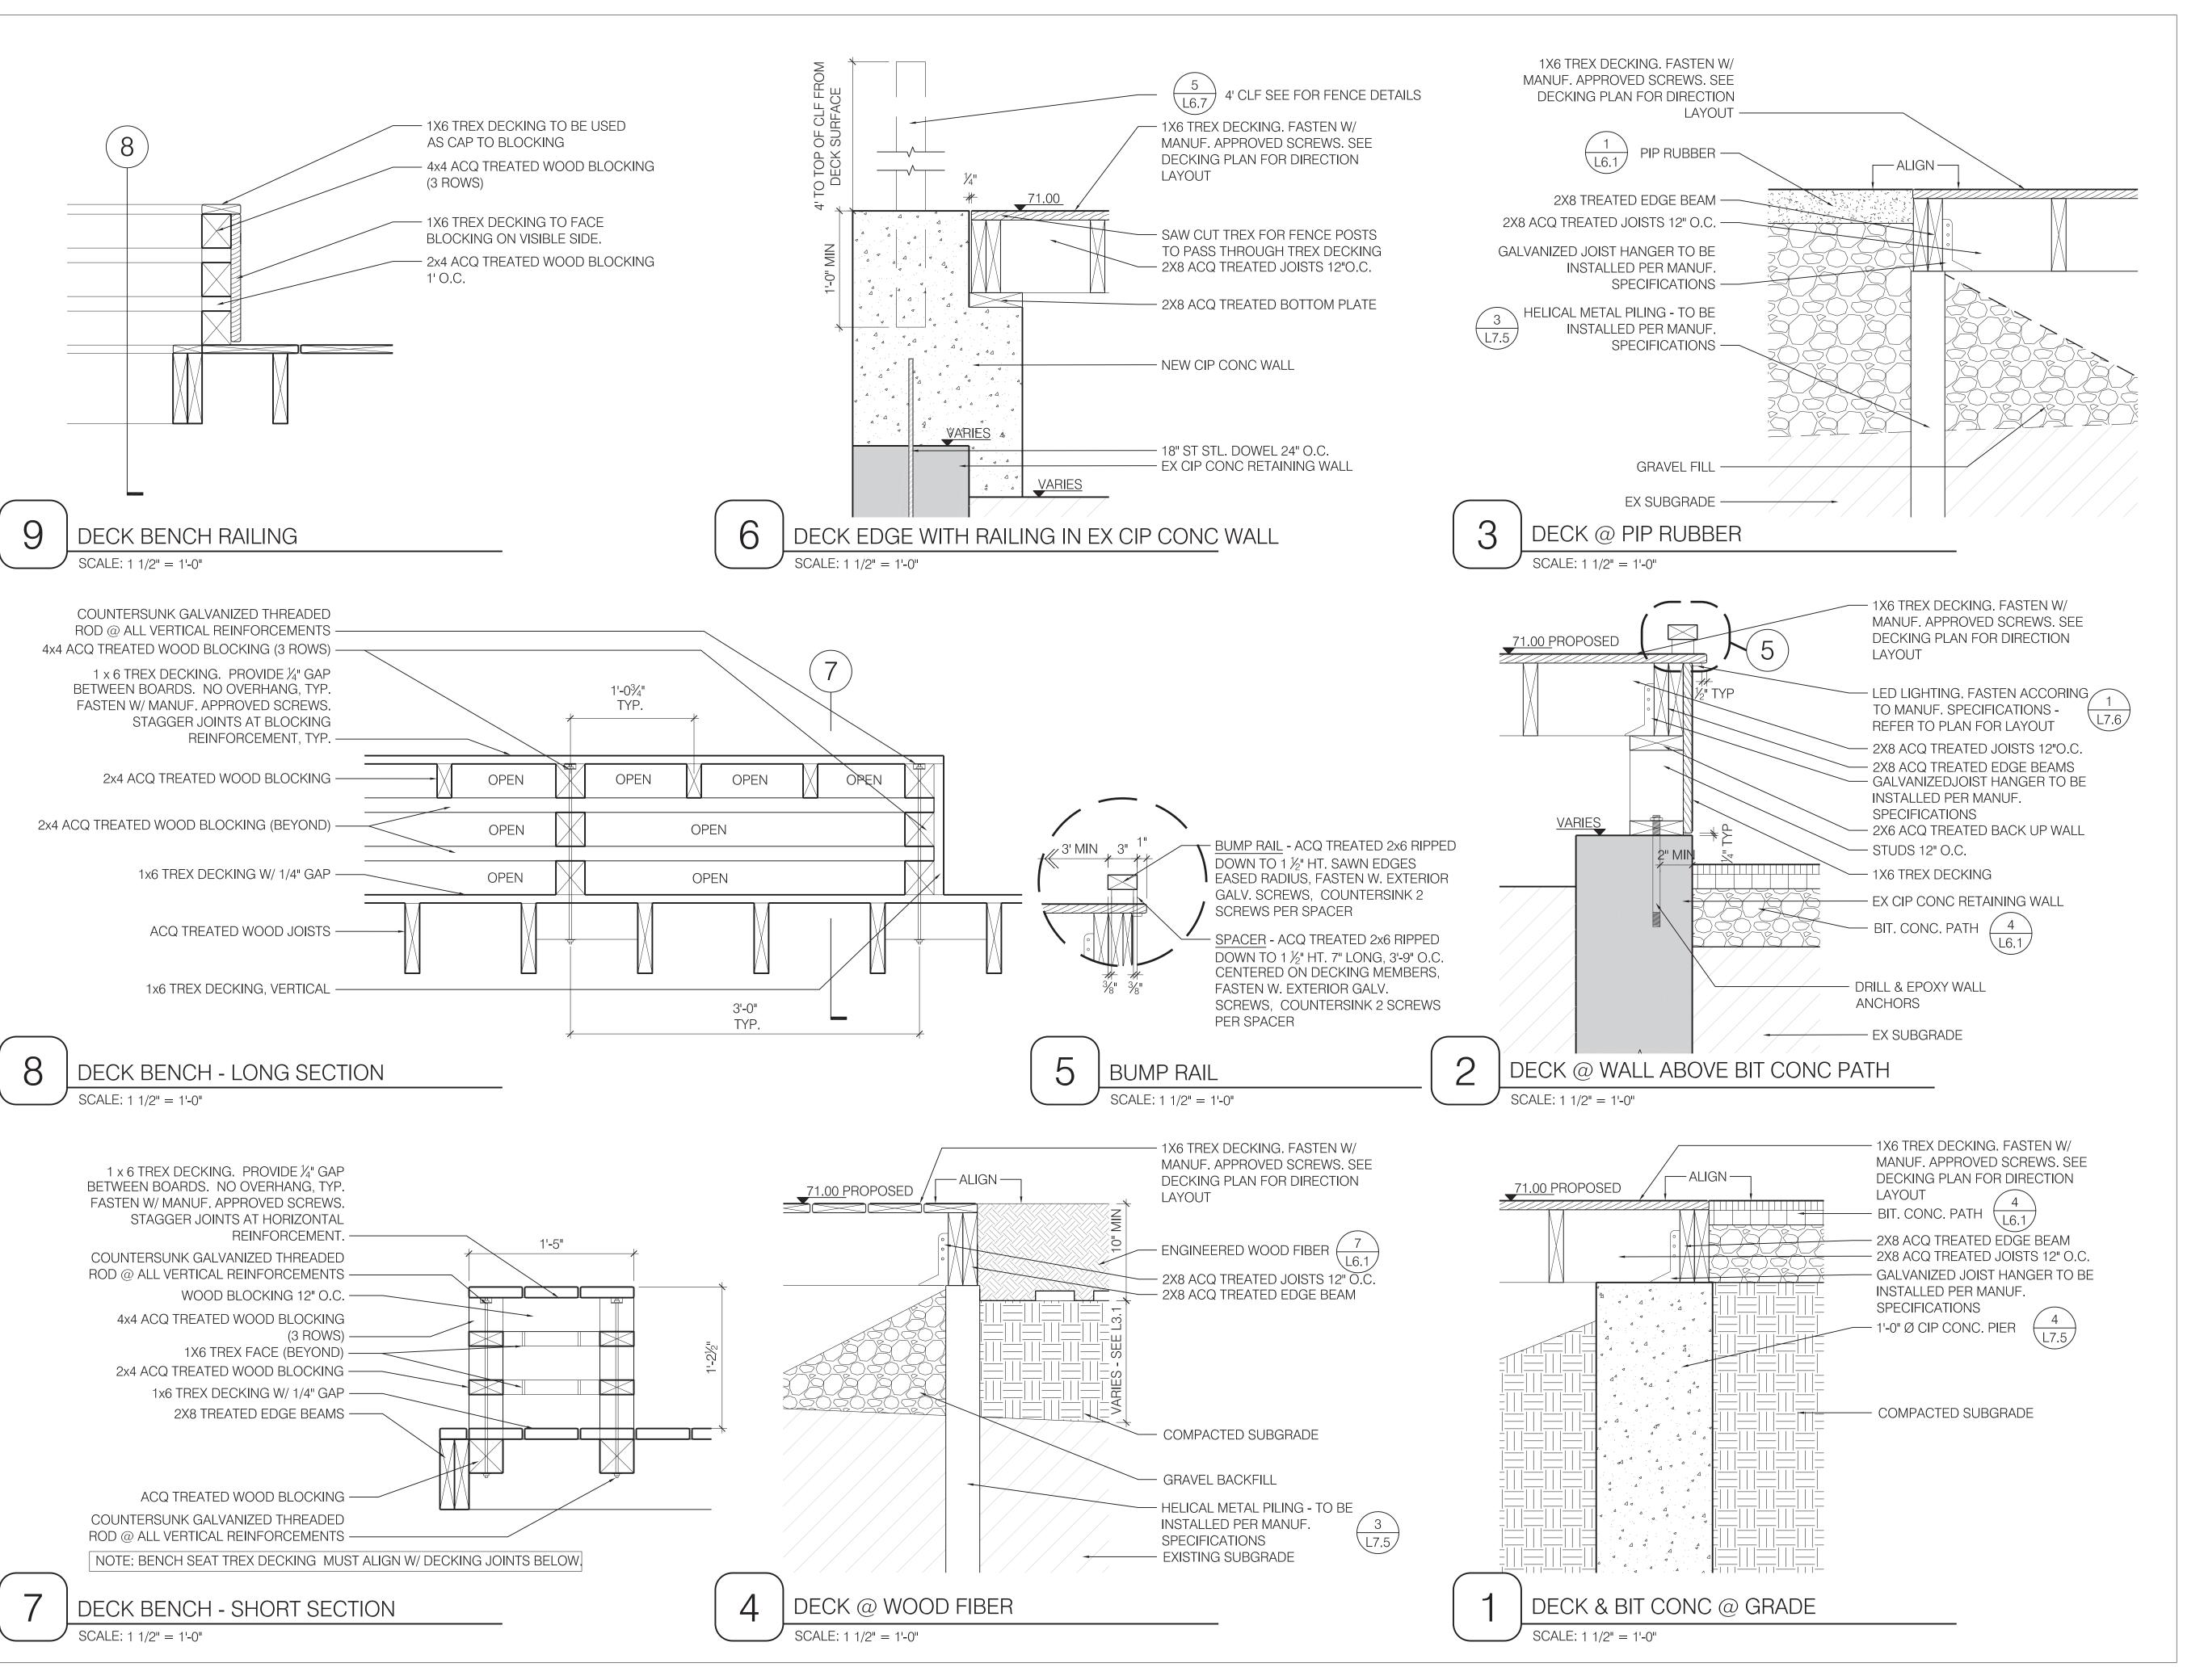
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