73 SUMMER STREET

SOMERVILLE, MA

NOVEMBER 12, 2021 DEVELOPMENT REVIEW SUBMISSION

PROJECT RENDERING





C-6

A000	COVER SHEET	<u>LANDSCAPE</u>
<u>SURVEY</u>		L1 L2
EXISTING CONDITION	DNS - SURVEY PLAN	L3 L4
CIVIL		LD1
C-1 C-2	SITE LAYOUT PLAN GRADING AND UTILITY PLAN	ARCHITECTUR
C-2 C-3 C-4	CONSTRUCTION DETAILS SHEET 1 OF 2 CONSTRUCTION DETAILS SHEET 2 OF 2	A010 A100

EROSION & SEDIMENTATION CONTROL PLAN

TREE MITIGATION PLAN

LANDSCAPE SITE PLAN LANDSCAPE PLANTING PLAN **GREEN SCORE** DEPAVE PLAN LANSCAPE DETAILS

SITE LAYOUT & LIGHTING PLAN BASEMENT LEVEL PLAN FIRST LEVEL FLOOR PLAN A102 SECOND LEVEL FLOOR PLAN

<u>ARCHITECTURE</u>

THIRD LEVEL FLOOR PLAN A104 ROOF PLAN A201 BUILDING ELEVATIONS A202 BUILDING ELEVATIONS A203 PARTIAL BUILDING ELEVATIONS A204 SIGNAGE ELEVATIONS A301 **BUILDING PERSPECTIVES** A302 BUILDING PERSPECTIVES A303 BUILDING PERSPECTIVES A304 ALTERNATE COLOR EXPLORATIONS ALTERNATE DESIGN OPTIONS A305

<u>LIGHTING</u>

SITE LIGHTING PLAN/PHOTOMETRIC STUDY

LOCUS MAP



ZONING REVIEW

SOMERVILLE ZONING DISTRICT: MID RISE 3 (APARTMENT BUILDING) LOT SIZE: 14,573 SF +/-



MR-3 - MID RISE UR - URBAN RESIDENTIAL

NR - NEIGHBORHOOD RESIDENTIAL

DIMENSIONAL TABLE

	ALLOWABLE	PROPOSED
HEIGHT	38'-0" (3 STORIES)	37'-10" (3 STORIES)
FRONT YARD	2'-0"	FRONT YARD 1 (SUMMER): 3'-6" FRONT YARD 2 (SCHOOL): 5'-0"
SIDE YARD	0'-0"	SIDE YARD 1: 3'-6" SIDE YARD 2: 5'-0"
REAR YARD	N/A	N/A
LOT COVERAGE	90% MAX (12,960 SF)	81% (11,842 SF)
D.U. COUNT		
BUILDING GSF 1,125 GSF/UNIT	$\frac{30,832 \text{ GSF}}{1,125 \text{ GSF/UNIT}} = 27.4$	27 DWELLING UNITS
OPEN SPACE	15% LOT AREA (2,185 SF)	17.4% LOT AREA (2,539 SF)
GREEN SCORE	0.25 (0.30 IDEAL)	0.27
PARKING	1 PER D.U. MAX (27 SPACES)	18 SPACES TOTAL (7 EV SPACES)
BIKE PARKING	N/A	2.0/D.U.

| ARCHITECT **EMBARC**

FIRST SUMMER 73, LLC 20 WOODWARD STREET NEWTON, MA

CONSULTANTS

CIVIL ENGINEERING / SURVEY MCKENZIE ENGINEERING 150 LONGWATER DRIVE, SUITE 101 NORWELL, MA 02061 781.792.3900

318 HARVARD STREET, SUITE 25 BROOKLINE, MA 02446 617.735.1180

SUBMISSION REVIEW STREE

REVISIONS

MARK ISSUE DATE


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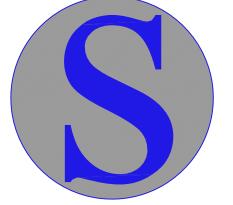


DRAWING INFORMATION ISSUE: <u>DEVELOPMENT REVIEW SUBMISSION</u>

NOVEMBER 12, 2021 PROJECT #: 20027

DRAWING TITLE



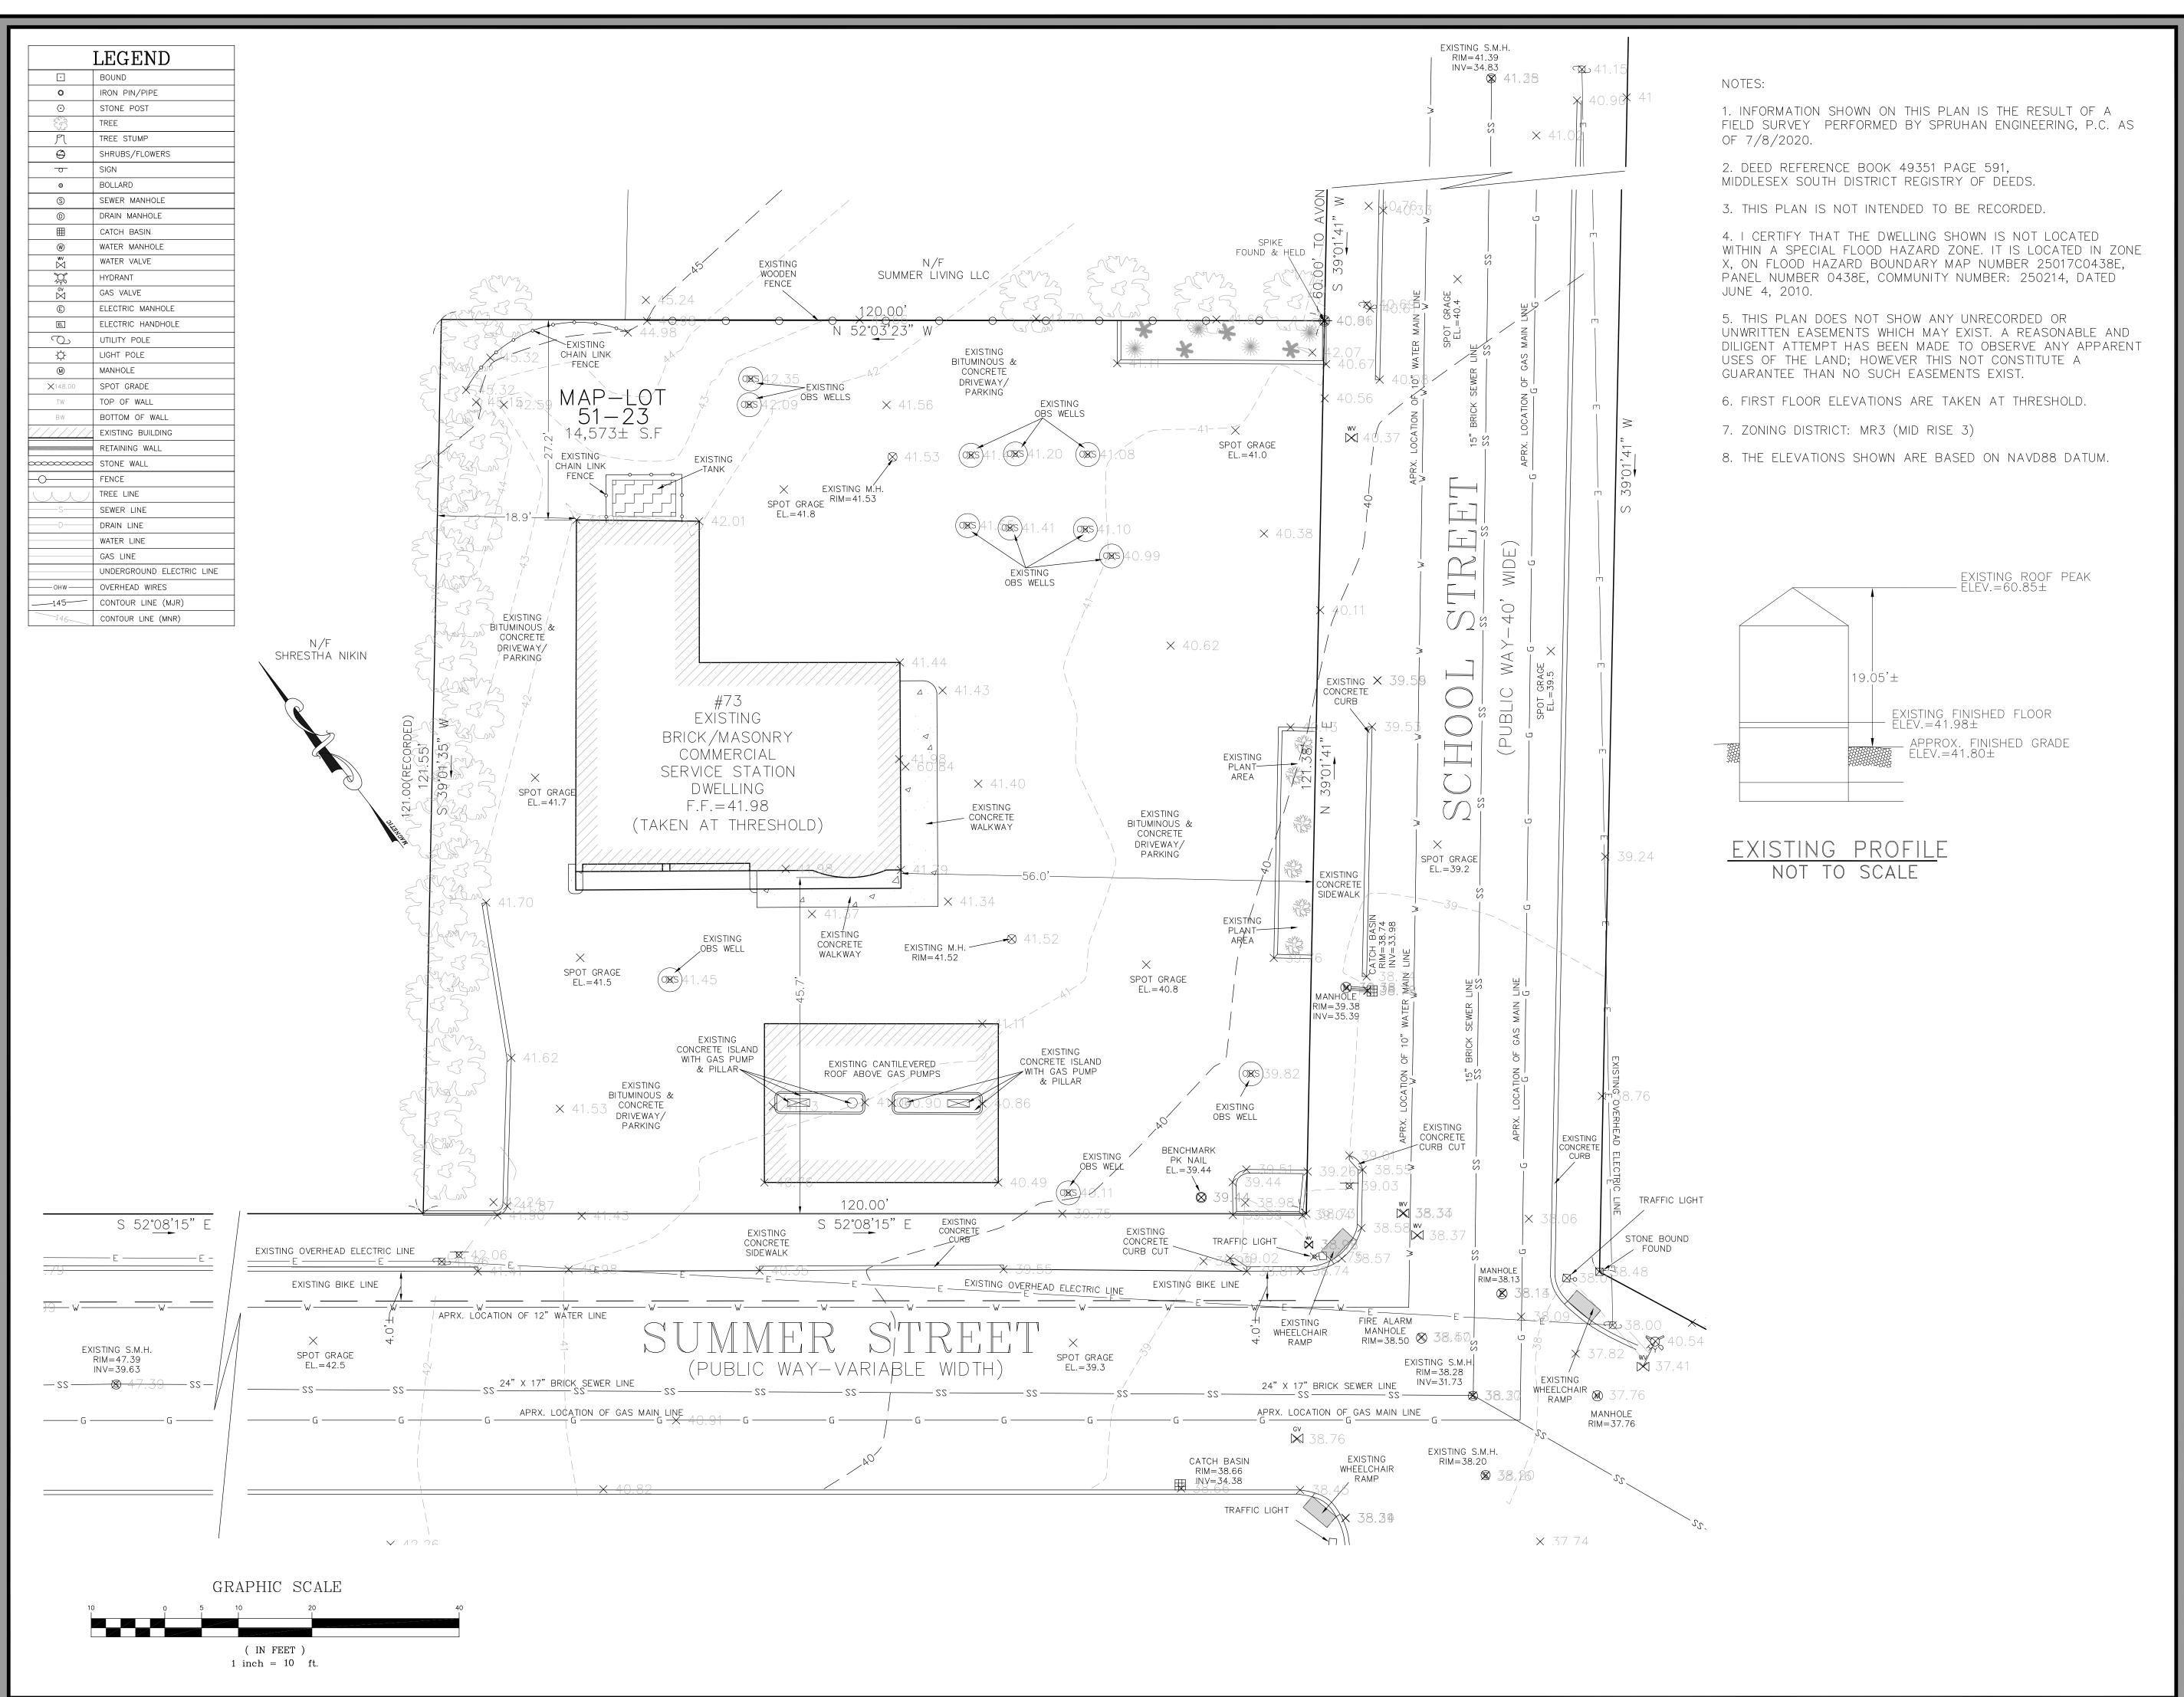

Spruhan Engineering, P.C.

> 80 JEWETT ST, (SUITE 2) NEWTON, MA 02458

Email:espruhan@gmail.com

Tel: 617-816-0722

73 SUMMER STREET SOMERVILLE MASSACHUSETTS

SURVEY PLAN

REVISION BLOCK

DESCRIPTION	DAT


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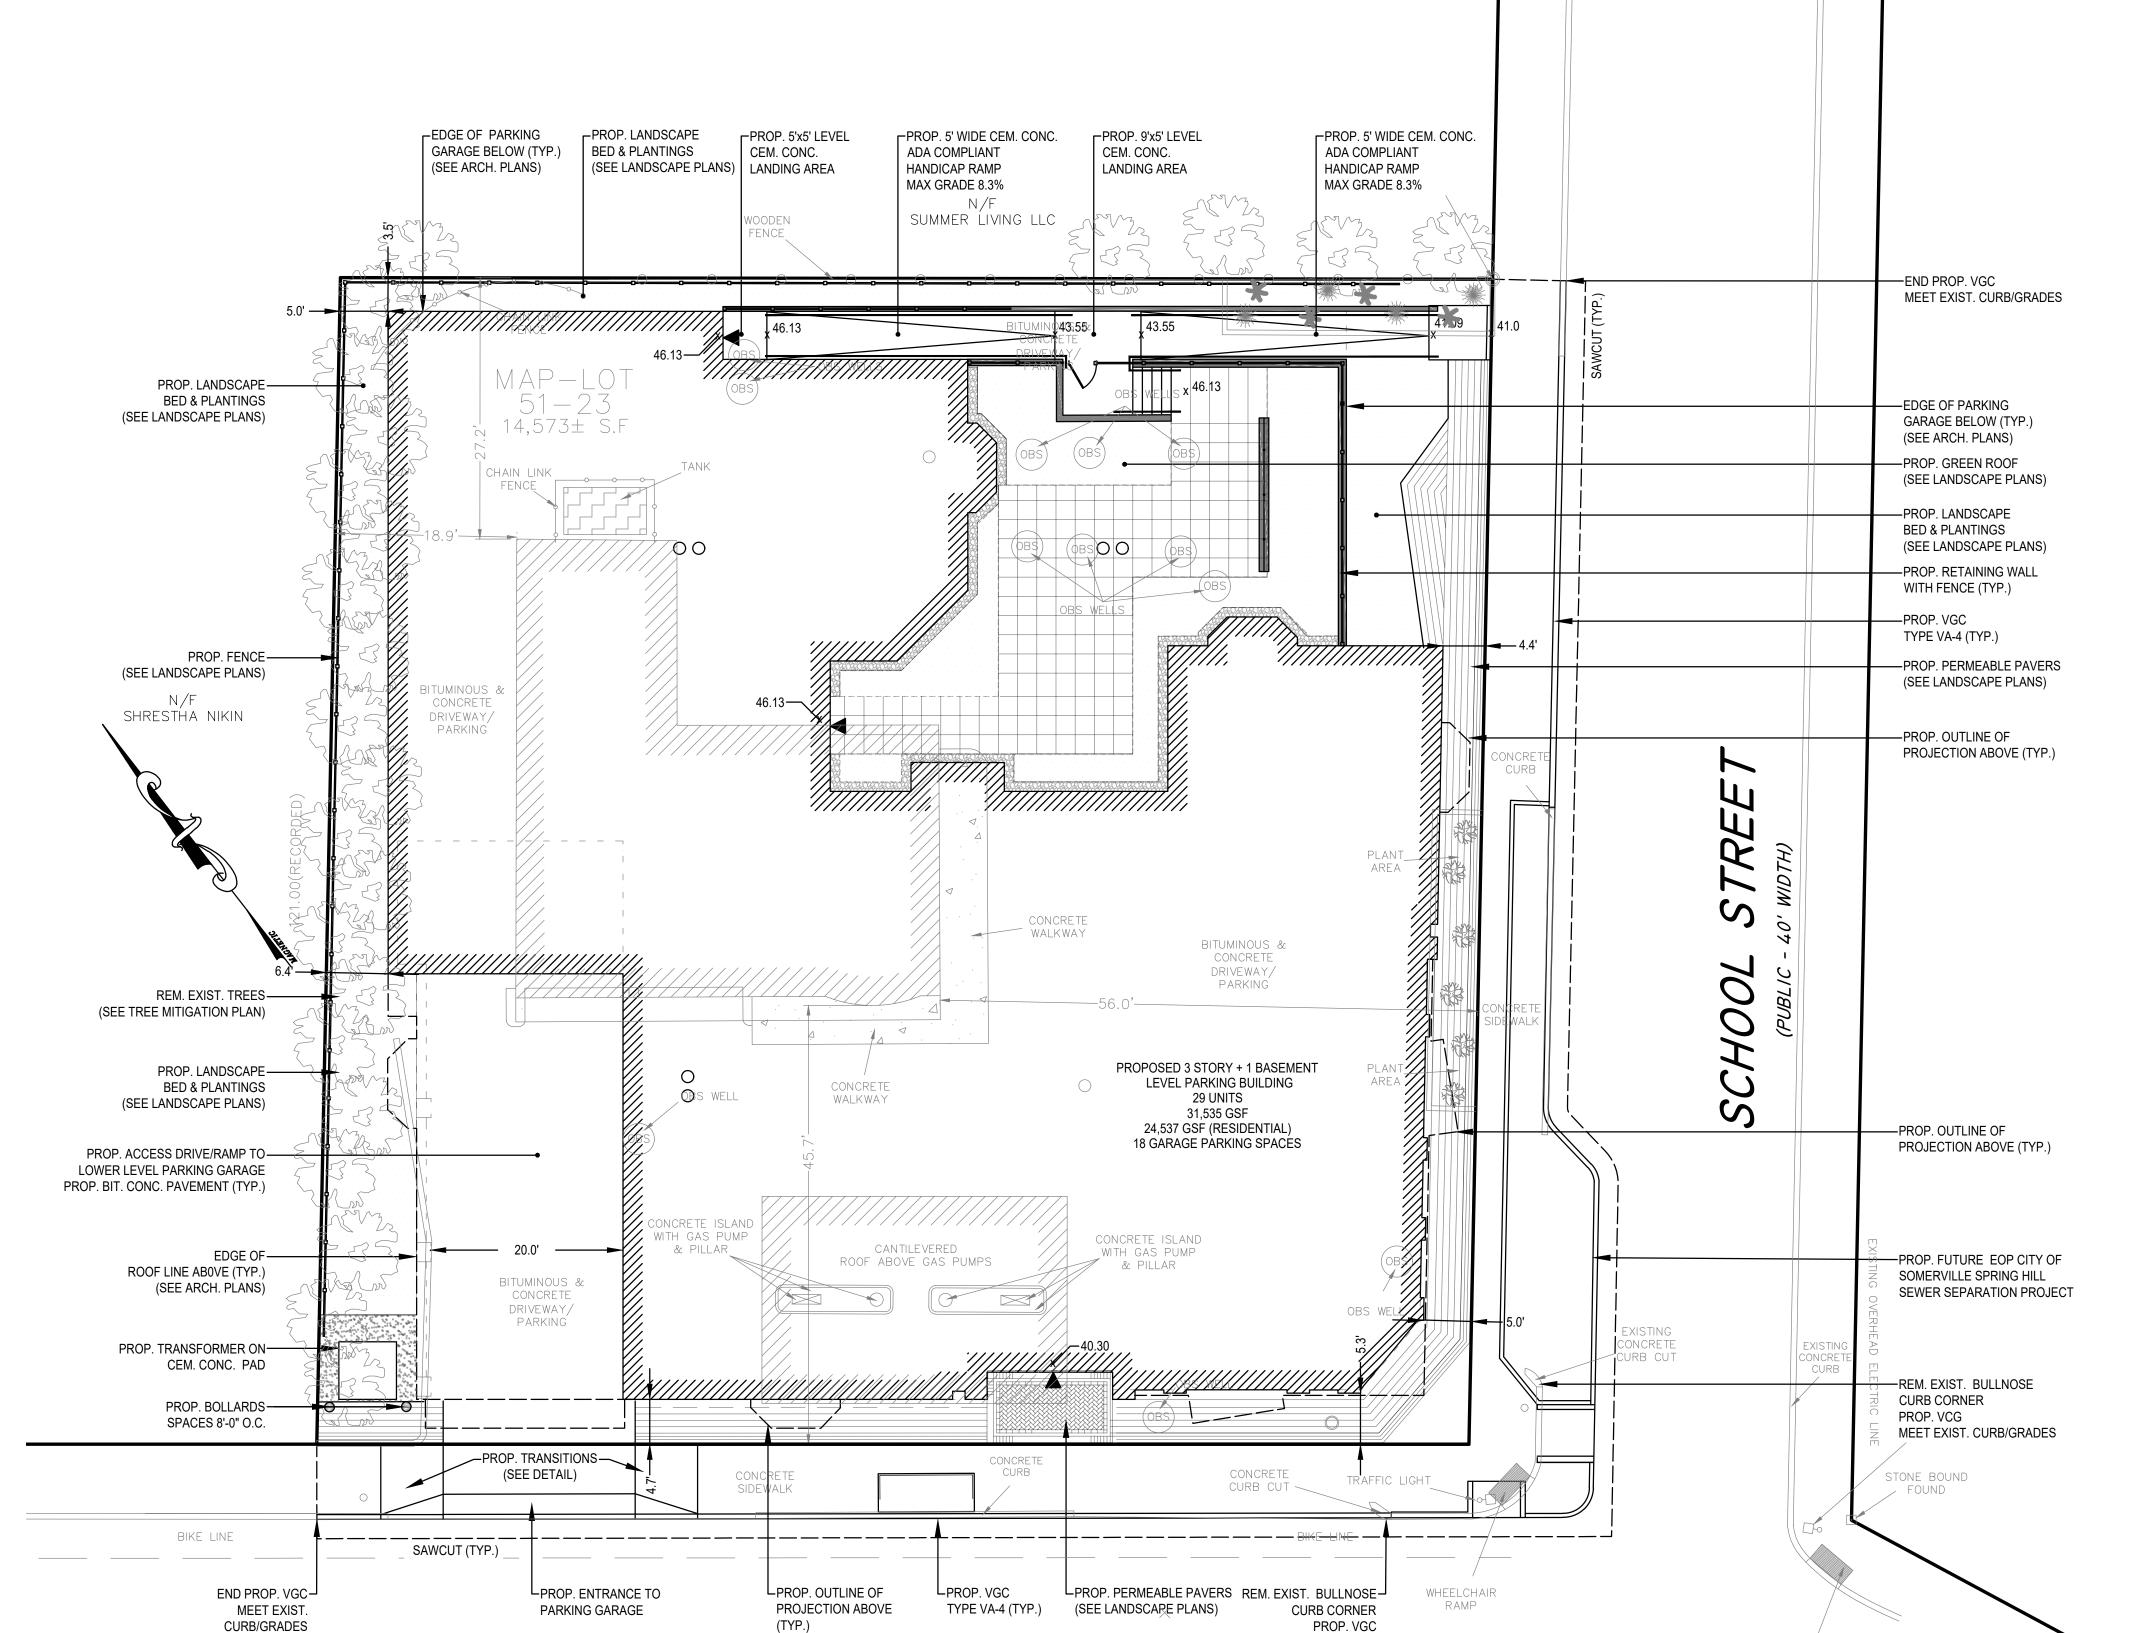
DATE: 7/13/2020
DRAWN BY: K.K
CHECKED BY: E.S
APPROVED BY: C.C

EXISTING CONDITIONS

SHEET 1 OF




SCALE 1" = 800'

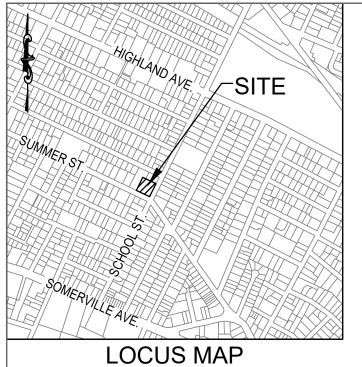

SUMMER STREET

(PUBLIC - VARIABLE WIDTH)

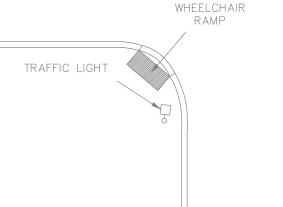

WHEELCHAIR RAMP

MEET EXIST. CURB/GRADES

SURVEY NOTES:

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- 3. DEED REFERENCE BOOK 49351 PAGE 591, MIDDLESEX SOUTH DISTRICT REGISTRY OF DEEDS.
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- 5. THE DWELLING SHOWN IS NOT LOCATED WITHIN A SPECIAL FLOOD HAZARD ZONE. IT IS LOCATED IN ZONE X, ON FLOOD HAZARD BOUNDARY MAP NUMBER 25017C0438E, PANEL NUMBER 0438E, COMMUNITY NUMBER: 250214, DATED JUNE 4,
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- 8. ELEVATIONS BASED ON NAVD88 DATUM

	LEGEND
۰	BOUND
0	IRON PIN/PIPE
\bigcirc	STONE POST
63	TREE
A	TREE STUMP
	SHRUBS/FLOWERS
-0-	SIGN
•	BOLLARD
S	SEWER MANHOLE
(D)	DRAIN MANHOLE
	CATCH BASIN
W	WATER MANHOLE
WV 	WATER VALVE
\	HYDRANT
GV	GAS VALVE
E	ELECTRIC MANHOLE
EL	ELECTRIC HANDHOLE
	UTILITY POLE
\	LIGHT POLE
M	MANHOLE
×148.00	EXISTING SPOT GRADE
TW	TOP OF WALL
BW	BOTTOM OF WALL
	EXISTING BUILDING
	RETAINING WALL
	STONE WALL
<u> </u>	FENCE
	TREE LINE
S	SEWER LINE
D	DRAIN LINE
W	WATER LINE
G	GAS LINE
E	UNDERGROUND ELECTRIC LINE
——— OHW ———	OVERHEAD WIRES
145	CONTOUR LINE (MJR)
146	CONTOUR LINE (MNR)

| ARCHITECT

BOSTON, MA 02127 O: 617.766.8330 www.embarcstudio.com

OWNER

FIRST SUMMER 73, LLC 20 WOODWARD STREET NEWTON, MA

CONSULTANTS

CIVIL ENGINEERING / SURVEY

MCKENZIE ENGINEERING GROUP

150 LONGWATER DRIVE, SUITE 101 NORWELL, MA 02061 781.792.3900

LANDSCAPE ARCHITECT

VERDANT


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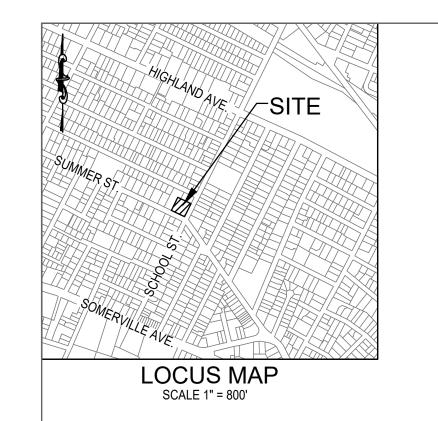
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PROJECT #: 20027

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SITE LAYOUT PLAN






PROP. GRASSED-SWALE (TYP.)

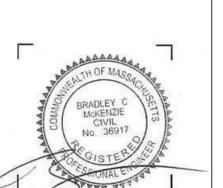SHRESTHA NIKIN

OVERHEAD ELECTRIC LINE +

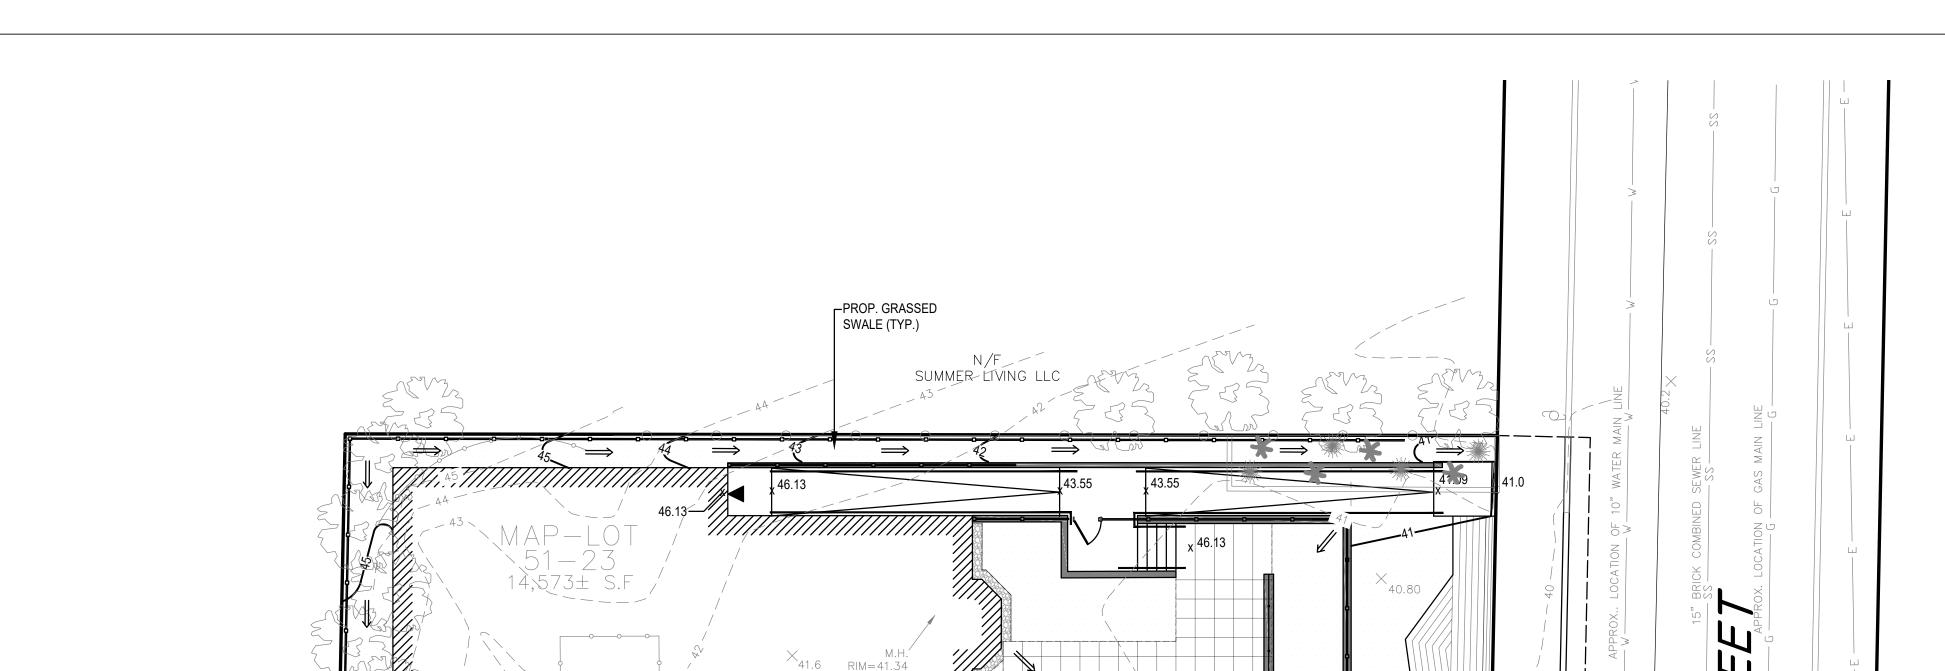

PROPOSED 3 STORY + 1 BASEMENT

31,535 GSF

24,537 GSF (RESIDENTIAL) 18 GARAGE PÄRKING SPACÉS

> PROP. ROOF DRAIN W/OVERFLOW PIPE

> > PROP. 12" DI-

ROOF DRAIN

LPROP. 6" SEWER SERVICE (PVC SDR-35)

PROP. 12" HDPE DRAIN

CHIMNEY CONNECTION TO MEET GRADE FOR FUTURE CONNECTION TO

DEDICATED DRAIN LINE (TYP.)

CHIMNEY CONNECTION (TYP.)

(SIZE TO BE DETERMINED BY GAS COMPANY)

LPROP. GAS SERVICE

FIRE ALARM M.H.RIM = 38.31

LEVEL PARKING BUILDING 29 UNITS

-PROP. ROOF DRAIN-W/OVERFLOW PIPE

EXISTING BRICK/MASONRY COMMERCIAL SERVICE STATION

DWELLING

(TA'KEN AT THRESHOLD)

PROP. ROOF DRAIN

W/OVERFLOW PIPE

15" PVC SD

REFER TO PLUMBING PLANS FOR-ALL PIPING AND APPURTENANCES

PROP. DI FIRE PROTECTION

WATER SERVICE (CL 52)

(SIZE TO BE DETERMINED)

PROP. DI TAPPING SLEEVE

AND VALVE BOX (TYP.)

PROP. DI DOMESTIC WATER

(SIZE TO BE DETERMINED)

TO BRANCH OFF PROP. FIRE SERVICE

SERVICE (CL 52)

F.F. = 41.79

APPROX. LOCATION OF 12" WATER LINE

24" X 17" BRICK COMBINED SEWER LINE

APPROX. LOCATION OF GAS MAIN LINE

SUMMER STREET

(PUBLIC - VARIABLE WIDTH)

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- GUARANTEE THAN NO SUCH EASEMENTS EXIST. 7. ZONING DISTRICT = MR3 (MID RISE 3)
- DEDICATED DRAIN LINE IS FROM THE CITY OF SOMERVILLE SPRING HILL SEWER SEPARATION PROJECT AREA 1, PREPARED BY STANTEC, DATED OCTOBER 13, 2020.

	LEGEND
•	BOUND
0	IRON PIN/PIPE
 	STONE POST
63	TREE
ñ	TREE STUMP
(Z)	SHRUBS/FLOWERS
-0	SIGN
•	BOLLARD
S	SEWER MANHOLE
(D)	DRAIN MANHOLE
Ш	CATCH BASIN
W	WATER MANHOLE
wv 	WATER VALVE
X,	HYDRANT
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——————————————————————————————————————	OVERHEAD WIRES
145	CONTOUR LINE (MJR)
146	CONTOUR LINE (MNR)

-PROP. 12" HDPE DRAIN

CHIMNEY CONNECTION TO MEET

DEDICATED DRAIN LINE (TYP.)

GRADE FOR FUTURE CONNECTION TO

PROP. FUTURE DEDICATED DRAIN LINE AND DRAINAGE STRUCTURES CITY OF SOMERVILLE SPRING HILL

SEWER SEPARATION PROJECT

M.H. RIM=37.57

-PROP. FUTURE DEDICATED DRAIN LINE

AND DRAINAGE STRUCTURES

CITY OF SOMERVILLE SPRING HILL

SEWER SEPARATION PROJECT

| ARCHITECT EMBARC 60 K STREET, 3RD FLOOR

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OWNER

FIRST SUMMER 73, LLC 20 WOODWARD STREET NEWTON, MA

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LANDSCAPE ARCHITECT


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8. ELEVATIONS BASED ON NAVD88 DATUM


9. INFORMATION REGARDING THE PROPOSED





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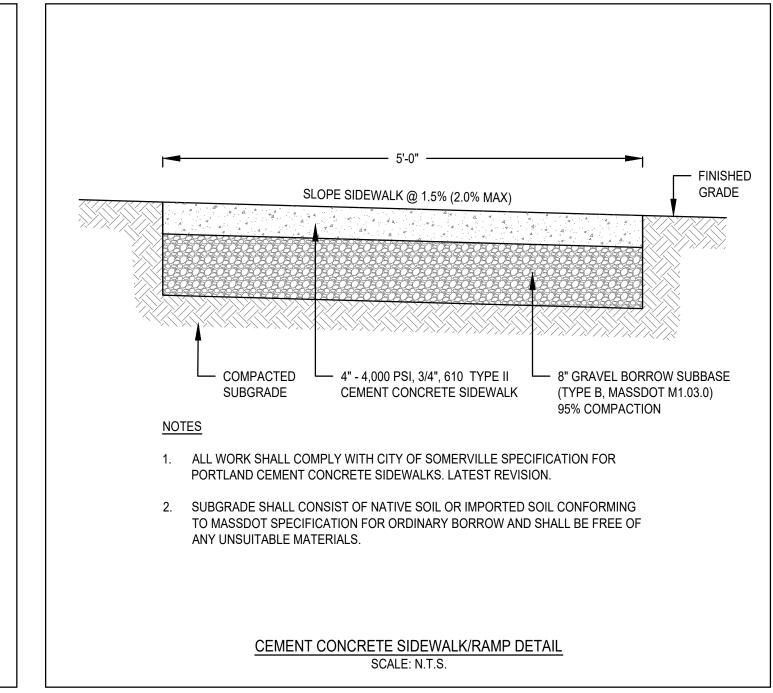
GRADING & UTILITY PLAN


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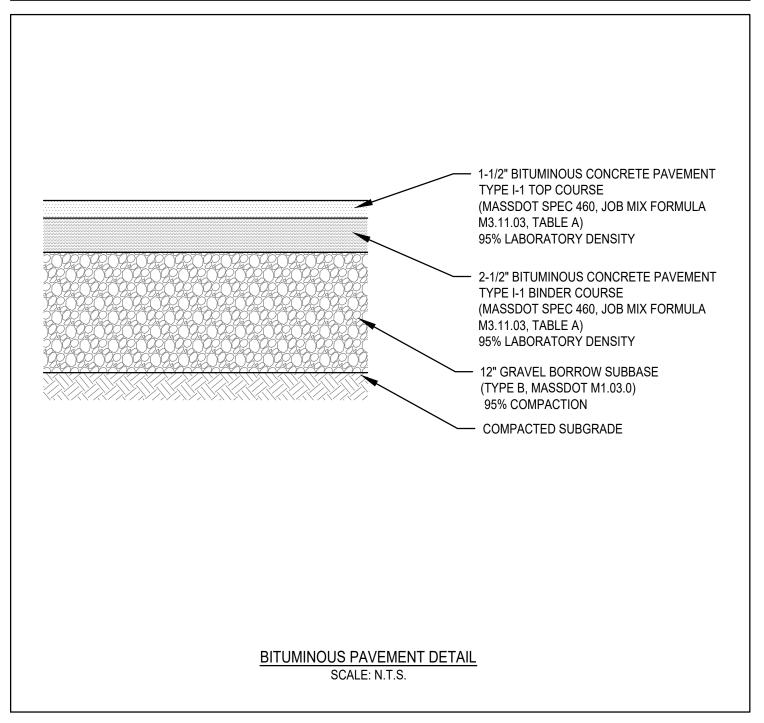


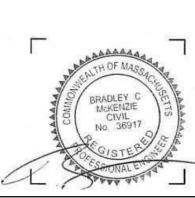


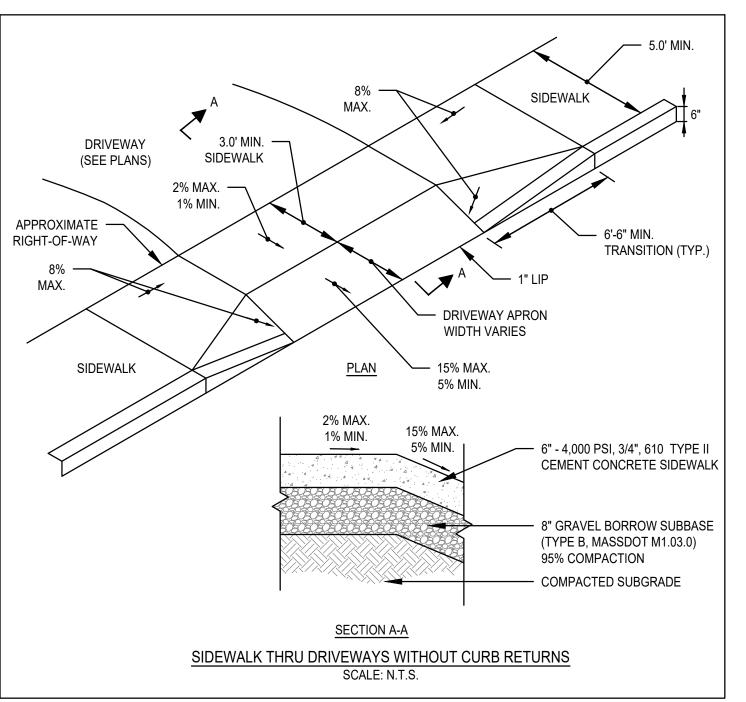


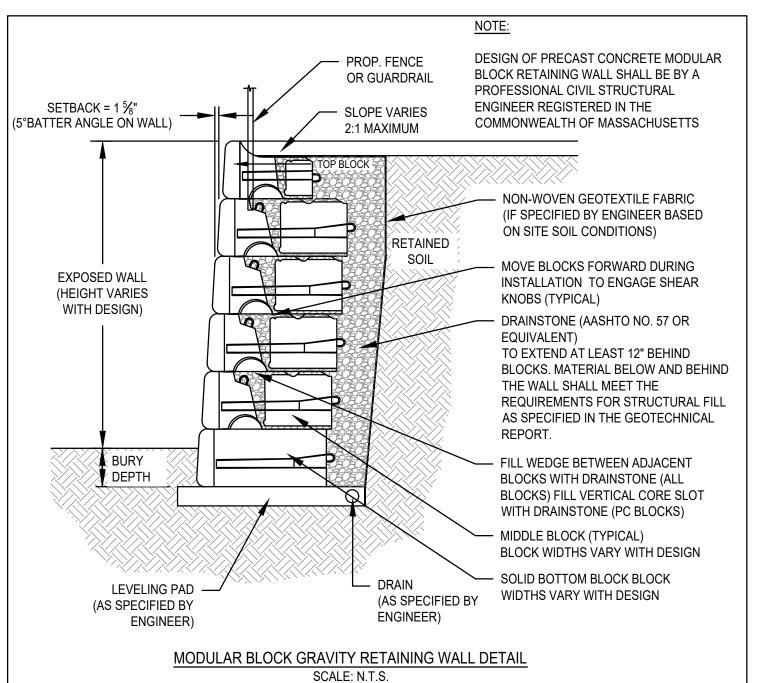

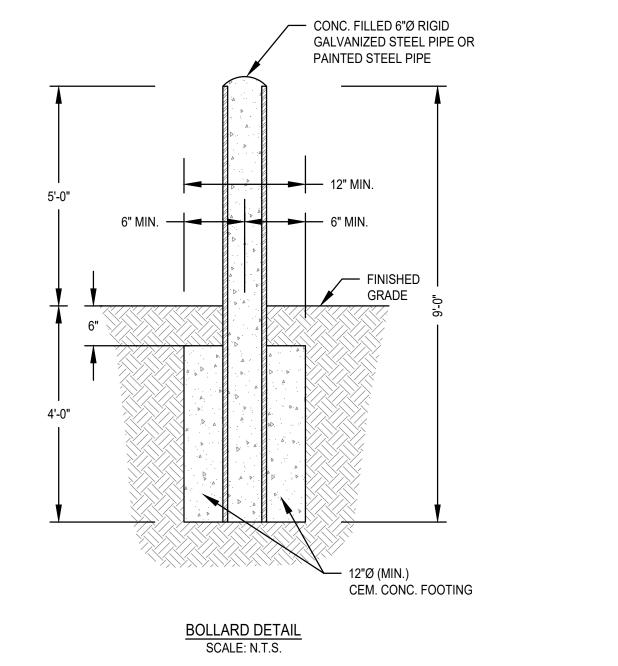

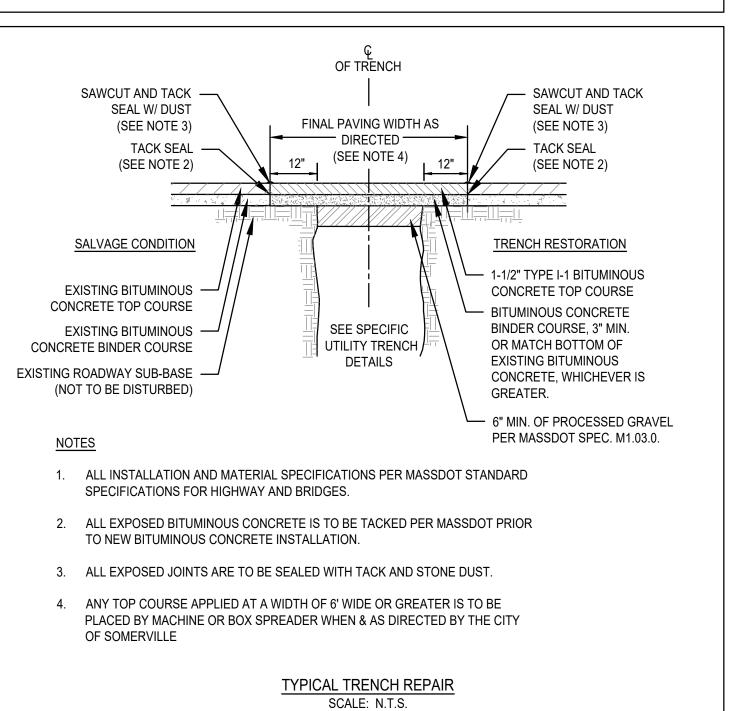

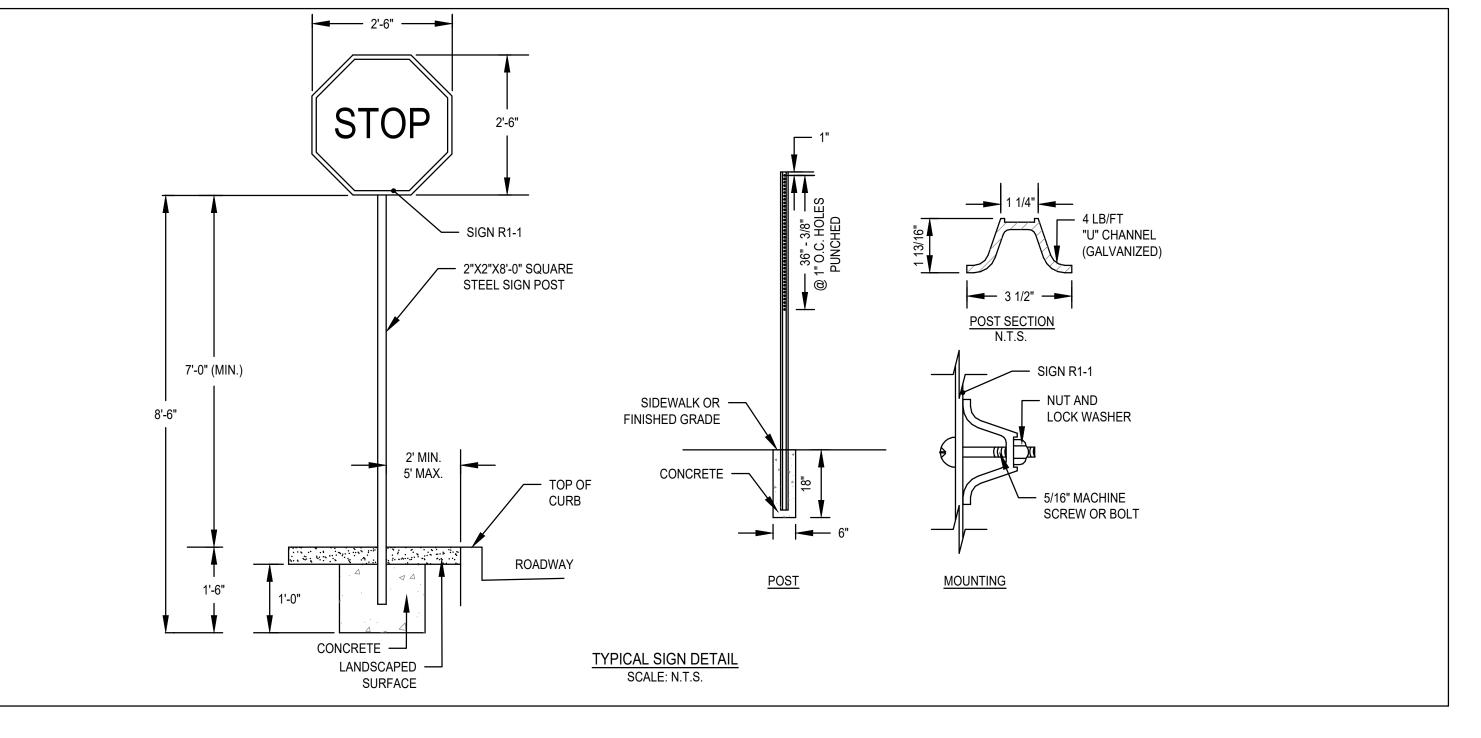

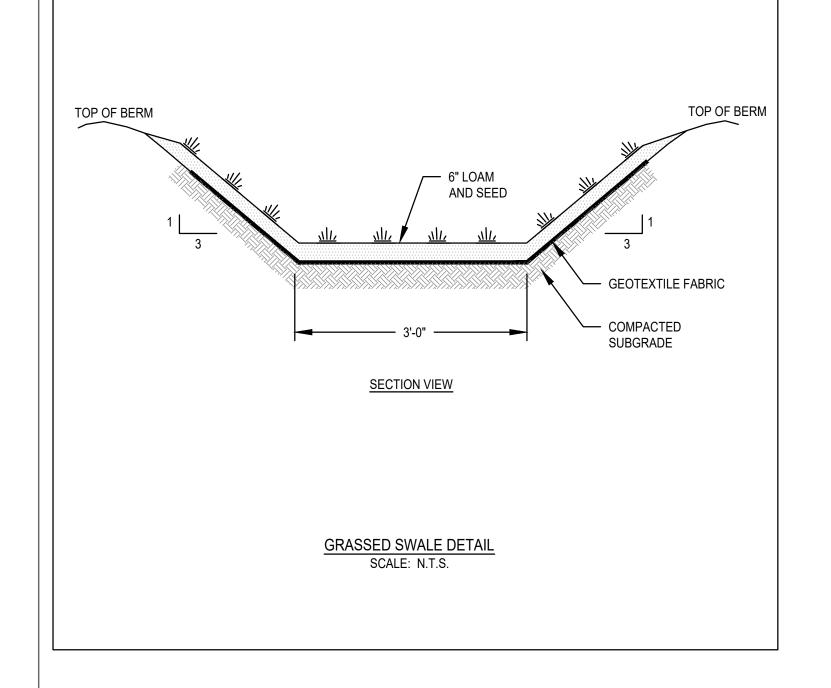



DETAILS

DRAWING NUMBER

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SHEET 1 OF 2

| ARCHITECT

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FIRST SUMMER 73, LLC

20 WOODWARD STREET NEWTON, MA

CIVIL ENGINEERING / SURVEY

150 LONGWATER DRIVE, SUITE 101

MCKENZIE ENGINEERING GROUP

<u>S</u>

O: 617.766.8330

CONSULTANTS

NORWELL, MA 02061

LANDSCAPE ARCHITECT

BROOKLINE, MA 02446

318 HARVARD STREET, SUITE 25

781.792.3900


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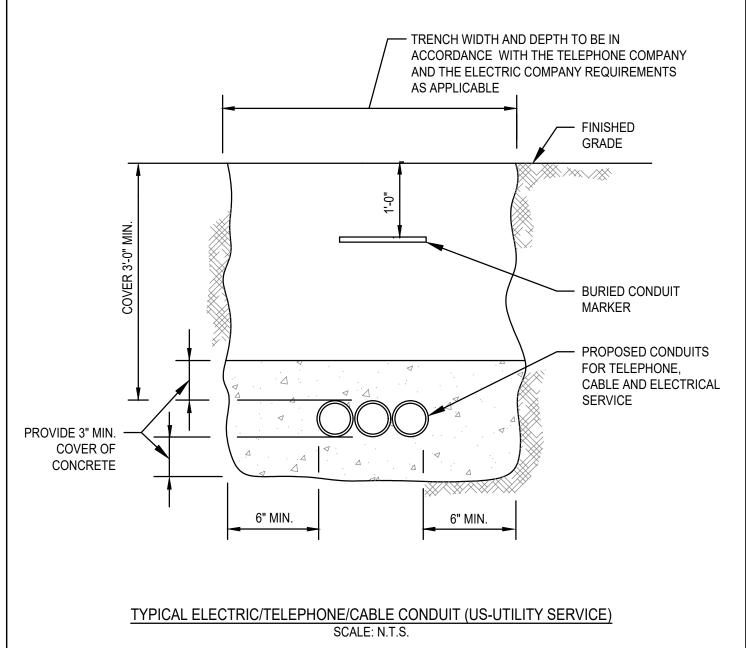
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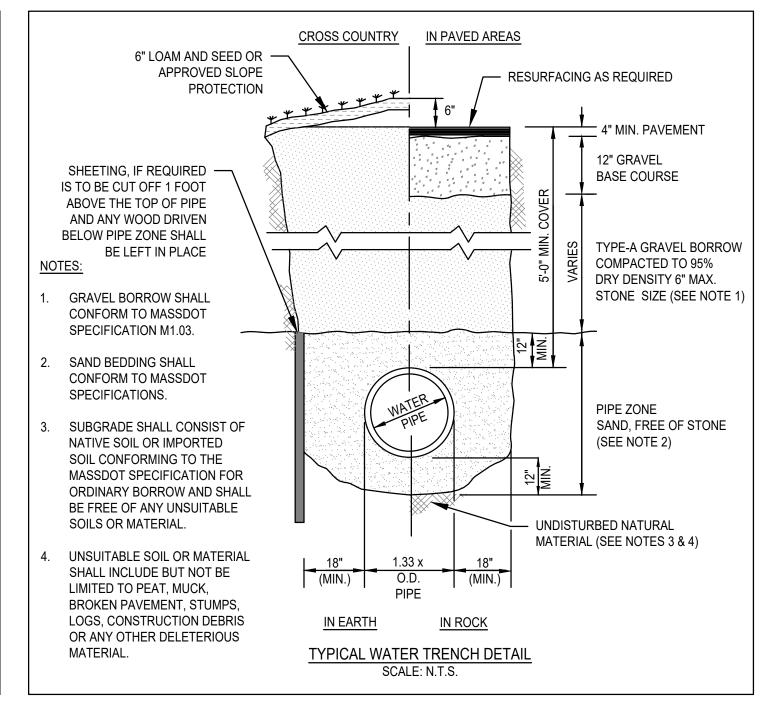
OWNER

GENERAL UTILITY NOTES

- THE CONTRACTOR IS SPECIFICALLY CAUTIONED THAT THE LOCATION AND/OR ELEVATION OF EXISTING UTILITIES AND STRUCTURES AS SHOWN ON THESE PLANS IS BASED ON RECORDS OF VARIOUS UTILITY COMPANIES AND WHERE POSSIBLE, MEASUREMENTS TAKEN IN THE FIELD. THIS INFORMATION IS NOT TO BE RELIED UPON AS BEING EXACT OR COMPLETE. THE LOCATION OF ALL UNDERGROUND UTILITIES AND STRUCTURES SHALL BE VERIFIED IN THE FIELD BY THE CONTRACTOR PRIOR TO THE START OF CONSTRUCTION. THE CONTRACTOR MUST CONTACT THE APPROPRIATE UTILITY COMPANY, ANY GOVERNING PERMITTING AUTHORITY, AND "DIGSAFE" AT LEAST 72 HOURS PRIOR TO ANY EXCAVATION WORK TO REQUEST EXACT FIELD LOCATION OF UTILITIES AND THE ENGINEER SHALL BE NOTIFIED IN WRITING OF ANY UTILITIES INTERFERING WITH THE PROPOSED CONSTRUCTION AND APPROPRIATE REMEDIAL ACTION TAKEN BEFORE PROCEEDING WITH THE WORK. IT SHALL BE THE RESPONSIBILITY OF THE CONTRACTOR TO RELOCATE ALL EXISTING UTILITIES WHICH CONFLICT WITH THE PROPOSED IMPROVEMENTS SHOWN ON THE PLAN.
- THE CONTRACTOR SHALL BE RESPONSIBLE FOR ESTABLISHING AND MAINTAINING ALL CONTROL POINTS AND BENCHMARKS NECESSARY FOR THE WORK.
- THE CONTRACTOR SHALL EXCAVATE THE TEST PITS IN THE LOCATIONS SHOWN ON THE PLAN PRIOR TO COMMENCING WORK TO VERIFY THE ELEVATIONS AND LOCATIONS OF EXISTING UTILITIES. THE CONTRACTOR SHALL PROVIDE THE OWNER AND ENGINEER WITH THE RESULTS PRIOR TO COMMENCING ANY WORK.
- 4. ALL WATER SERVICES SHALL BE INSTALLED WITH 5' OF COVER EXCEPT AS NOTED OR DETAILED OTHERWISE.
- DOMESTIC WATER SERVICES 2 INCHES AND SMALLER SHALL BE TYPE K COPPER TUBING AND SHALL BE INSTALLED WITH APPROPRIATELY SIZED CORPORATION STOP WITH APPROVED SADDLE, CURB STOP, GATE
- 6. THE CONTRACTOR SHALL PROVIDE INLET PROTECTION, SUCH AS SILT SACKS, AT ALL CATCH BASINS TO PREVENT SEDIMENT FROM ENTERING THE EXTENDED DETENTION WETLAND AREA. INLET PROTECTION WILL ALLOW THE STORM DRAIN INLETS TO BE USED BEFORE FINAL STABILIZATION.
- THE CONTRACTOR SHALL PROVIDE SIEVE ANALYSIS SUBMITTALS TO THE ENGINEER FOR APPROVAL PRIOR TO INSTALLATION OF THE SAND/SILT MATERIAL TO BE USED.







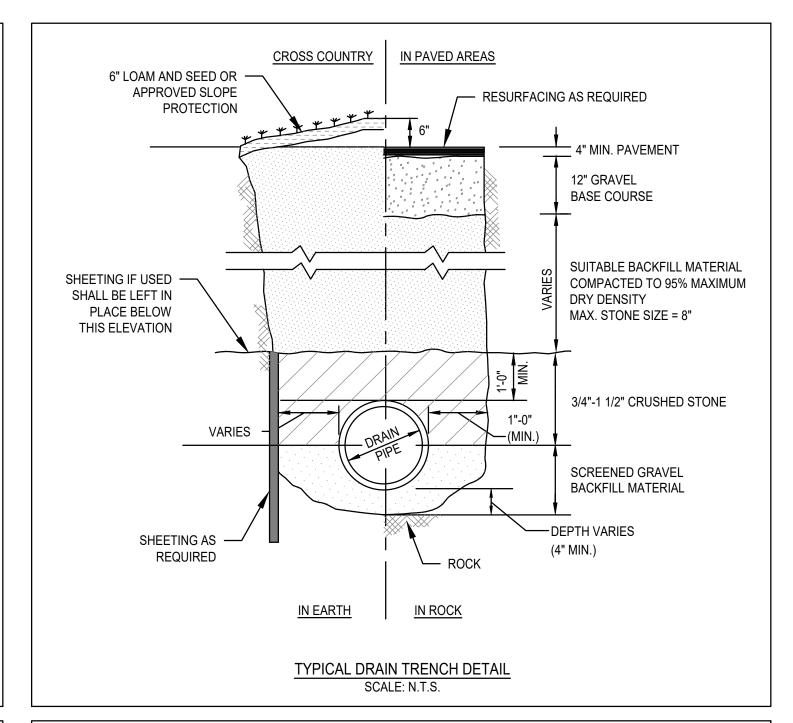



GENERAL NOTES

- 1. IF SHEETING IS USED, IT SHALL BE CUT OFF NO MORE THAN 12" ABOVE TOP OF PIPE.
- 2. ALL PIPES SHALL BE PRESSURE TESTED AT 200 PSI WORKING PRESSURE FOR A MINIMUM DURATION OF TWO
- 3. WATER SYSTEM IS TO BE DISINFECTED TO 50 P.P.M. AVAILABLE CHLORINE AND AFTER 24 HOURS TO 25 P.P.M. OR AS REQUIRED BY PEMBROKE WATER SUPERINTENDENT/ENGINEER.
- 4. WATER PIPE IS TO BE CEMENT LINED DUCTILE IRON "TYTON" OR EQUAL TYPE JOINT, CONFORMING TO A.N.S.I./A.W.W.A. C150/A21.50, CLASS 52, AS APPROVED BY THE TOWN'S WATER SUPERINTENDENT/ENGINEER.
- 5. ALL PIPING SHALL BE INSTALLED AND TESTED IN ACCORDANCE WITH A.W.W.A. STANDARDS PRIOR TO PAVING IF PAVING ABOVE TRENCH IS REQUIRED.
- 6. BACKFILL IS TO BE COMPACTED TO 90% MAXIMUM DRY DENSITY BY AASHTO T-180 D.
- 7. ALL WATER PIPE SHALL BE LAID WITH A MINIMUM OF 5 FEET OF COVER OF APPROVED MATERIALS.
- 8. RESULTS FROM PRESSURE TESTING AND DISINFECTION SHALL BE FURNISHED TO THE DIRECTOR OF PUBLIC WORKS FOR APPROVAL PRIOR TO WATER BEING TURNED ON.
- 9. ALL WORK SHALL BE IN CONFORMANCE WITH PEMBROKE WATER DEPARTMENT STANDARDS.
- 10. ALL PERMITS REQUIRED FOR STREET OPENINGS AND WATER MAIN TAPPING MUST BE OBTAINED.
- 11. NO WATER WILL BE TURNED ON IN THE PROJECT WITHOUT WATER DEPARTMENT APPROVAL

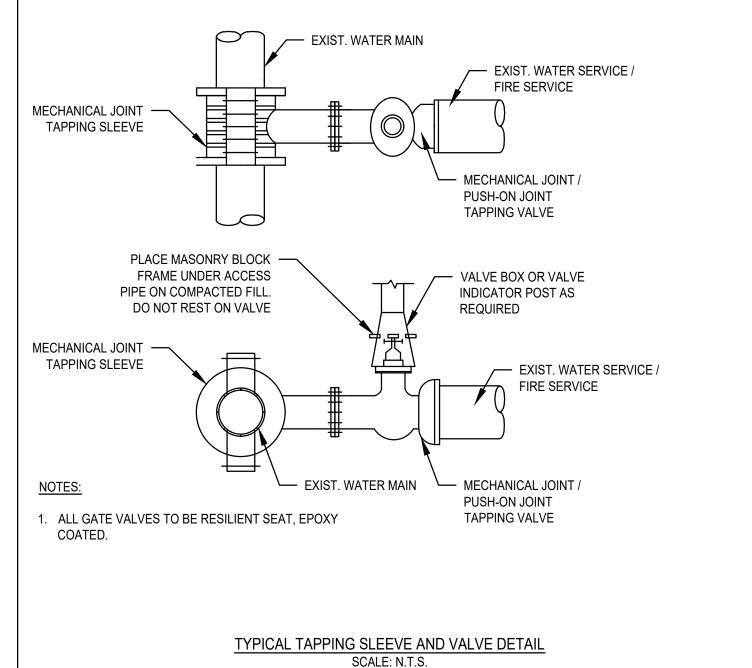

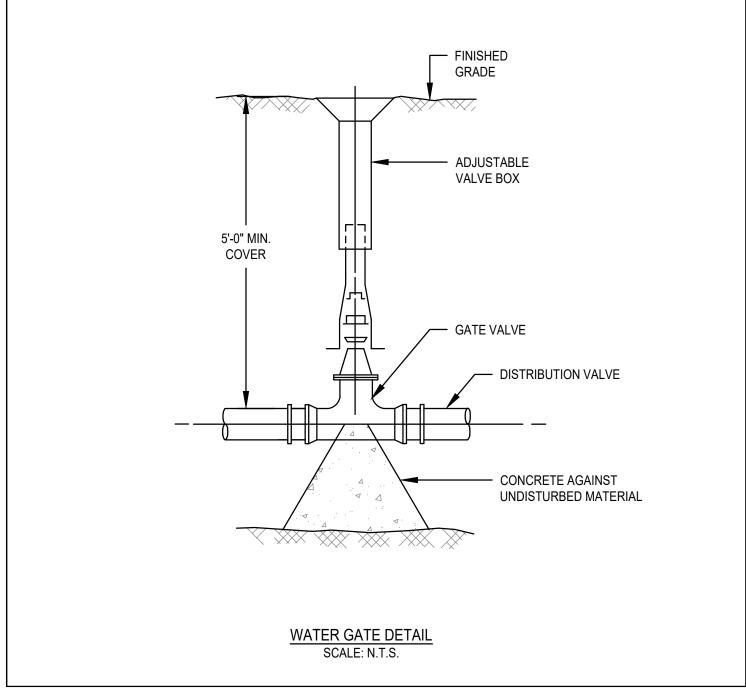

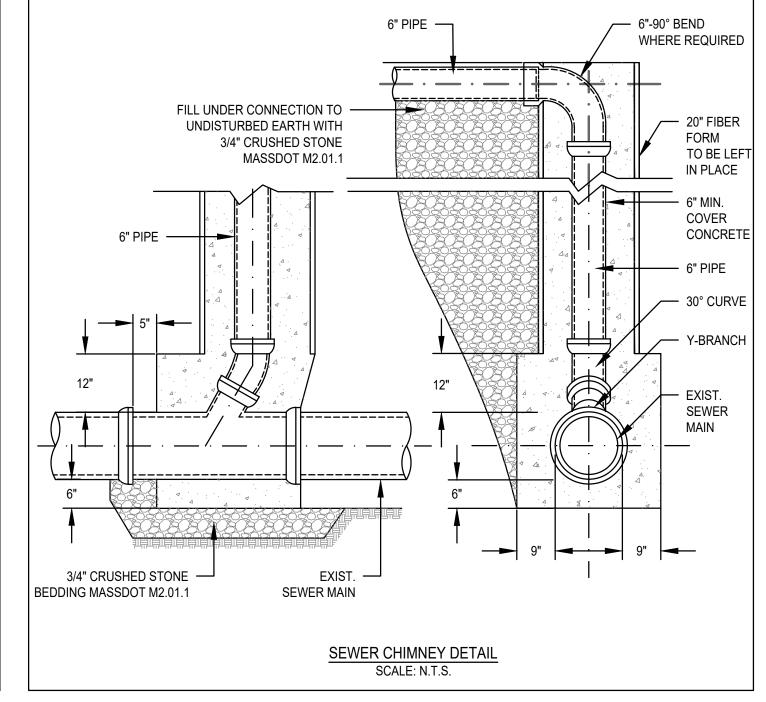

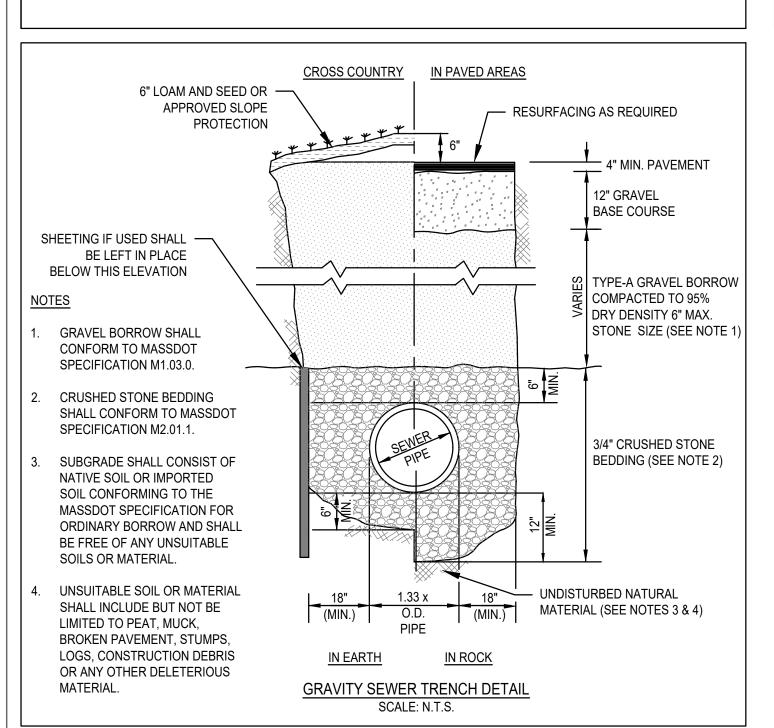



BOSTON, MA 02127 O: 617.766.8330 www.embarcstudio.com

OWNER FIRST SUMMER 73, LLC

CONSULTANTS

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CIVIL ENGINEERING / SURVEY MCKENZIE ENGINEERING GROUP

150 LONGWATER DRIVE, SUITE 101 NORWELL, MA 02061 781.792.3900

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LANDSCAPE ARCHITECT

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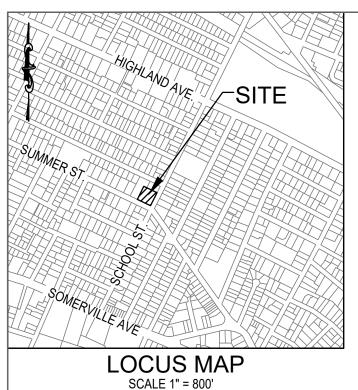
DRAWING INFORMATION

REVISIONS

PROJECT #: 20027

DRAWING TITLE CONSTRUCTION DETAILS

SHEET 2 OF 2 DRAWING NUMBER



SURVEY NOTES:

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CONSTRUCTION SEQUENCE


TO PREVENT EXCESSIVE EROSION AND SILTING, THE FOLLOWING CONSTRUCTION SEQUENCE COUPLED WITH OTHER WIDELY ACCEPTED PRINCIPALS FOR REDUCING EROSION AND SEDIMENTATION SHALL BE IMPLEMENTED IN THE DEMOLITION OF THE EXITING BUILDING AND

- 1. THE CONTRACTOR SHALL COORDINATE A PRE-DEMOLITION MEETING PRIOR TO ANY ACTIVITY.
- 2. STABILIZATION PRACTICES FOR EROSION AND SEDIMENT CONTROL SHALL BE INSTALLED PRIOR TO COMMENCING DEMOLITION ACTIVITIES. CONSTRUCT STABILIZED CONSTRUCTION ENTRANCE AT SUMMER STREET.
- DEMO EXISTING BUILDING AND CANOPY.
- 4. REMOVE TEMPORARY EROSION CONTROL DEVICES ONCE DEMO IS COMPLETE.


CONSTRUCTION PHASE BMP OPERATION AND MAINTENANCE NOTES:


- 1. STRUCTURAL PRACTICES UTILIZED FOR THE PROJECT WILL INCLUDE EROSION CONTROL BARRIERS, AND STABILIZED CONSTRUCTION ENTRANCE.
- OPERATOR PERSONNEL MUST INSPECT THE SITE WITHIN 24 HOURS OF A STORM EVENT OF 1/2 INCH OR GREATER. THE INSPECTOR SHOULD REVIEW THE EROSION AND SEDIMENT CONTROLS WITH RESPECT TO THE FOLLOWING: A. WHETHER OR NOT THE MEASURE WAS INSTALLED/PERFORMED CORRECTLY.
 - B. WHETHER OR NOT THERE HAS BEEN DAMAGE TO THE MEASURE SINCE IT INSTALLED OR PERFORMED.

C. WHAT SHOULD BE DONE TO CORRECT ANY PROBLEMS WITH THE MEASURE.

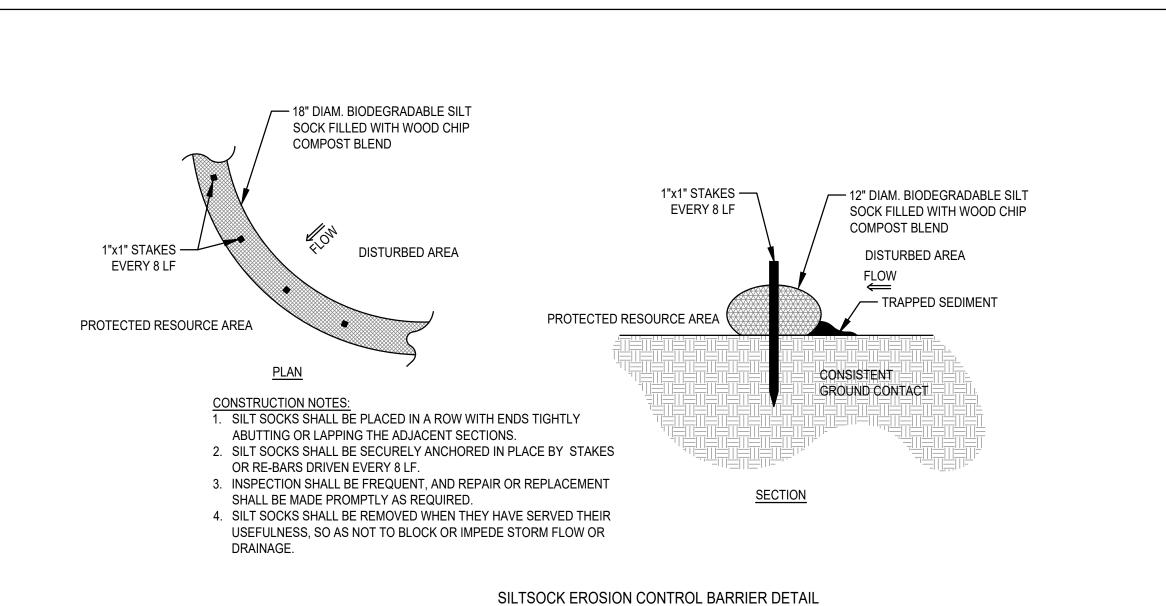

SCALE: N.T.S.

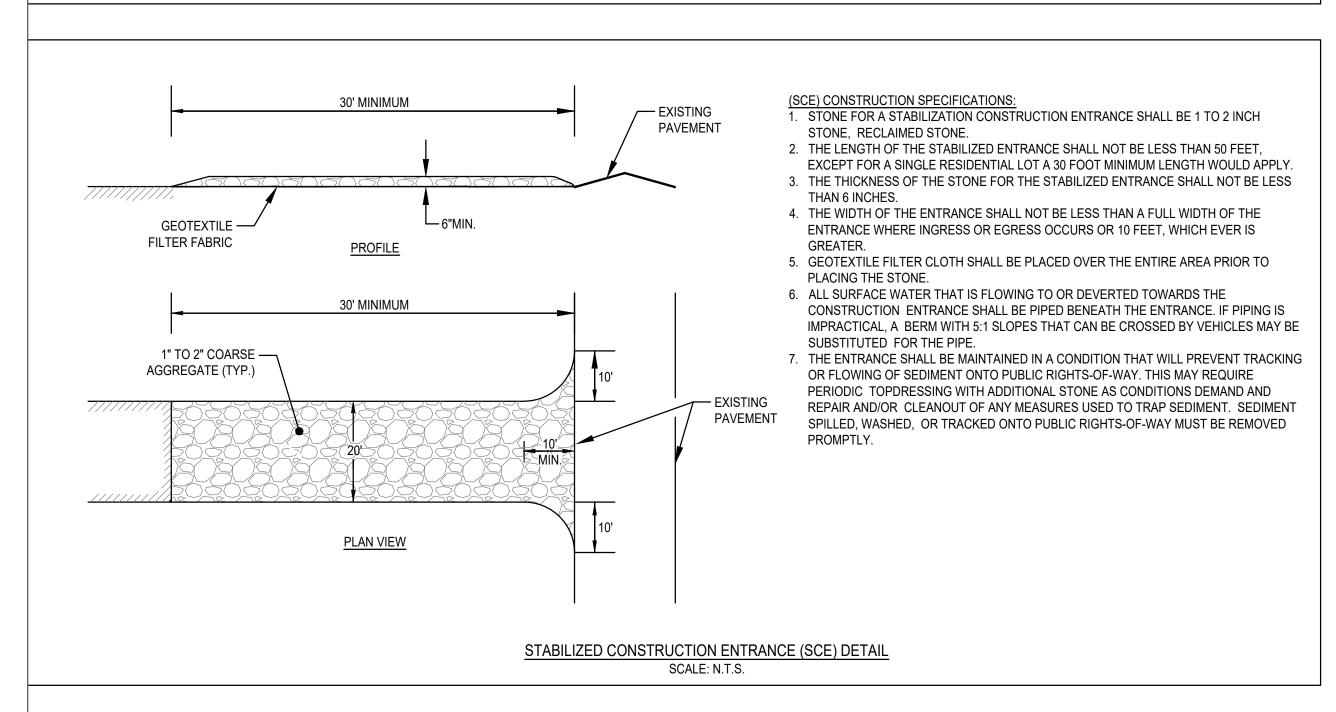

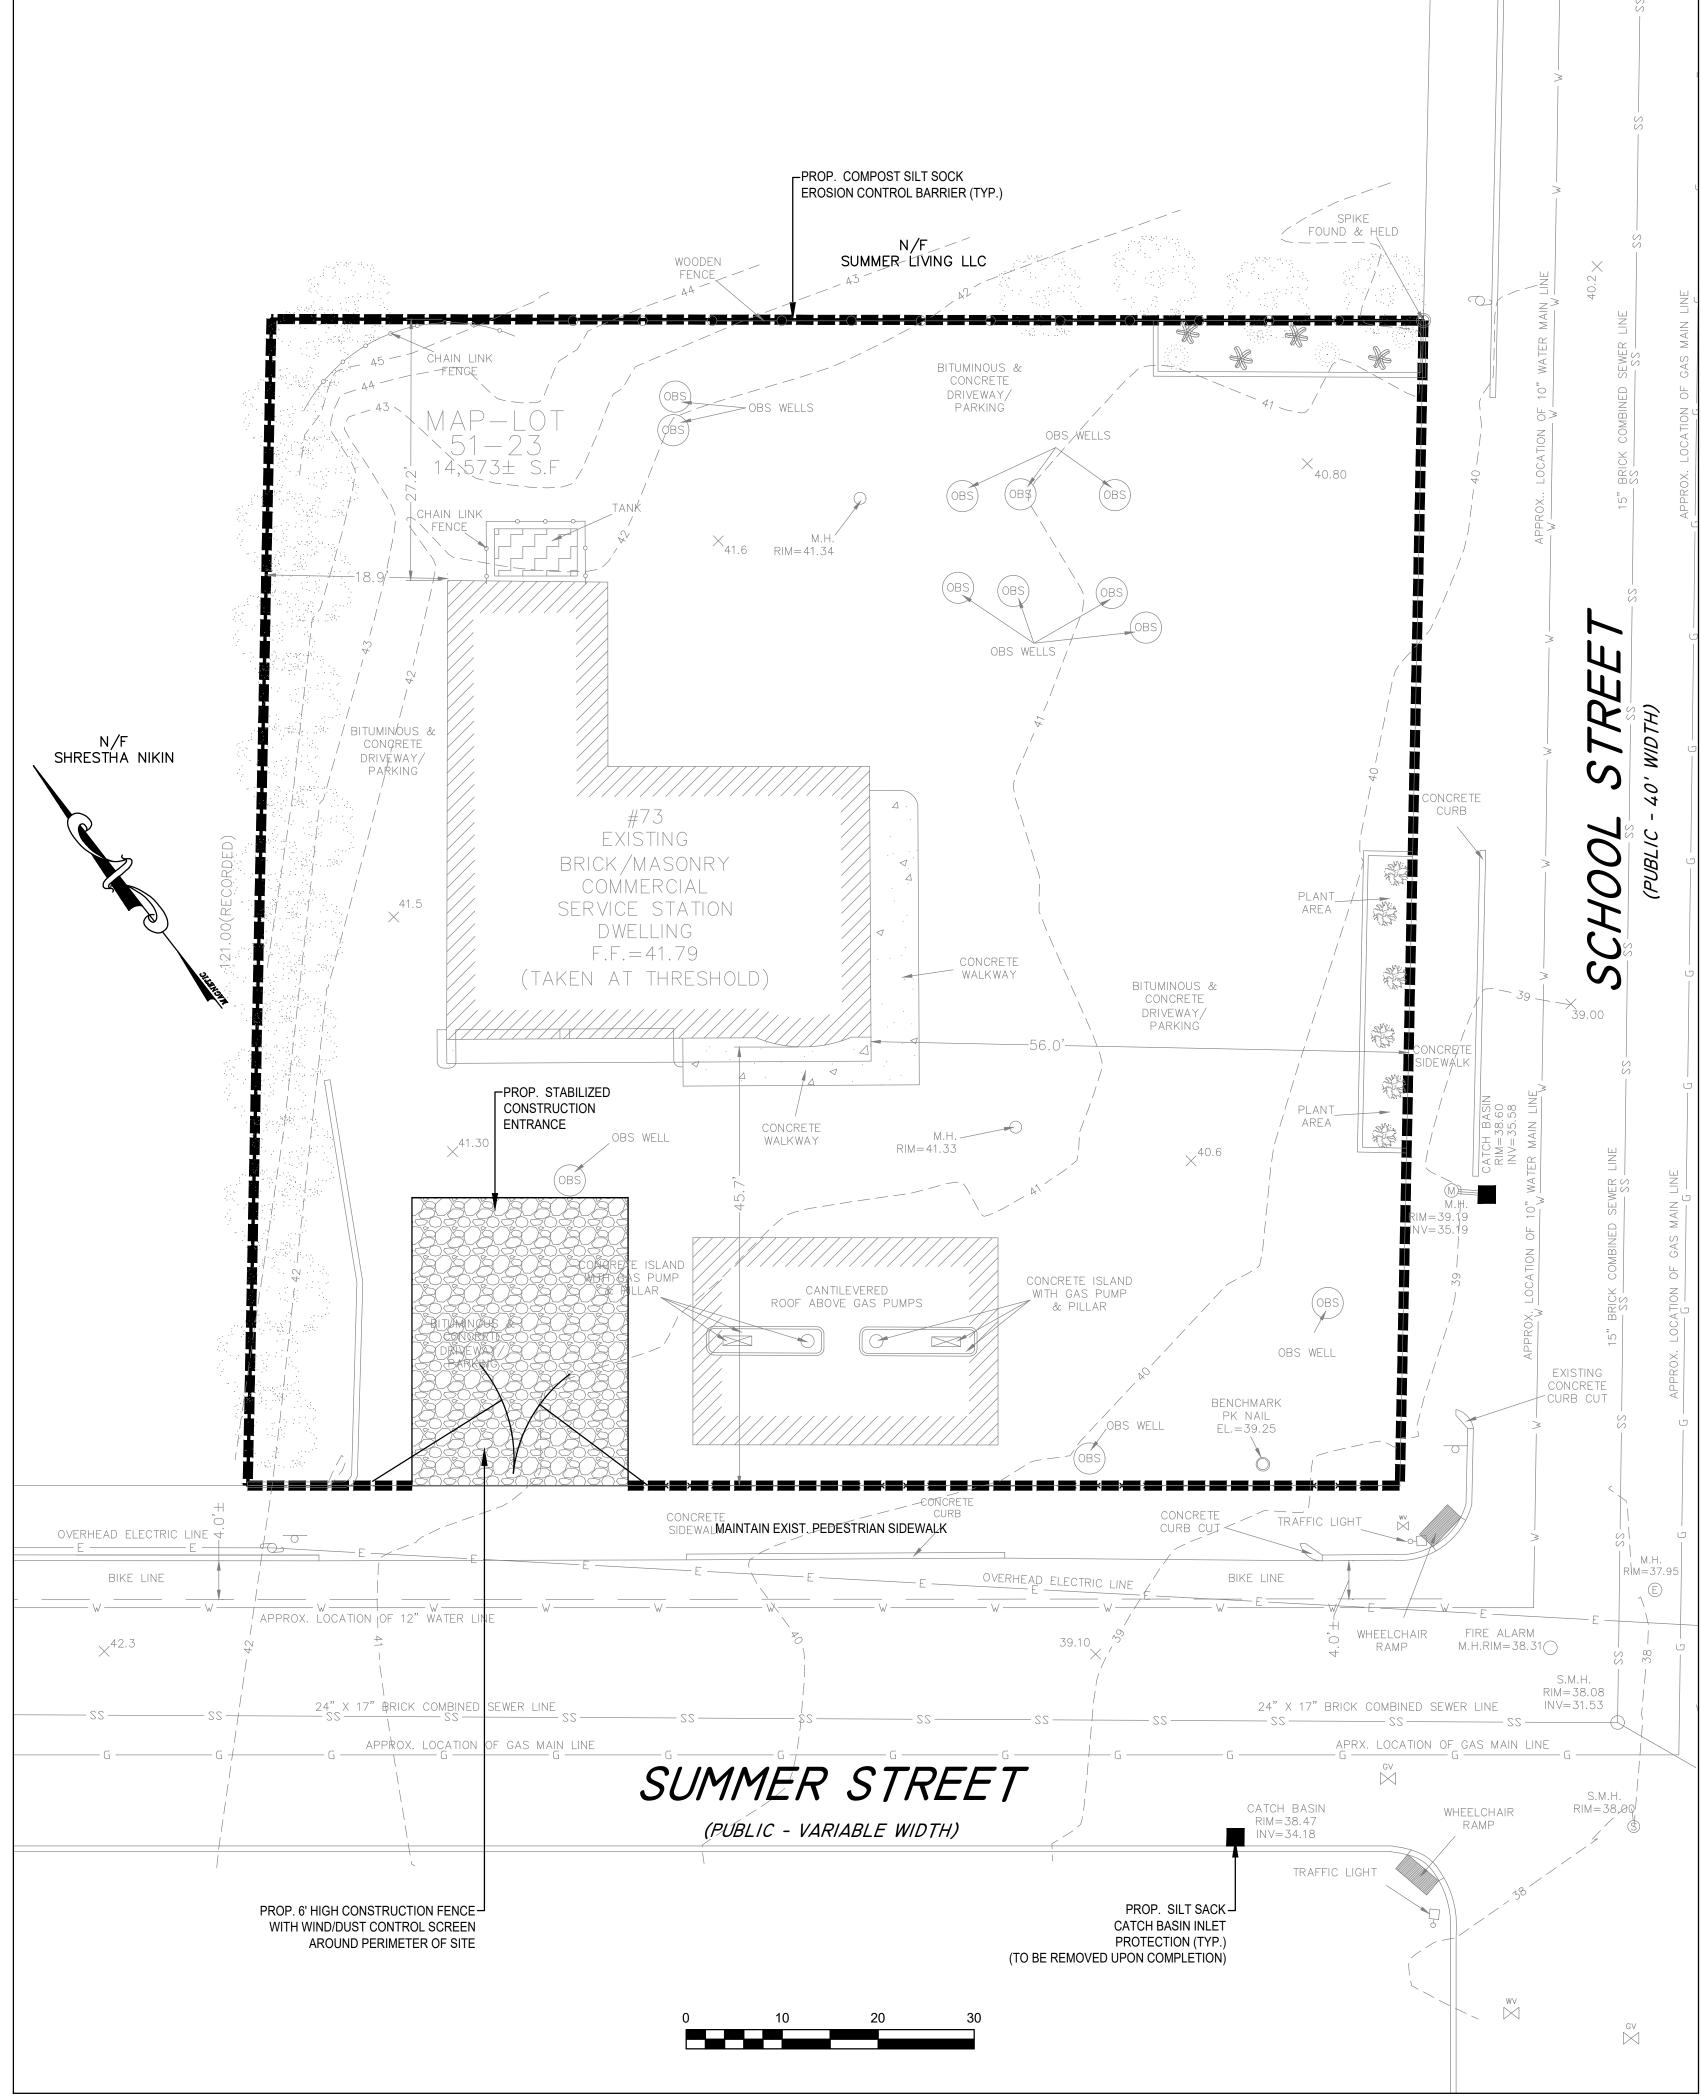

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FIRST SUMMER 73, LLC 20 WOODWARD STREET NEWTON, MA

CONSULTANTS

781.792.3900

CIVIL ENGINEERING / SURVEY MCKENZIE ENGINEERING GROUP 150 LONGWATER DRIVE, SUITE 101 NORWELL, MA 02061

LANDSCAPE ARCHITECT VERDANT

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617.735.1180

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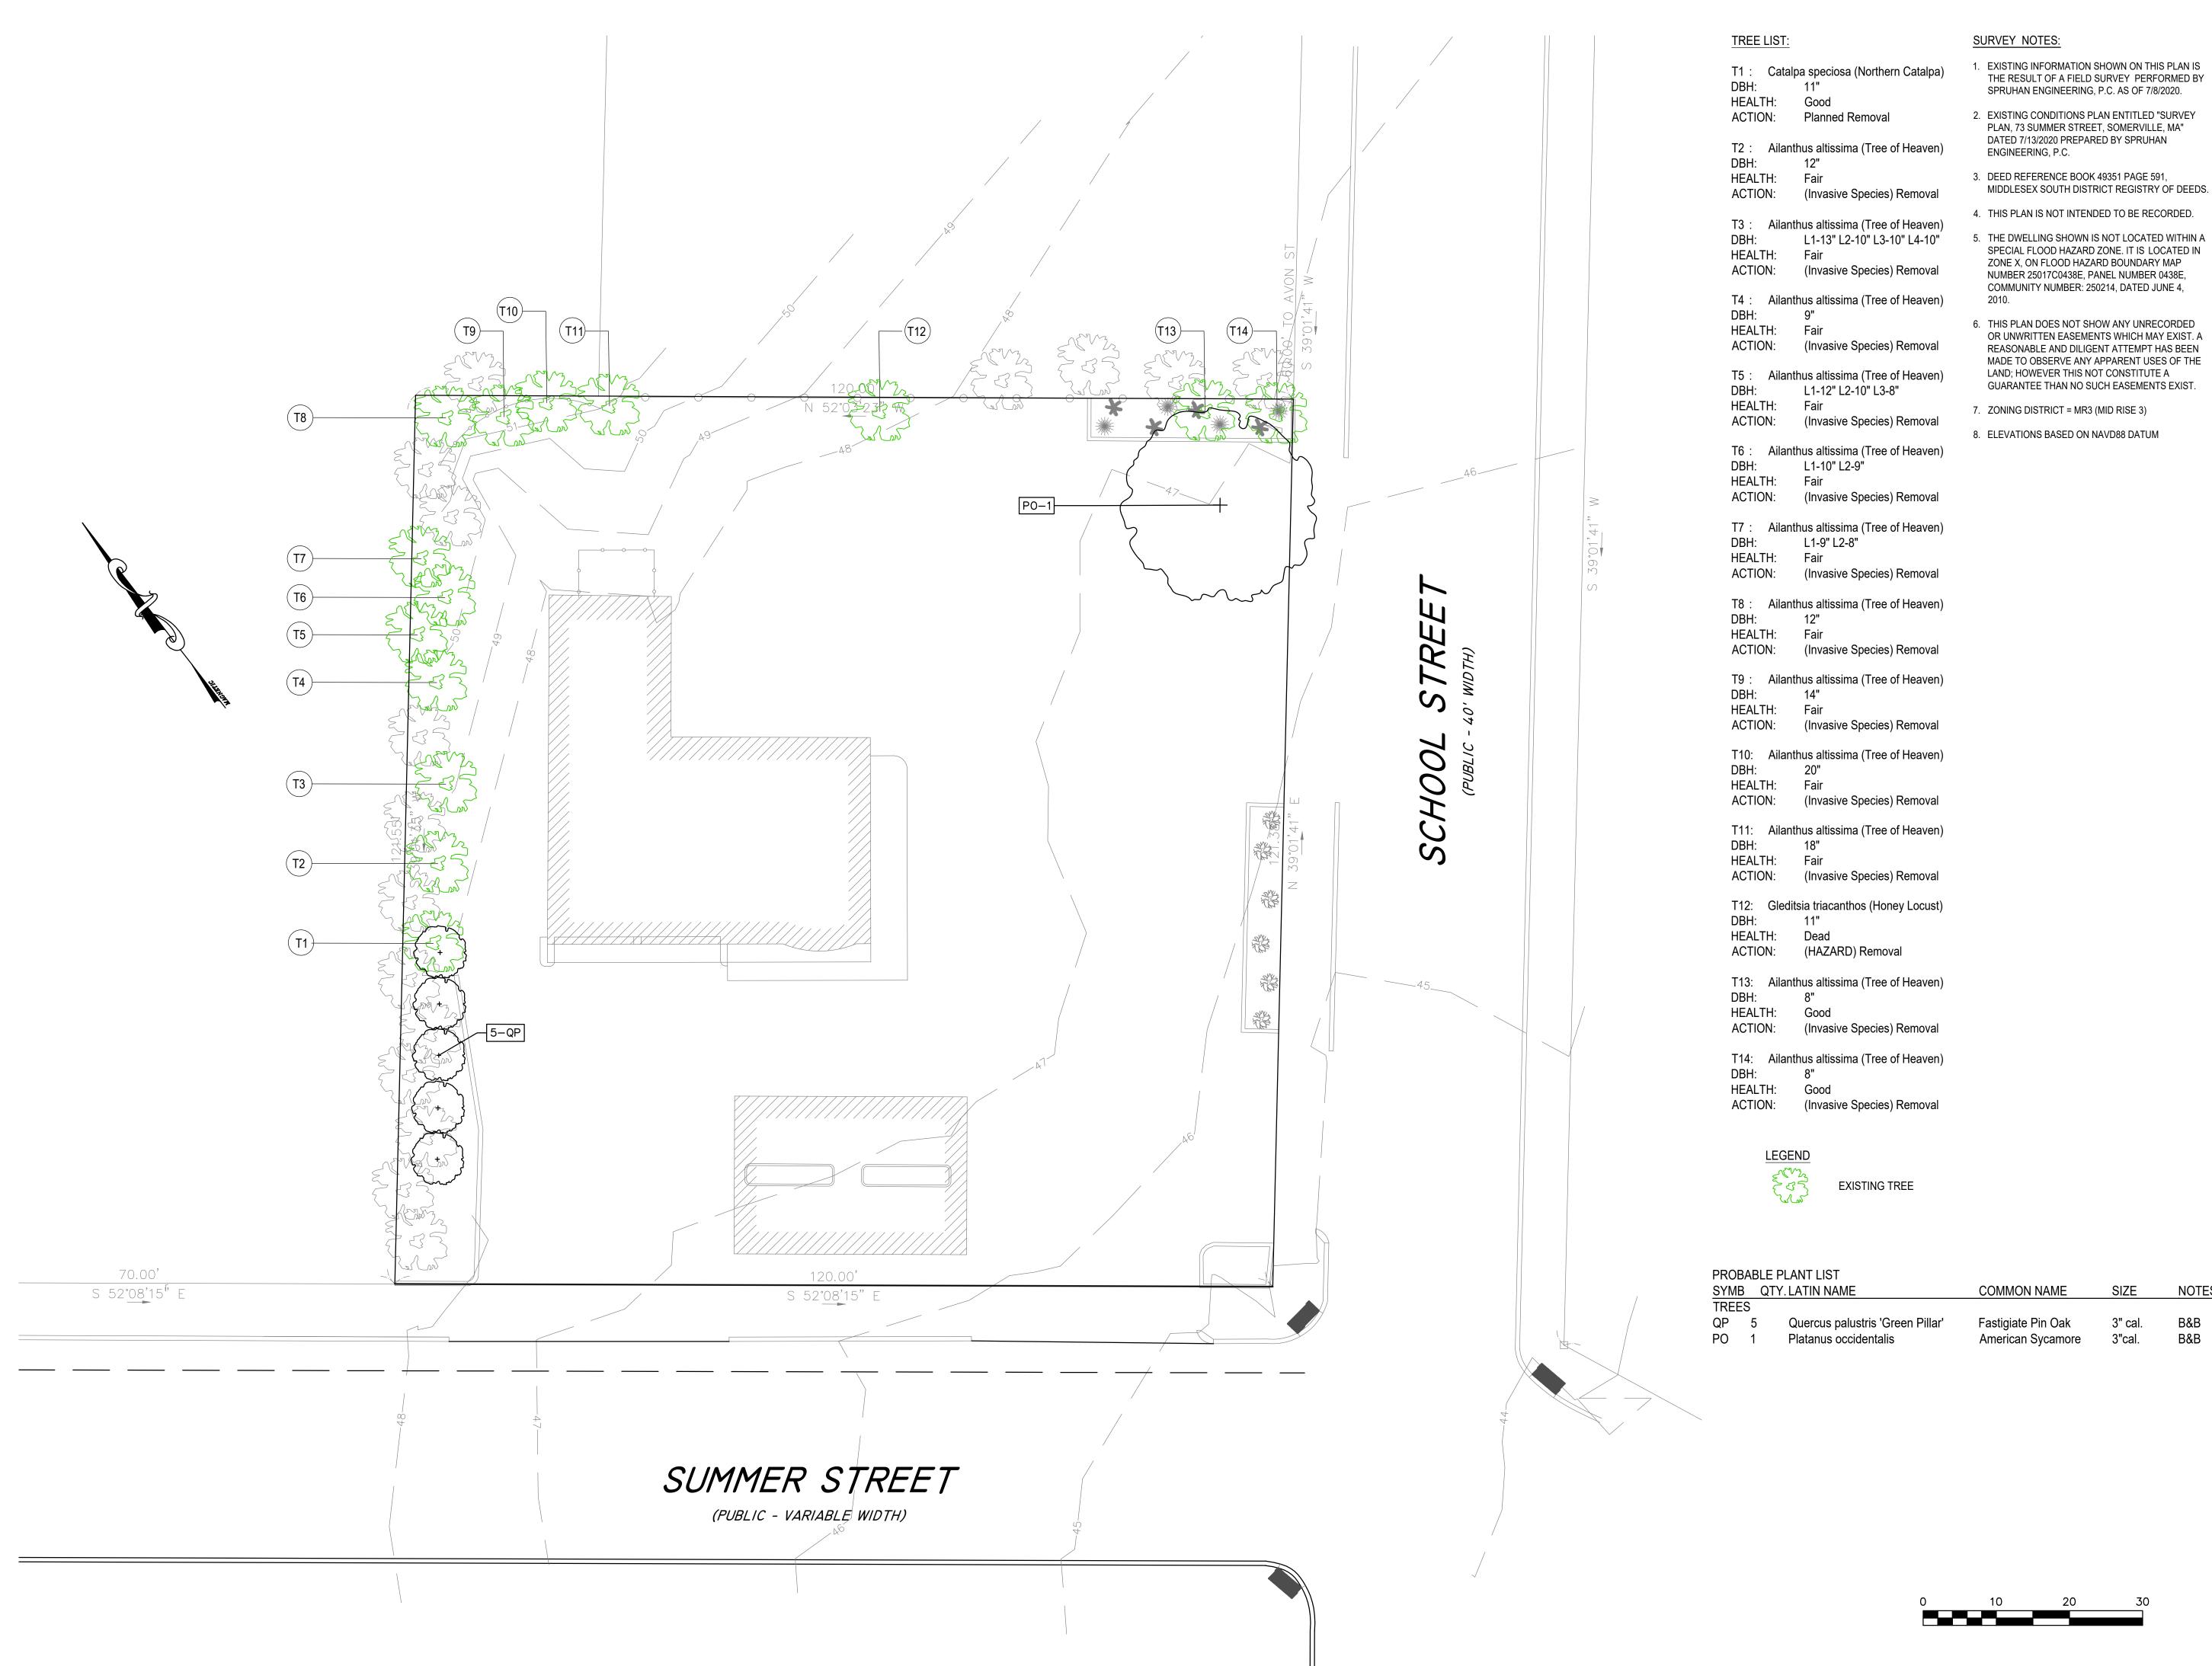
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PROJECT #:

DRAWING TITLE EROSION & SEDIMENTATION

CONTROL PLAN DRAWING NUMBER



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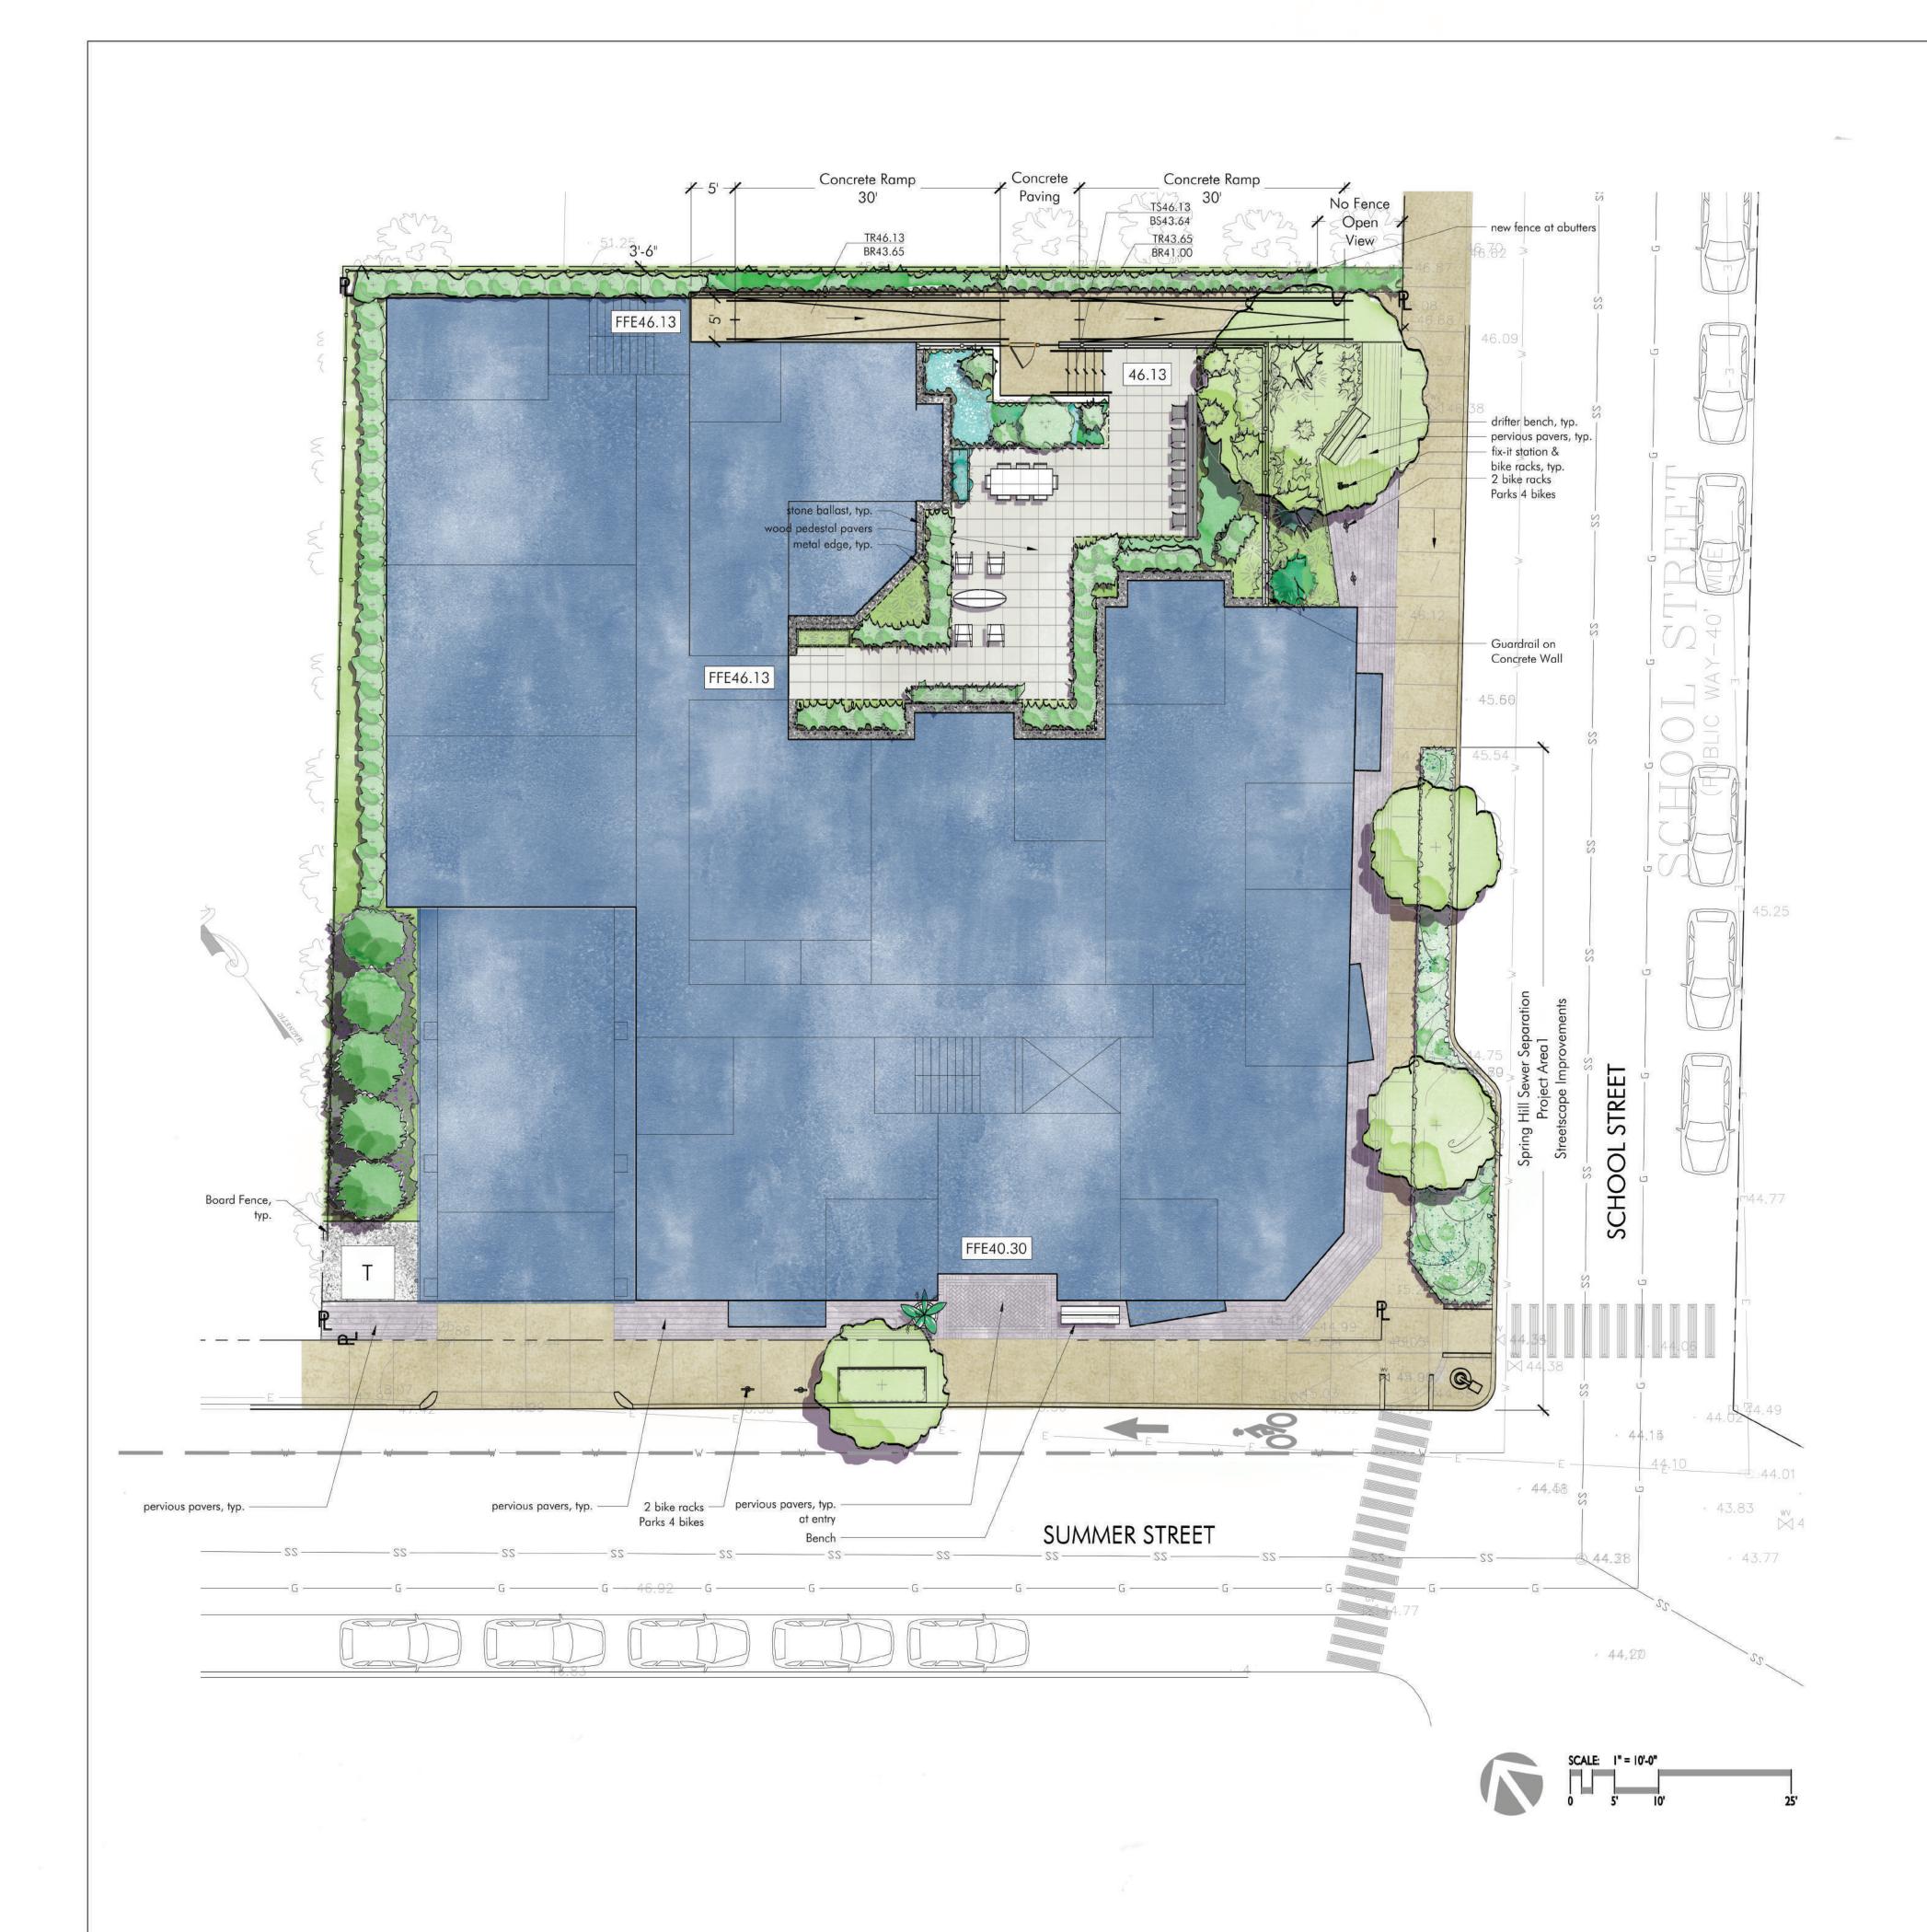
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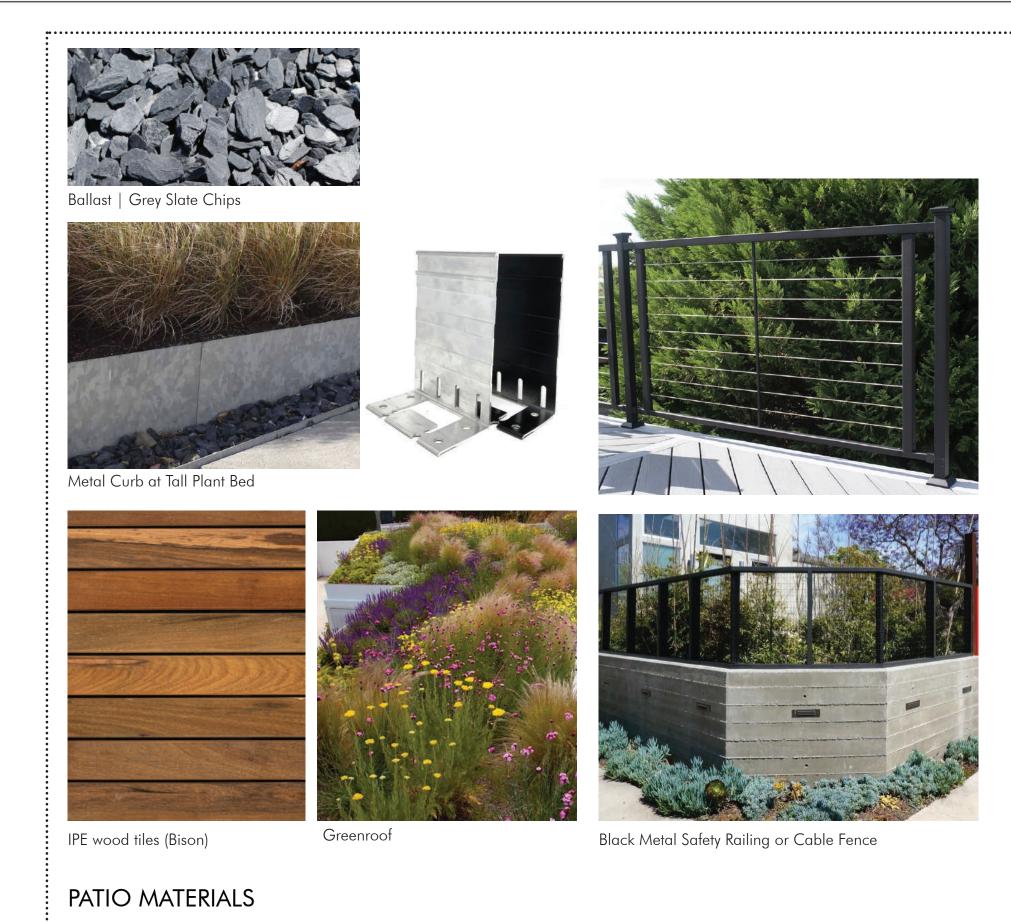
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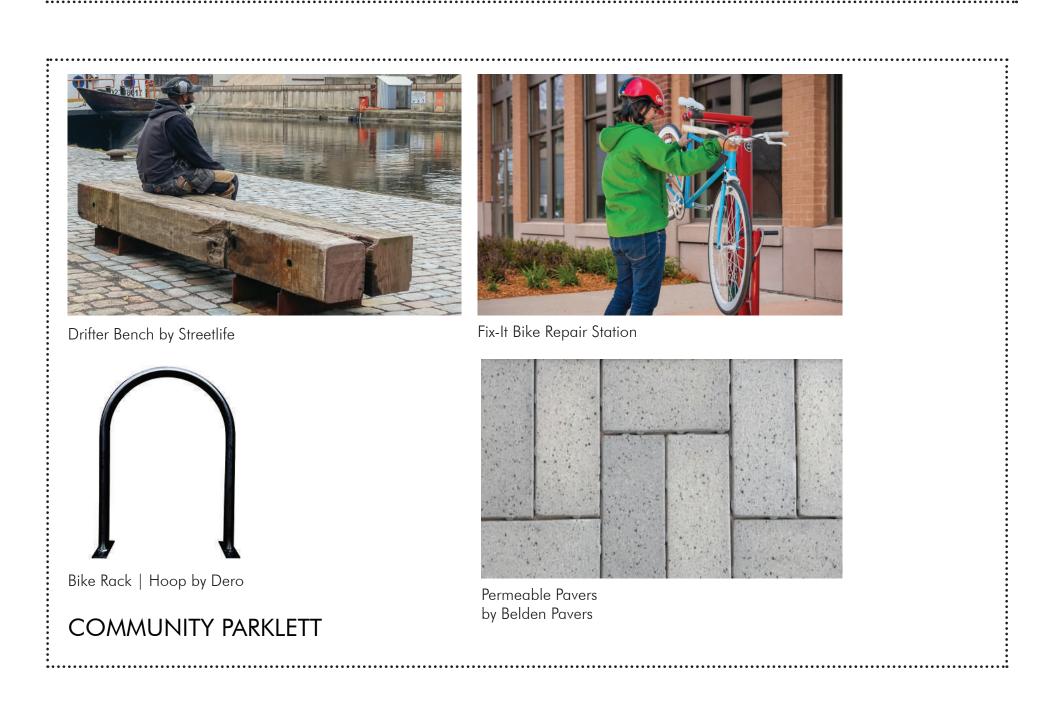
DRAWING TITLE

TREE MITIGATION PLAN











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SUBMISSION REVIEW

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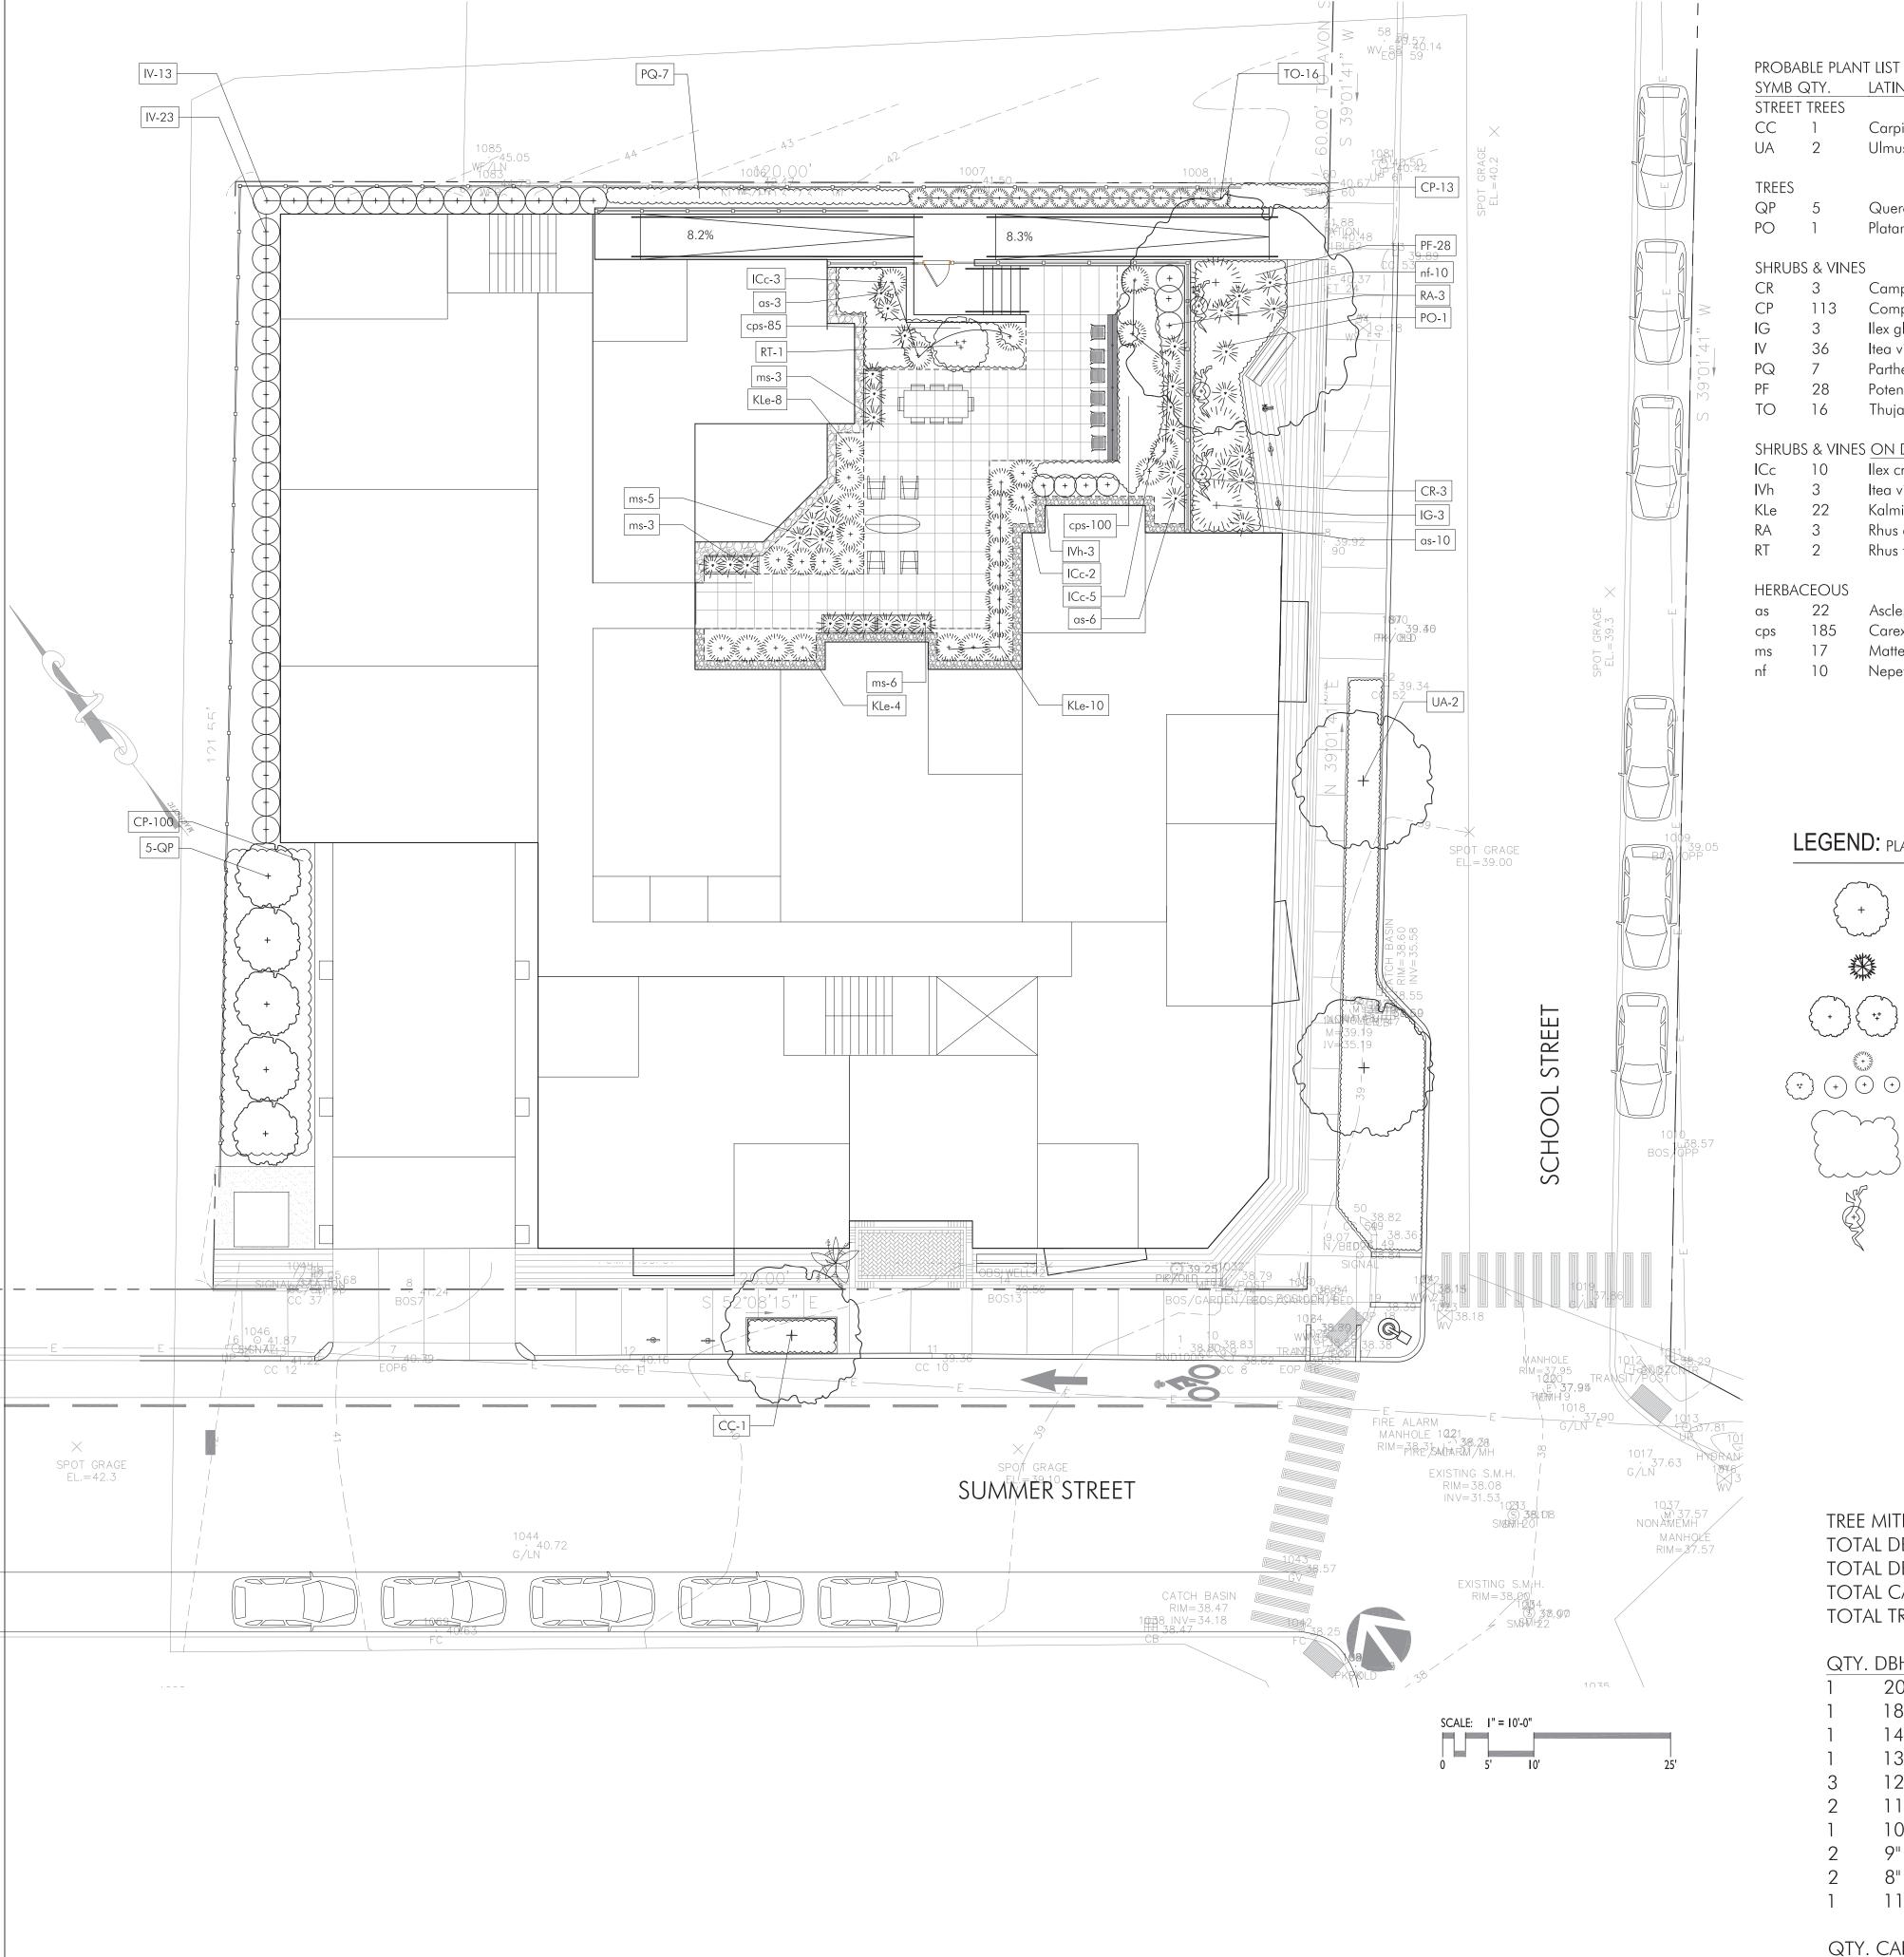
DEVELOPMENT REVIEW SUBMISSIO

PROJECT #: 20027

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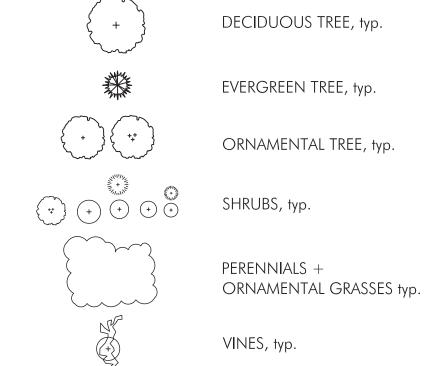
LANDSCAPE SITE PLAN





	ADLE PLA					
	QTY.	LATIN NAME	COMMON NAME	SIZE	NOTES	SPACINO
STREE	ET TREES					
CC	1	Carpinus caroliniana	American hornbeam	3"cal.	B&B Overhead wires	
UA	2	Ulmus americana	American Elm cultivar	3"cal.	B&B No overhead wires	
TREES	S					
QP	5	Quercus palustris 'Green Pillar'	Fastigiate Pin Oak	3" cal.	B&B	
PO	1	Platanus occidentalis	American Sycamore	3"cal.	B&B	
SHRU	IBS & VIN	ES				
CR	3	Campsis radicans (Vine)	Trumpetcreeper Vine	2 gal.	Pots., native $\geq 2^{\circ}$ ht.	
CP	113	Comptonia peregrina	Sweetfern	2 gal.	Pots, native $>2'$ ht.	18" o.c.
IG	3	Ilex glabra 'Compacta'	Compact Japanese Holly	5 gal.	Pots, native $\geq 2'$ ht.	
IV	36	Itea virginica	Virginia Sweetspire	5 gal.	Pots, native $\geq 2'$ ht.	
PQ	7	Parthenocissus quinquefolia (Vine)	Woodbine	1 gal.	Pots, native,24"ht.	24"o.c.
PF	28	Potentilla fruticosa White	White Potentilla	5 gal.	Pots, native>2'ht.	36"o.c.
TO	16	Thuja occidentalis yellow ribbon	Yellow Ribbon Arborvitae	3 gal.	Pots, native>2'ht.	
SHRU	IBS & VIN	ES ON DECK				
IСс	10	llex crenata 'compacta' (On Deck)	Compact Japanese Holly	3 gal.	Pots, $\geq 2'$ ht.	
IVh	3	Itea virginica 'Little Henry' (On Deck)	Little Henry Sweetspire	5 gal.	Pots, native $\geq 2'$ ht.	
KLe	22	Kalmia latifolia 'Elf' (On Deck)	Elf Mountain Laurel	2 gal.	Pots, native $>2'$ ht.	
RA	3	Rhus aromatica 'Lo Gro' (On Deck)	Lo-Gro Staghorn Sumac	3 gal.	Pots, native $\geq 2'$ ht.	
RT	2	Rhus typhina 'Tiger Eyes' (2 on Deck)	Staghorn Sumac	5 gal.	Pots, native >2 'ht.	
HERB/	ACEOUS					
as	22	Asclepias syriaca	Common Milkweed	1 gal.	Pots, 24" o.c., native \geq	2' ht.
cps	185	Carex pensylvanica	Pennsylvania sedge	1 gal.	Pots, native $<2'$ ht. 12"o	.C.
ms	17	Matteuccia struthiopteris	Ostrich Fern	2 gal.	Pots, 24" o.c., native ≥ 2	2' ht.
nf	10	Nepeta faassenii 'Walker's Low'	Catmint	1 gal.	Pots, 24" o.c., \leq 2' ht.	

LEGEND: PLANTING PLAN



TREE MITIGATION	
TOTAL DBH REMOVED:	221"
TOTAL DBH TO MITIGATE:	11"
TOTAL CAL ADDED:	18"
TOTAL TREES PLANTED:	6

QTY	. DBH	SPECIES TYPE
1	20"	Invasive
1	18"	Invasive
1	14"	Invasive
1	13"	Invasive
3	12"	Invasive
2	11"	Invasive
1	10"	Invasive
2	9"	Invasive
2	8"	Invasive
1	11"	Native

QTY. CAL SPECIES TYPE 6 3" Native

PLANTING NOTES

- 1. All plant material shall be approved by the Landscape Architect prior to arrival on the site.
- 2. All plant material shall conform to the guidelines established by "The American Standard for Nursery Stock", published by the American Hort.
- 3. No substitution of plant species will be allowed without the written approval of the Landscape Architect. Any proposed substitutions of plant species shall be a plant of equivalent overall form, height and branching habit, flower, leaf and fruit, color and time of bloom.
- 4. The Contractor shall locate and verify all utility line locations prior to excavation for tree pits and report any conflicts to the Landscape Architect.
- 5. All plants shall be placed in their approximate location by the Contractor. The Contractor shall adjust the locations as required by the Landscape Architect. Trees shall be placed first, then shrubs, then perennials and last, groundcovers. Final locations must be approved by the Landscape Architect prior to
- 6. The rootballs of trees shall be planted 3" above adjacent finished grade. The rootballs of shrubs shall be planted 2" above adjacent finished grade. The rootflare of perennials shall be set at the level at which the plant was growing.
- 7. All planting to be done under the full time supervision of a certified arborist, nurseryman or licensed Landscape Architect.
- 8. All plants are to be thoroughly watered after installation, at least twice within the first 24 hours.
- 9. The Landscape Subcontractor shall coordinate with the General Contractor and Site Subcontractor all the requirements for subsoil testing and preparation and testing and placing of approved topsoil and planting soil mixes as described in the specifications. Failure of the site or General Contractor to perform required testing, subsoil and topsoil preparation does not relieve the Landscape Contractor from the requirements of the work as set forth in the specifications.
- 10. All plant bed areas are to be covered with mulch when transplanting is completed

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DRAWING INFORMATION

ISSUE: <u>DEVELOPMENT REVIEW SUBMISSION</u> JUNE 01, 2021

PROJECT #: 20027 SCALE: As indicated

DRAWING TITLE

LANDSCAPE PLANTING PLAN

DRAWING NUMBER

Table 10.4.1 Green Score Calculation

Table 10.4.1 Green Score Cal	culation	
	Credit	Multiplier
Soils		
Landscaped area with a soil depth < 24 inches	actual sf	0.3
Landscaped area with a soil depth => 24 inches	actual sf	0.6
Pervious Paving with 6 to 24 inches of subsurface soil or gravel	actual sf	0.2
Pervious Paving with more than 24 inches of subsurface soil or gravel	actual sf	0.5
Groundcovers		
Turfgrass, mulch, and inorganic surfacing materials	actual sf	0.1
Plants		
Vegetation less than two (2) feet tall at maturity	actual sf	0.2
Vegetation at least two (2) feet tall at maturity	12 sf.	0.3
Trees		
Small Tree	50 sf.	0.6
Large Tree	450 sf.	0.6
PreservedTree	65 sf.	0.8
Engineered Landscape		
Vegetated Wall	actual sf	0.1
Rain gardens, bioswales, and stormwater PLANTERs.	actual sf	1.0
Green Roof with up to 6" of growth medium	actual sf	0.1
Green Roof with 6"-10" of growth medium	actual sf	0.4
Green Roof of 10"-24" growth medium	actual sf	0.6
Green Roof of over 24" growth medium		per individual landscape elements

Green Score is a performance-based environmental landscape standard measured as a ratio of the weighted value of all landscape elements to the total land area of a lot.

73 Summer Street 14,573.3 SF Total

Key		Multiplier	Bonus	Credit	
Α	Soils Landscaped Area with a soil	.6		1435.0 sf	861.0
	depth => 24 inches				
В	Soils Pervious Paving with more than	.5		2329 sf	1164.5
	24 inches of subsurface soil or gravel				
C	Plants Vegetation at least two feet tall	.3	NS .1	(206)12 sf	988.8
	at maturity				
D	Tree Small	.6	NS .1	(5) 50 sf	175.0
Е	Trees Large Tree	.6	PV .1	(1) 450 sf	315.0
F	Engineered Landscape Green Roof	.6	NS .1	610 sf	427.0
	with 10-24" of growth medium				
	Total				3,931.3
	Green Score Bonus				
	Native Species $= NS = .1$				
	Publicly Visible Landscape $= PV = .1$				


3,931.30/14,573.30 = .27 Green Score .25 minimum

Table 10.4.2 Green Score Bonuses

	Credit	Multiplier
Bonus Credits		
Publicly visible landscape		0.1
Native species		0.1
High value species		0.1
50% of irrigation is harvested rainwater		0.1
Food cultivation		0.1
De-paved LOT AREA		0.1

5. Calculation

- a. Green Score is calculated as follows:
 - i. Determine total LOT AREA.
 - ii. Calculate the area of each proposed landscape element for each category identified in the first column of Table 10.4.1. Certain types of plantings USE the number of individual plants multiplied by an equivalent square footage when indicated in the second column of Table 10.4.1.
- iii. Multiply the actual square footage, or the equivalent square footage, of each landscape element by the multiplier specified for each landscape element in the third column of Table 10.4.1 plus any bonus on Table 10.4.2 to determine the weighted score of each element.
- iv. Add the weighted score of all landscape elements together.
- v. Divide the resulting sum by the area of the LOT to determine the final GREEN SCORE.
- vi. If necessary, redesign the landscape plan to achieve the required GREEN Score.
- b. Bonuses
 - i. Review Boards may establish additional bonuses

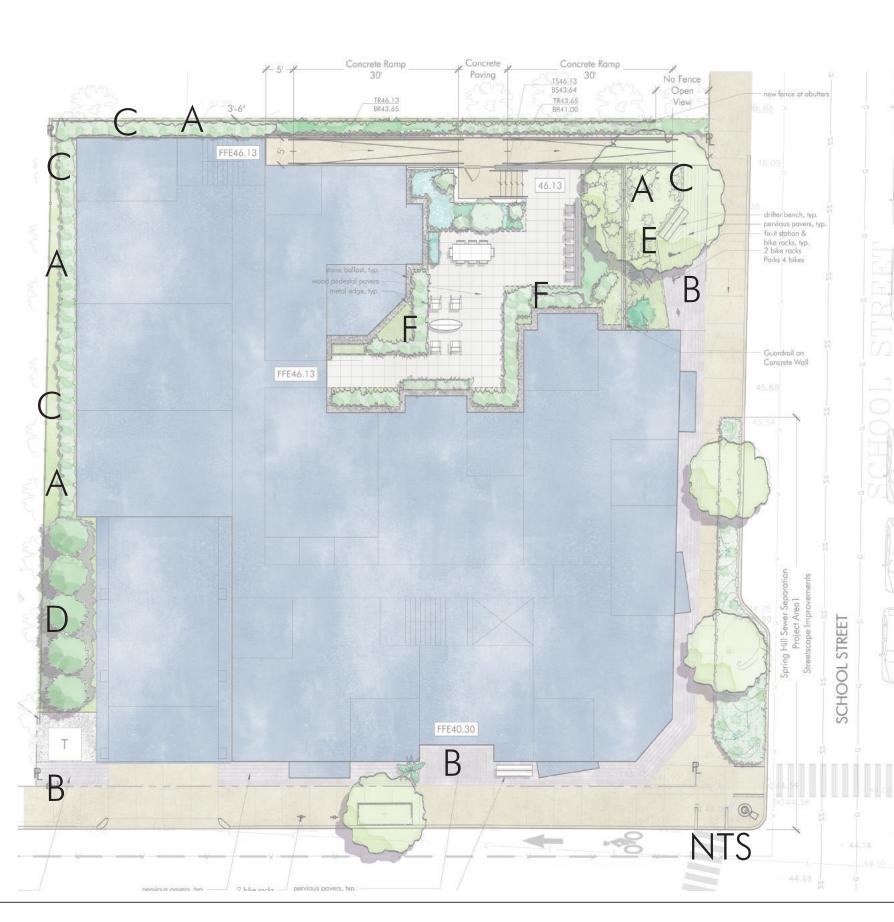

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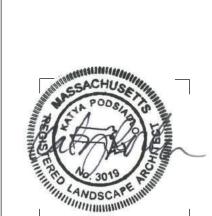
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JUNE 01, 2021 PROJECT #: 20027 SCALE: As indicated

DRAWING TITLE GREEN SCORE



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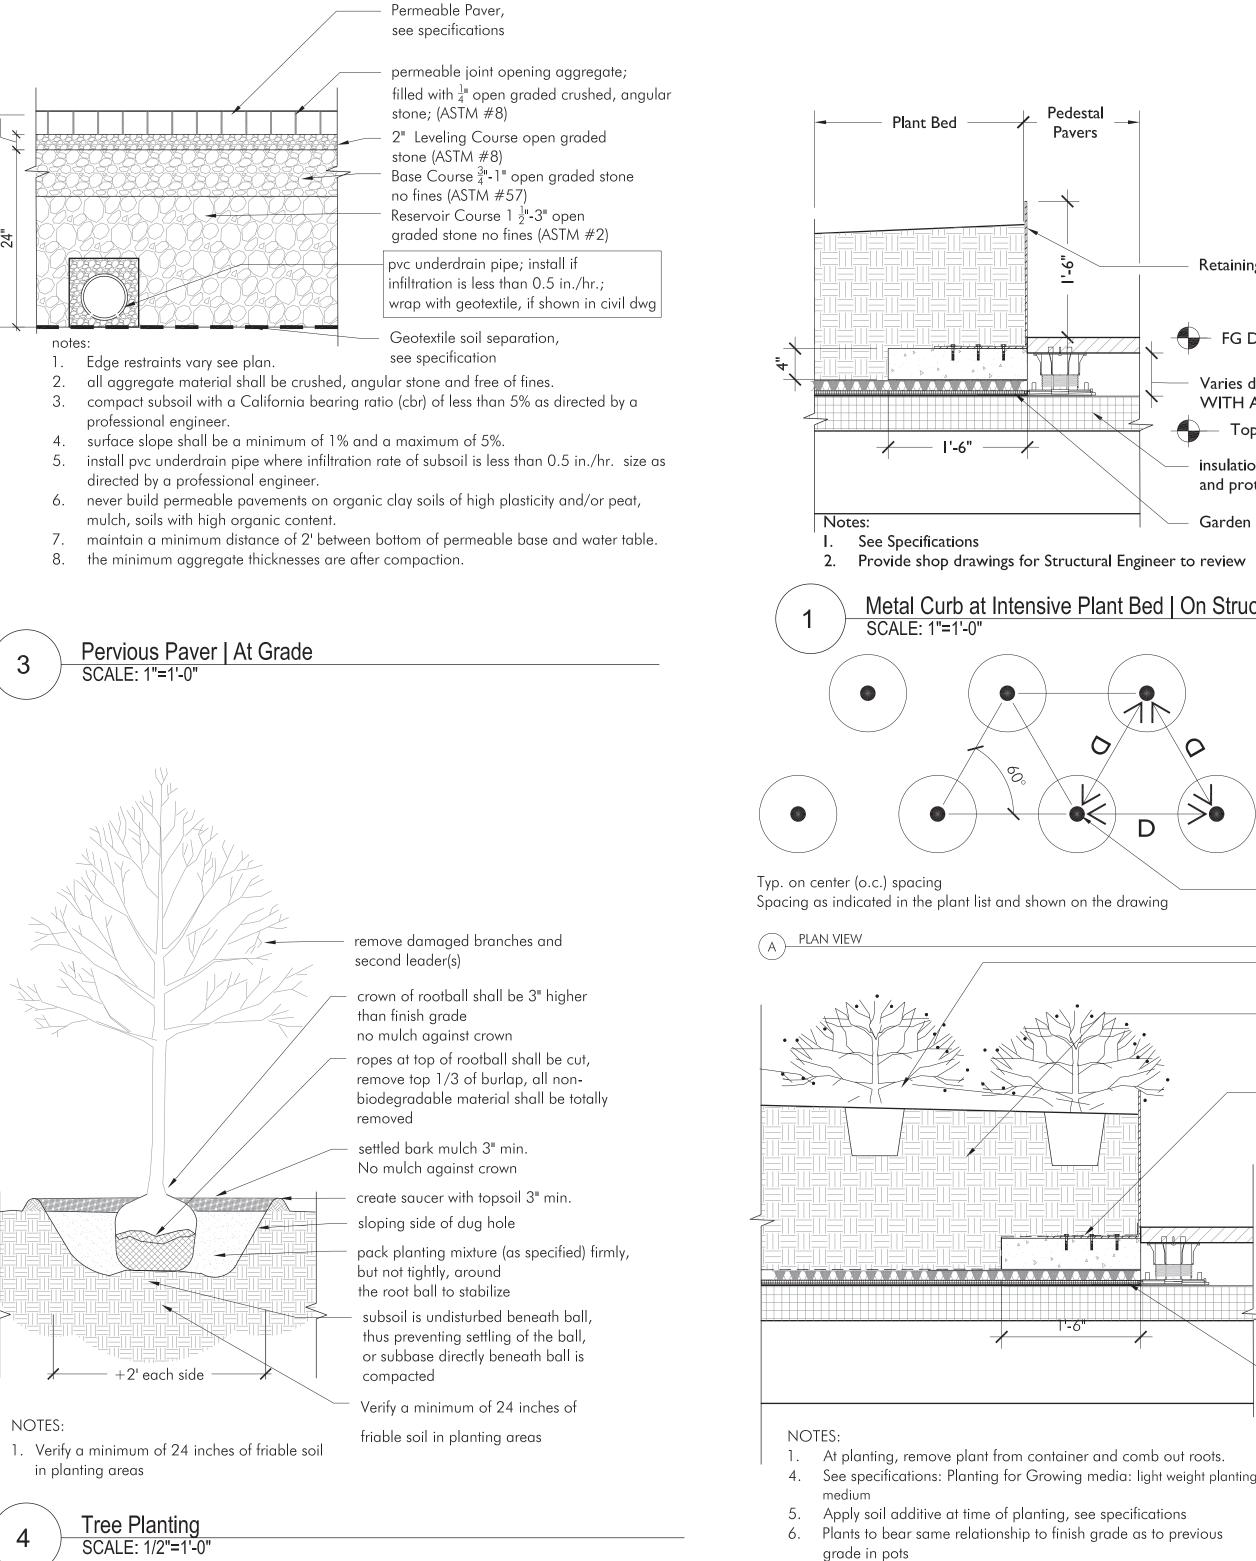
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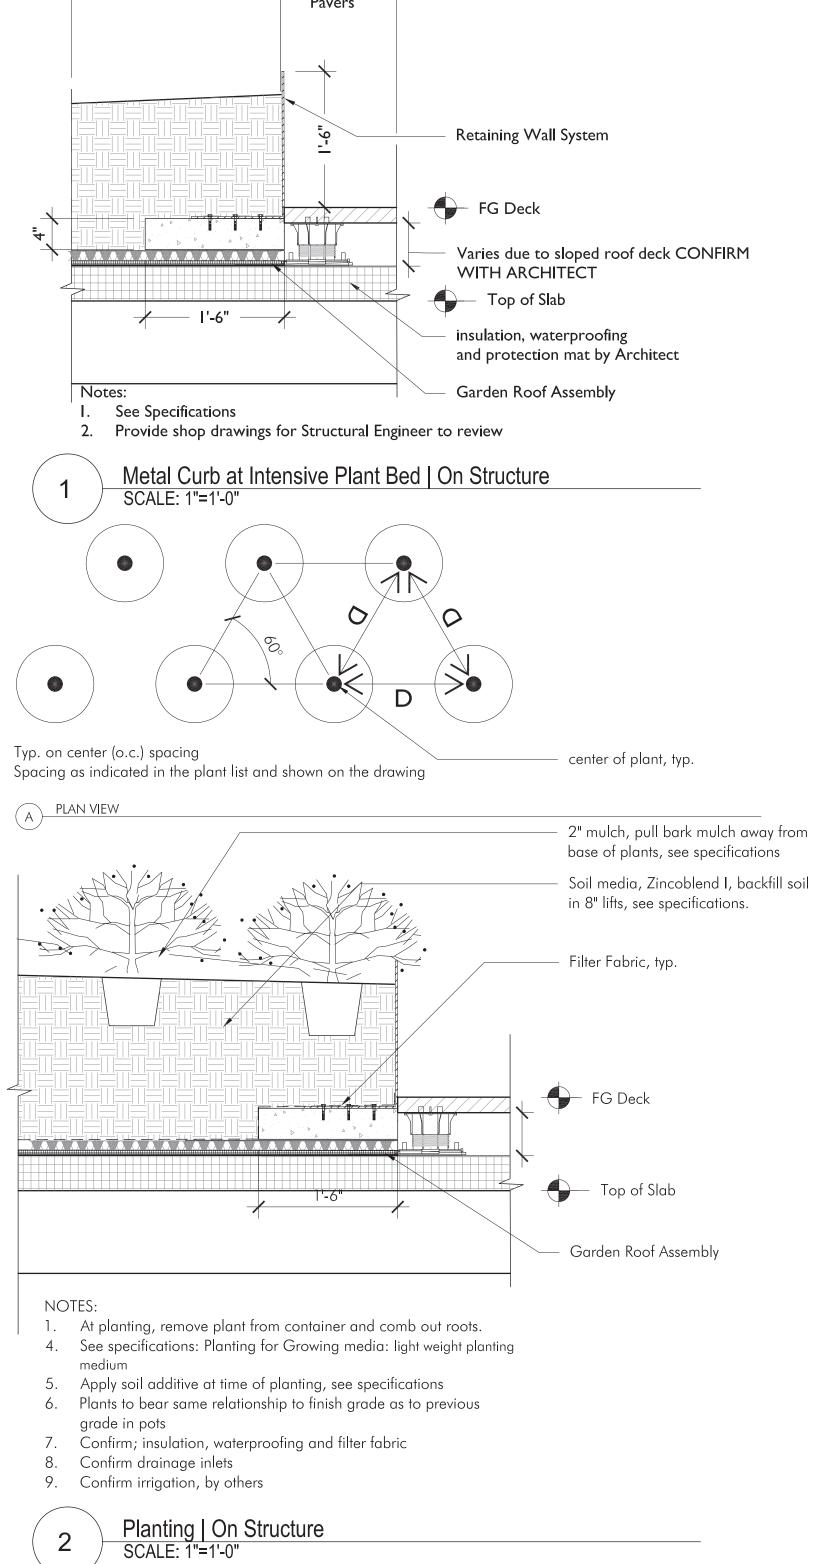
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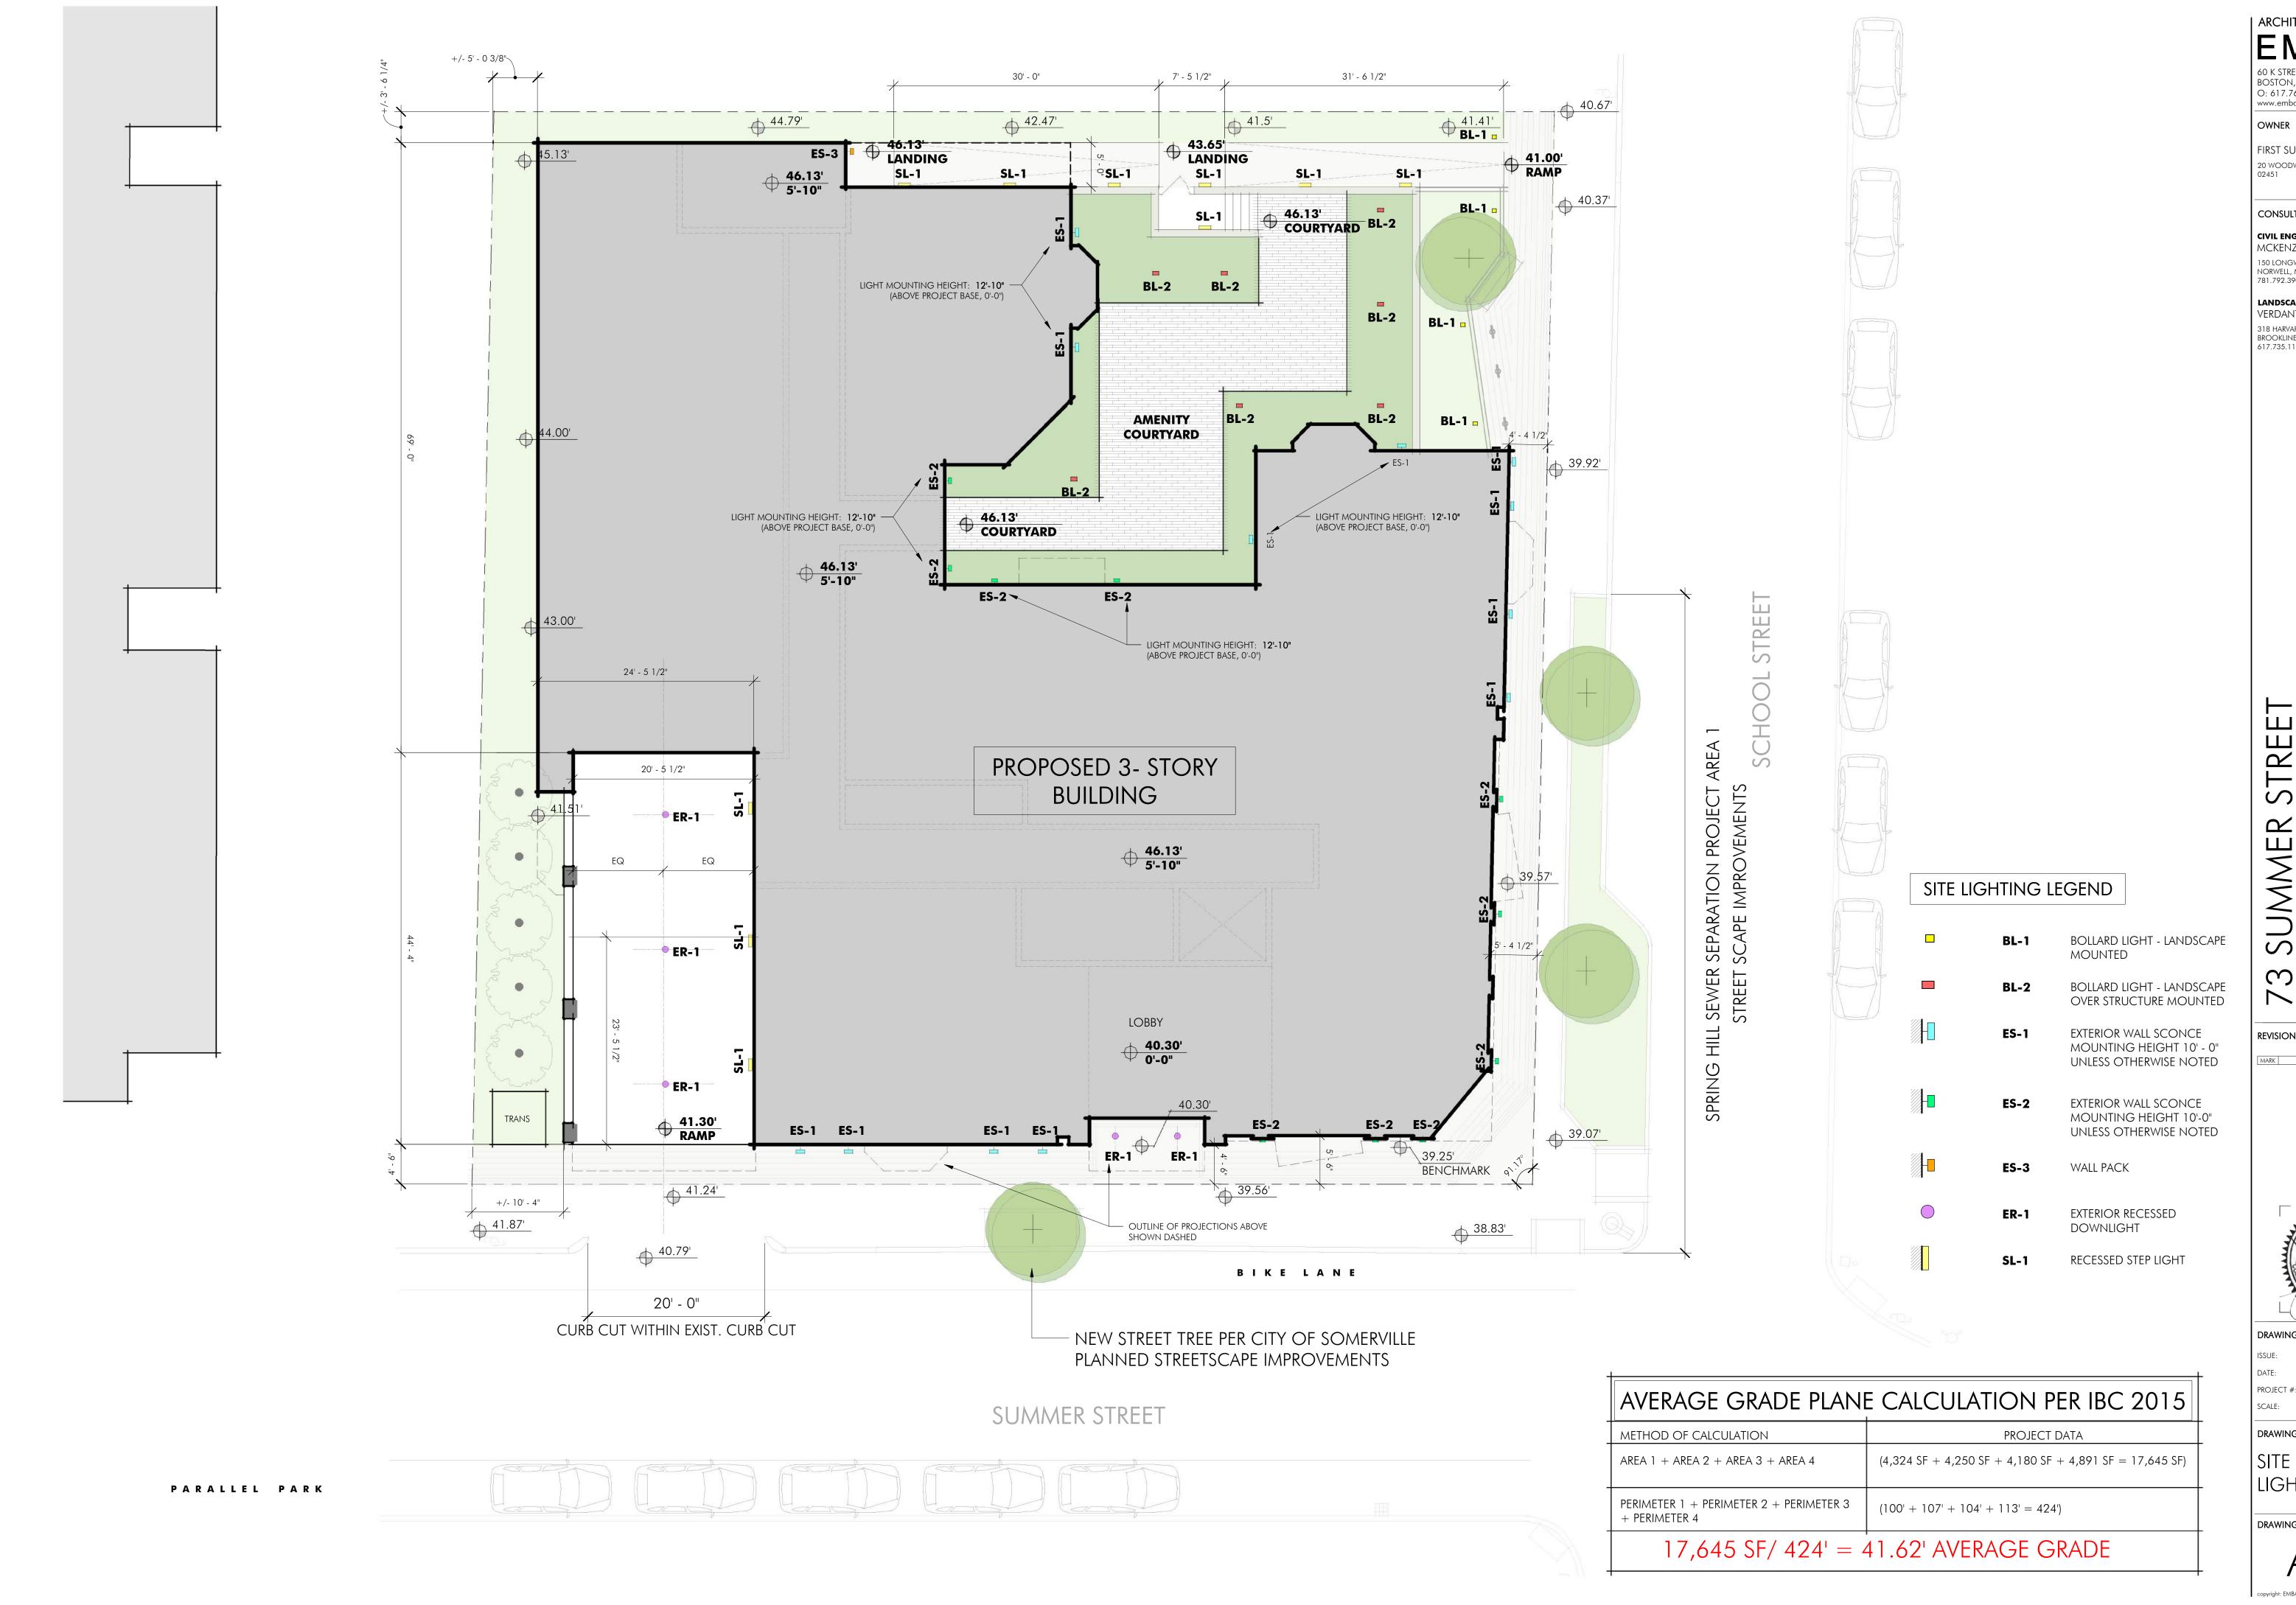
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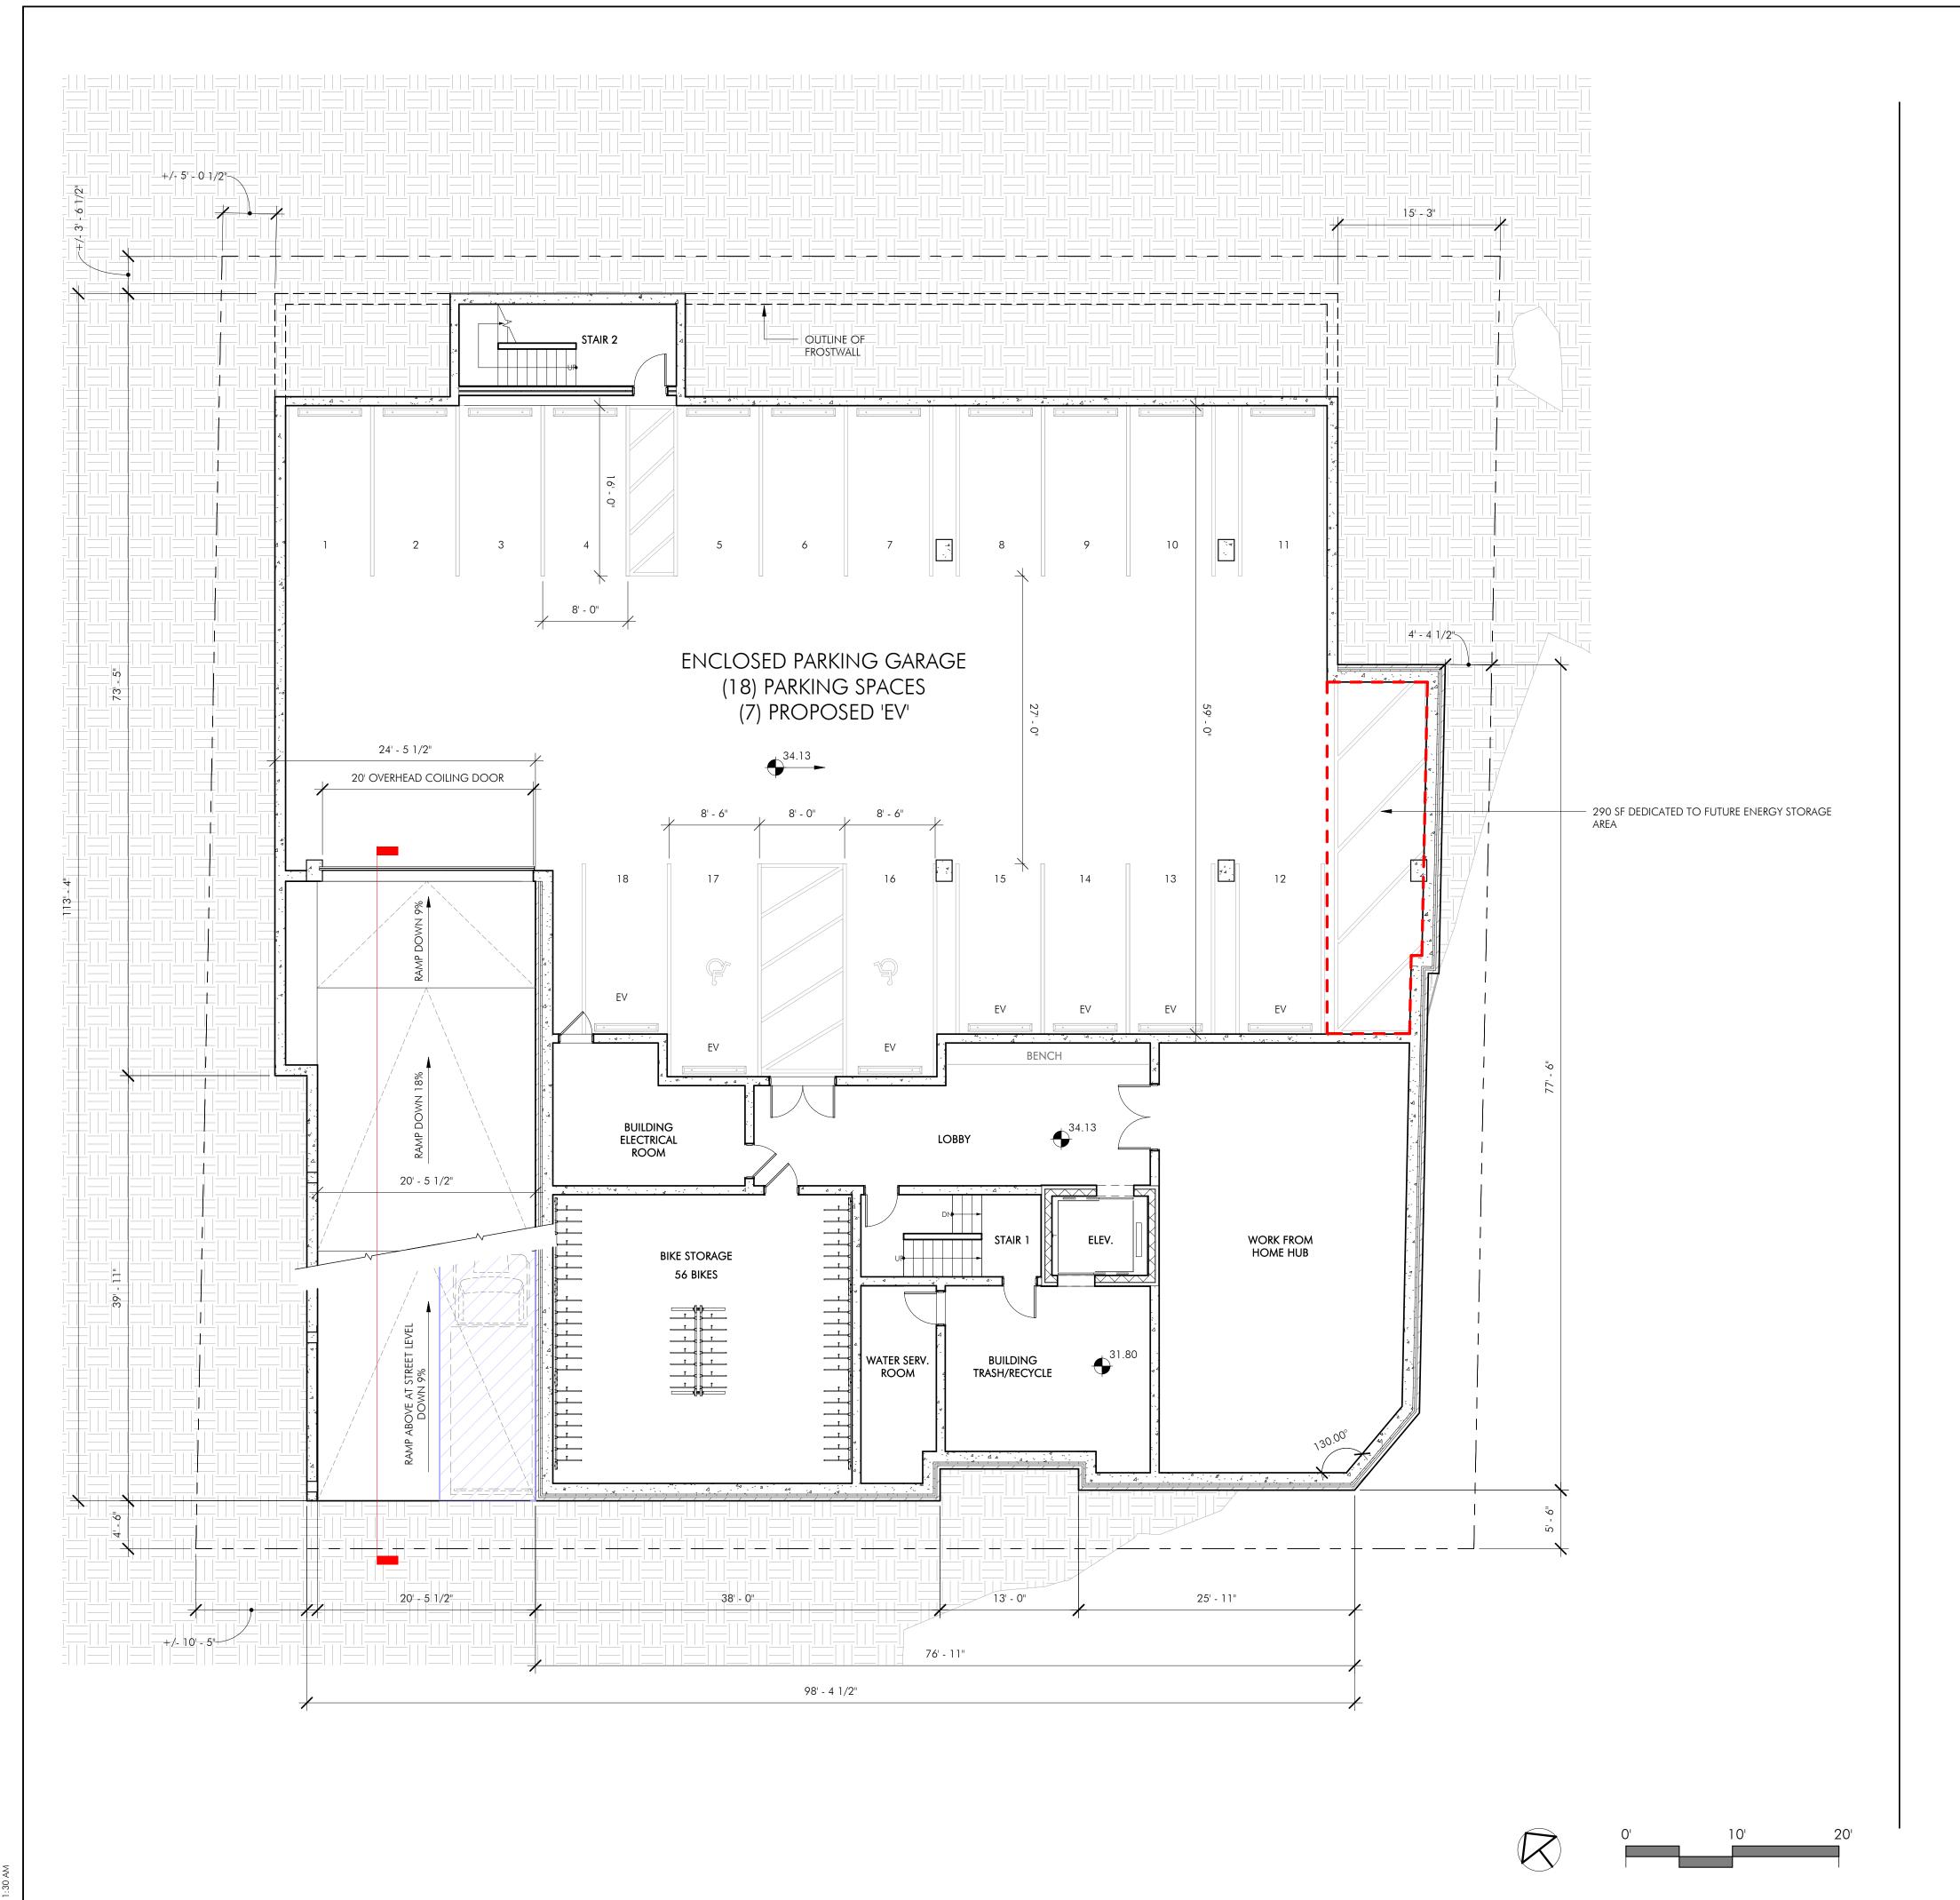
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PROJECT #: 20027 As indicated DRAWING TITLE

SITE LAYOUT & LIGHTING PLAN



AREA NAME	GROSS SQUARE FOOTAGE
BIKE STORAGE	879 SF
BUILDING ELECTRICAL ROOM	263 SF
ELEV.	86 SF
ELEVATOR LOBBY	486 SF
PARKING AREA	6,057 SF
STAIR 1	153 SF
STAIR 2	214 SF
TRASH/RECYCLE	369 SF
WATER SERVICE ROOM	162 SF
WORK FROM HOME HUB	1,056 SF

TOTAL BASEMENT LEVEL GSF

TOTAL BASEMENT LEVEL GSF W DEDUCTIONS

PARKING LEVEL GSF DEDUCTION		
AREA NAME	GROSS SQUARE FOOTAGE	
BIKE STORAGE	879 SF	
BUILDING ELECTRICAL ROOM	263 SF	
PARKING AREA	6,057 SF	
TRASH/RECYCLE	369 SF	
WATER SERVICE ROOM	162 SF	
OTAL GROSS SQUARE FOOTAGE DEDUCTED	7,730 SF	

9,724 SF

1,994 SF

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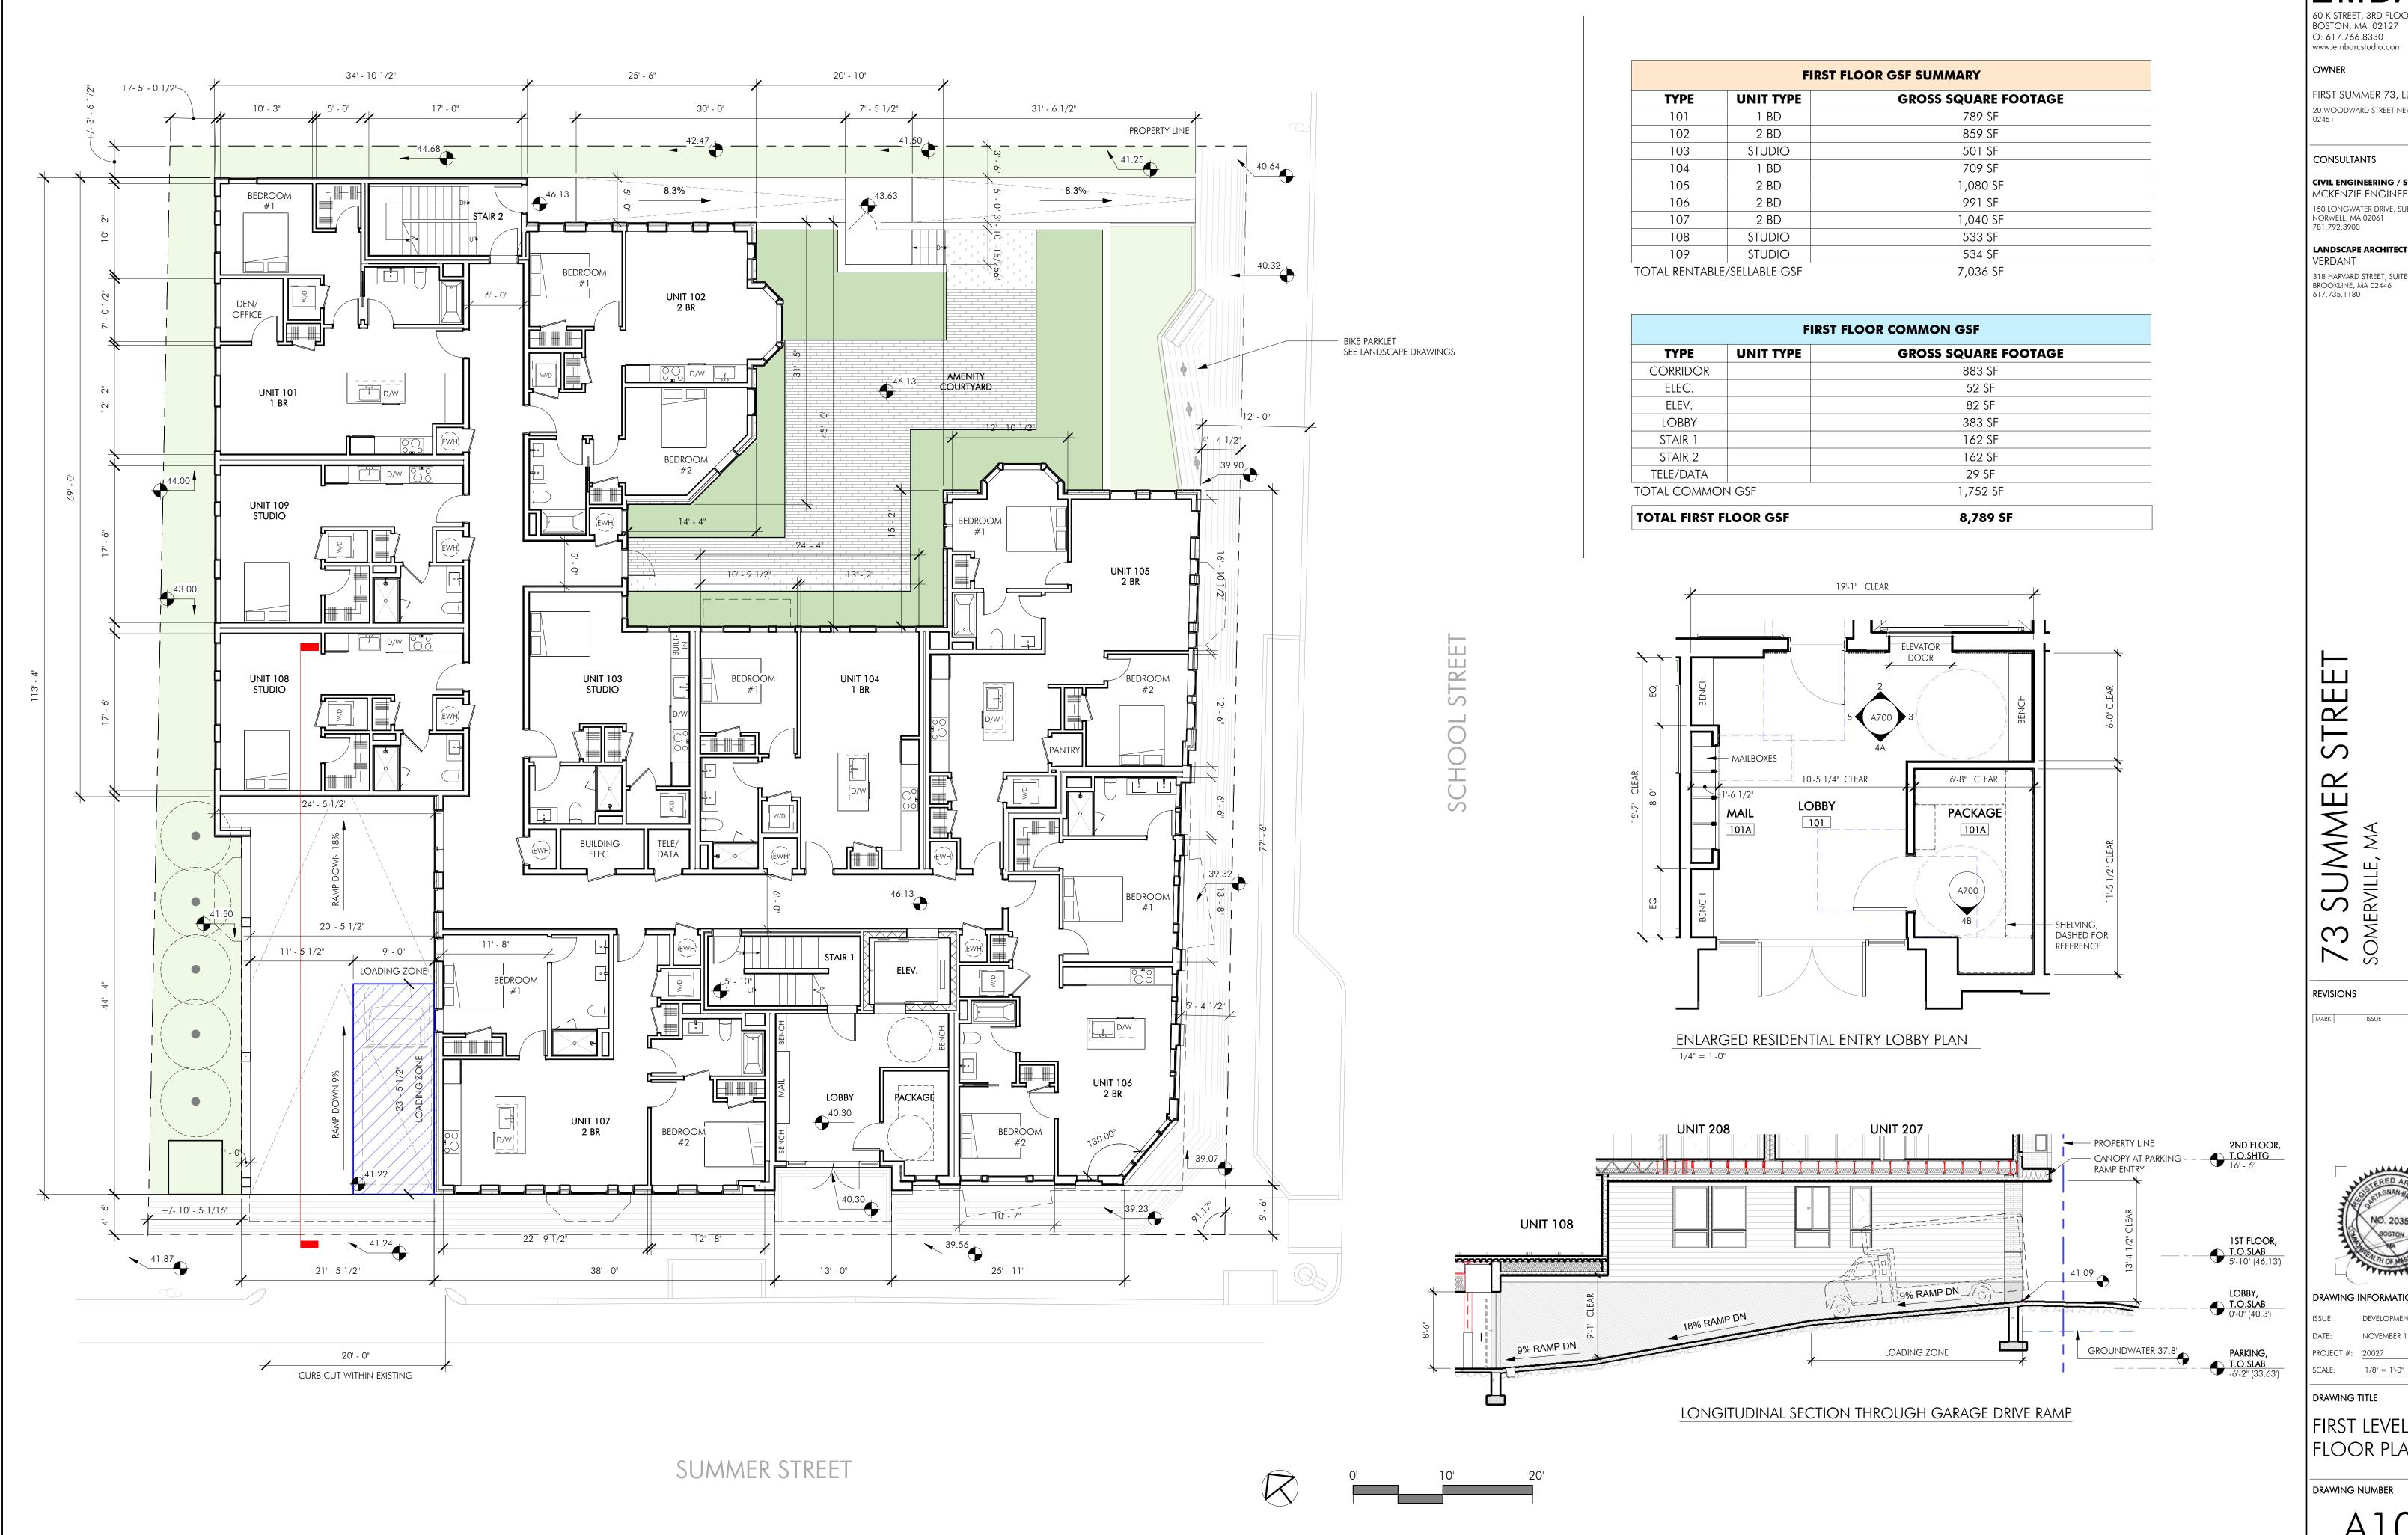


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1/8" = 1'-0"

DRAWING TITLE BASEMENT LEVEL

PLAN



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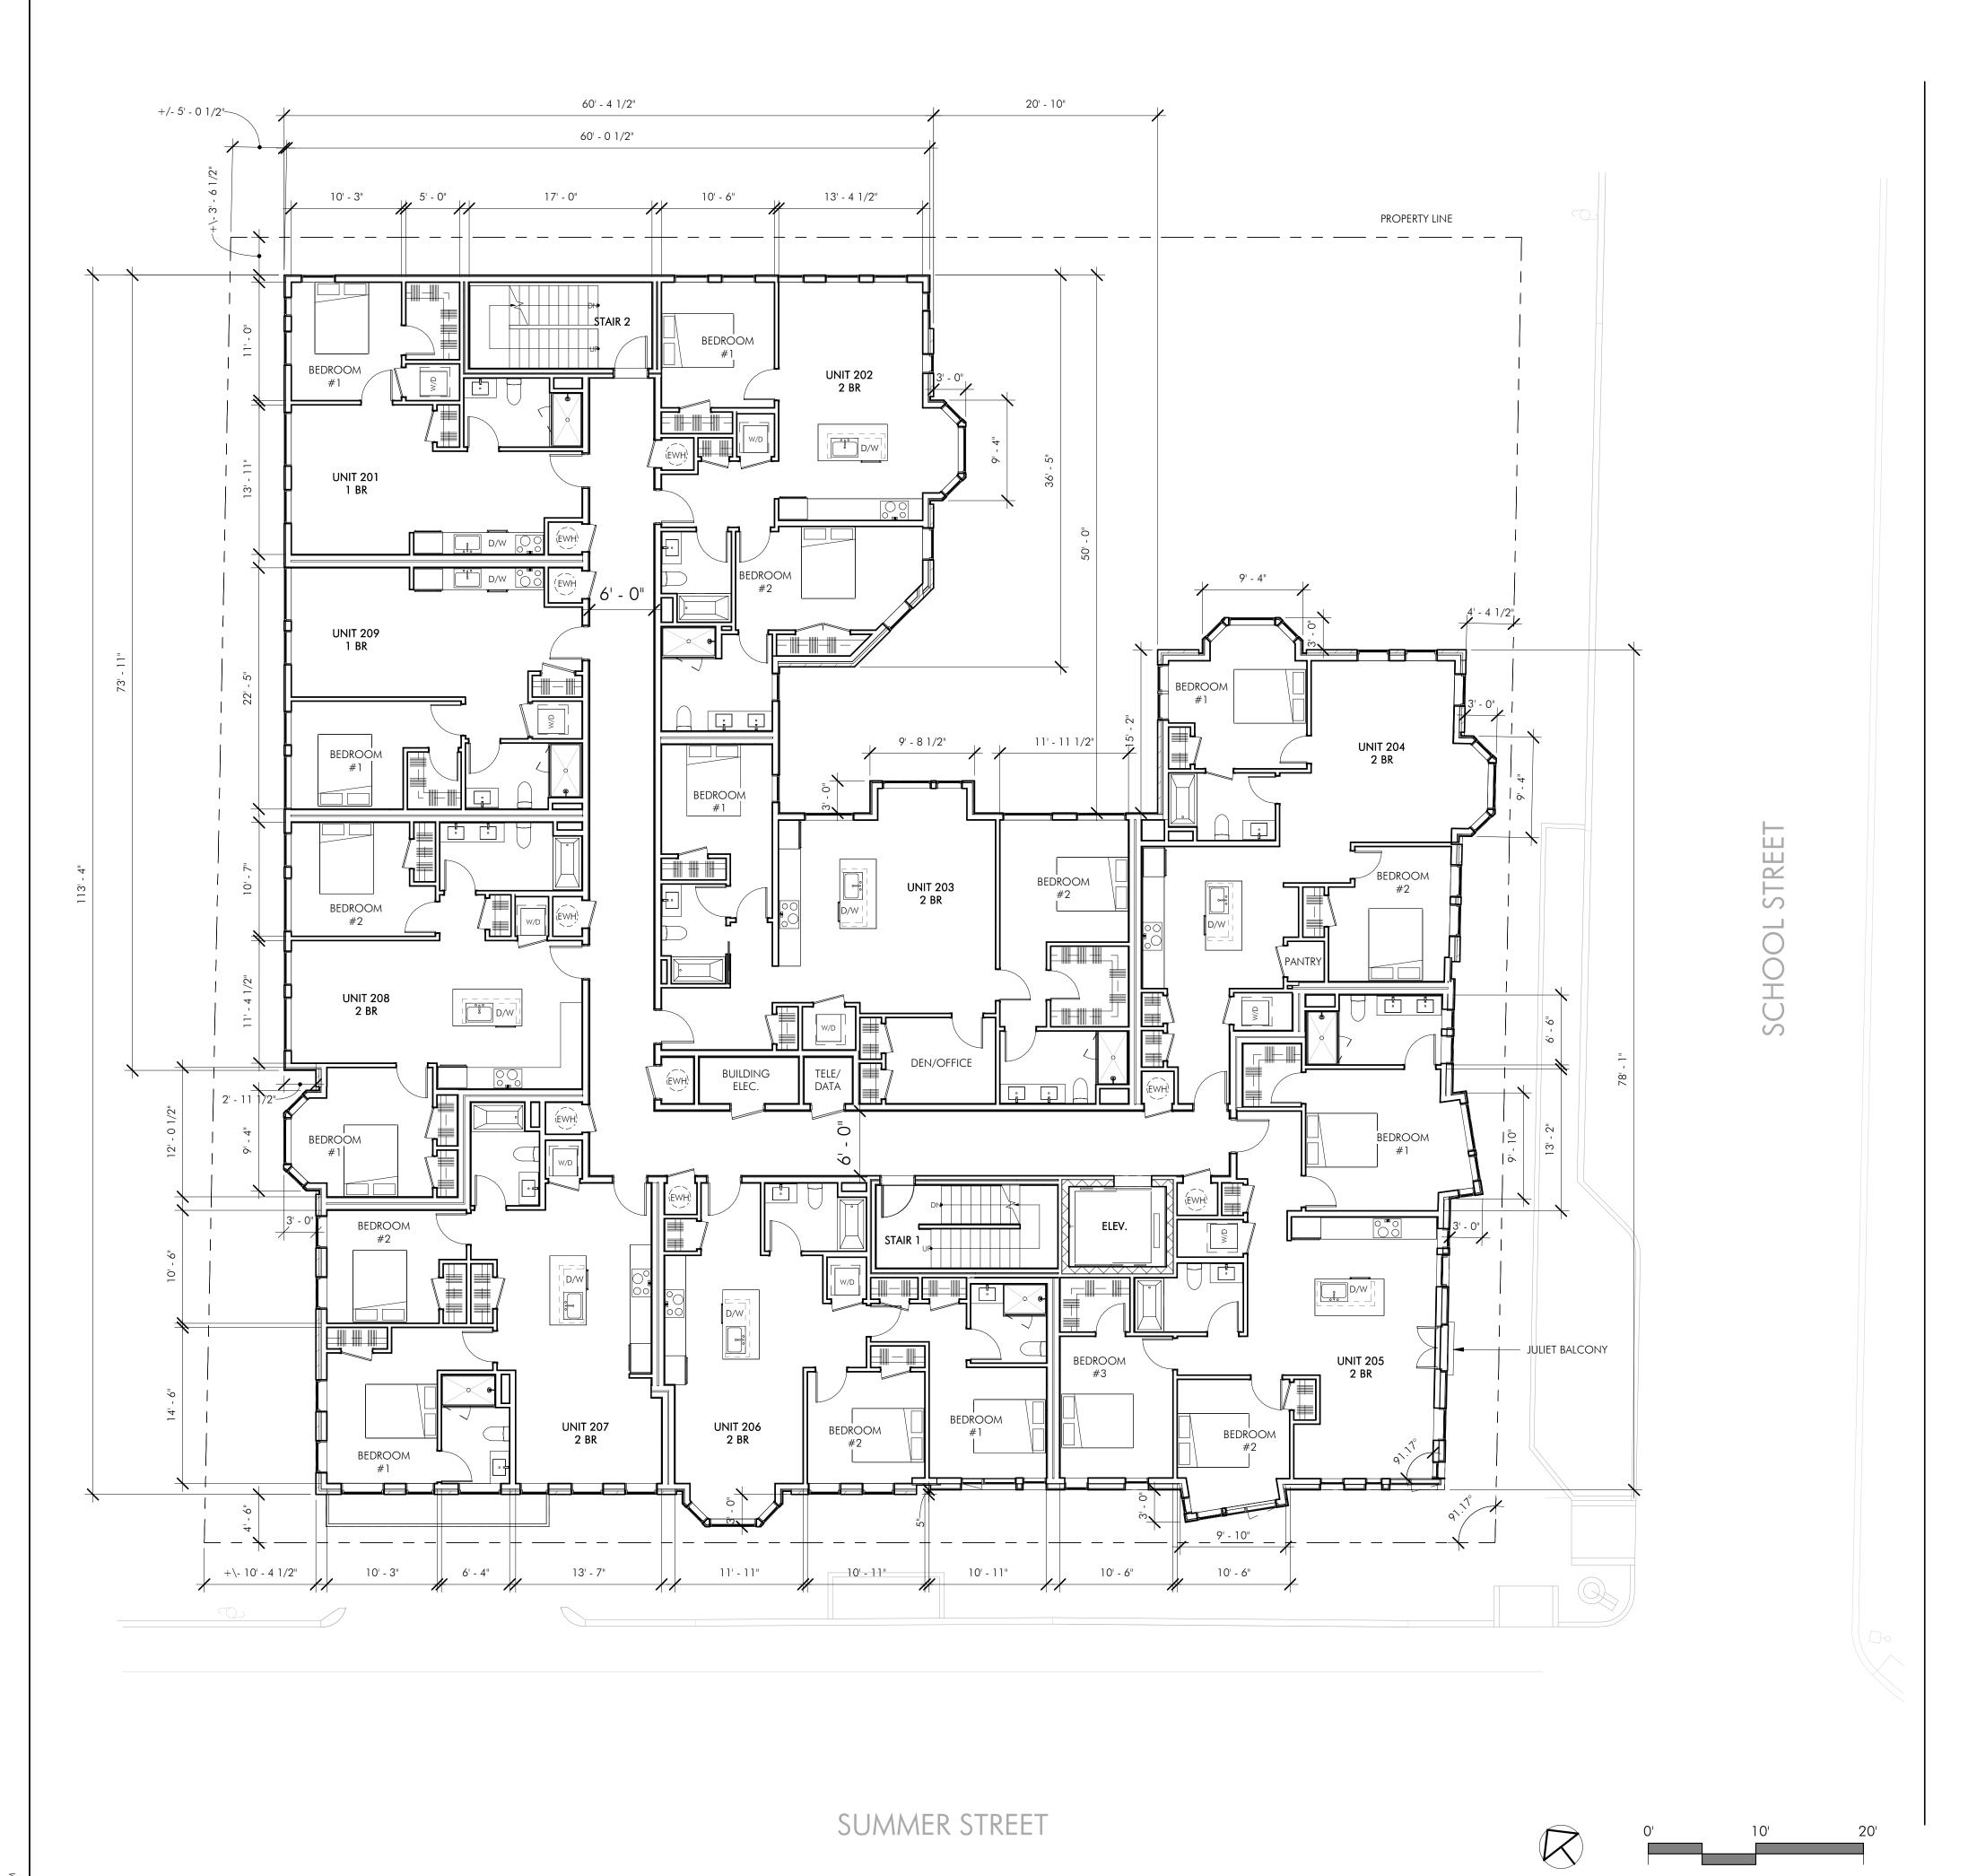


DRAWING INFORMATION

DEVELOPMENT REVIEW SUBMISSION NOVEMBER 12, 2021 1/8" = 1'-0"

DRAWING TITLE FIRST LEVEL

FLOOR PLAN



SECOND FLOOR GSF SUMMARY				
TYPE	UNIT TYPE	GROSS SQUARE FOOTAGE		
201	1 BD	650 SF		
202	2 BD	1,015 SF		
203	2 BD	1,271 SF		
204	2 BD	1,107 SF		
205	3 BD	1,343 SF		
206	2 BD	938 SF		
207	2 BD	1,010 SF		
208	2 BD	893 SF		
209	STUDIO	673 SF		
TOTAL RENTABLE/SELLABLE GSF		8,899 SF		

SECOND FLOOR COMMON GSF						
TYPE	UNIT TYPE	GROSS SQUARE FOOTAGE				
CORRIDOR		768 SF				
ELEC.		52 SF				
ELEV.		90 SF				
STAIR 1		162 SF				
STAIR 2		162 SF				
TELE		27 SF				
TOTAL COMMON GSF	·	1,262 SF				
TOTAL SECOND FLO	OR GSF	10,161 SF				

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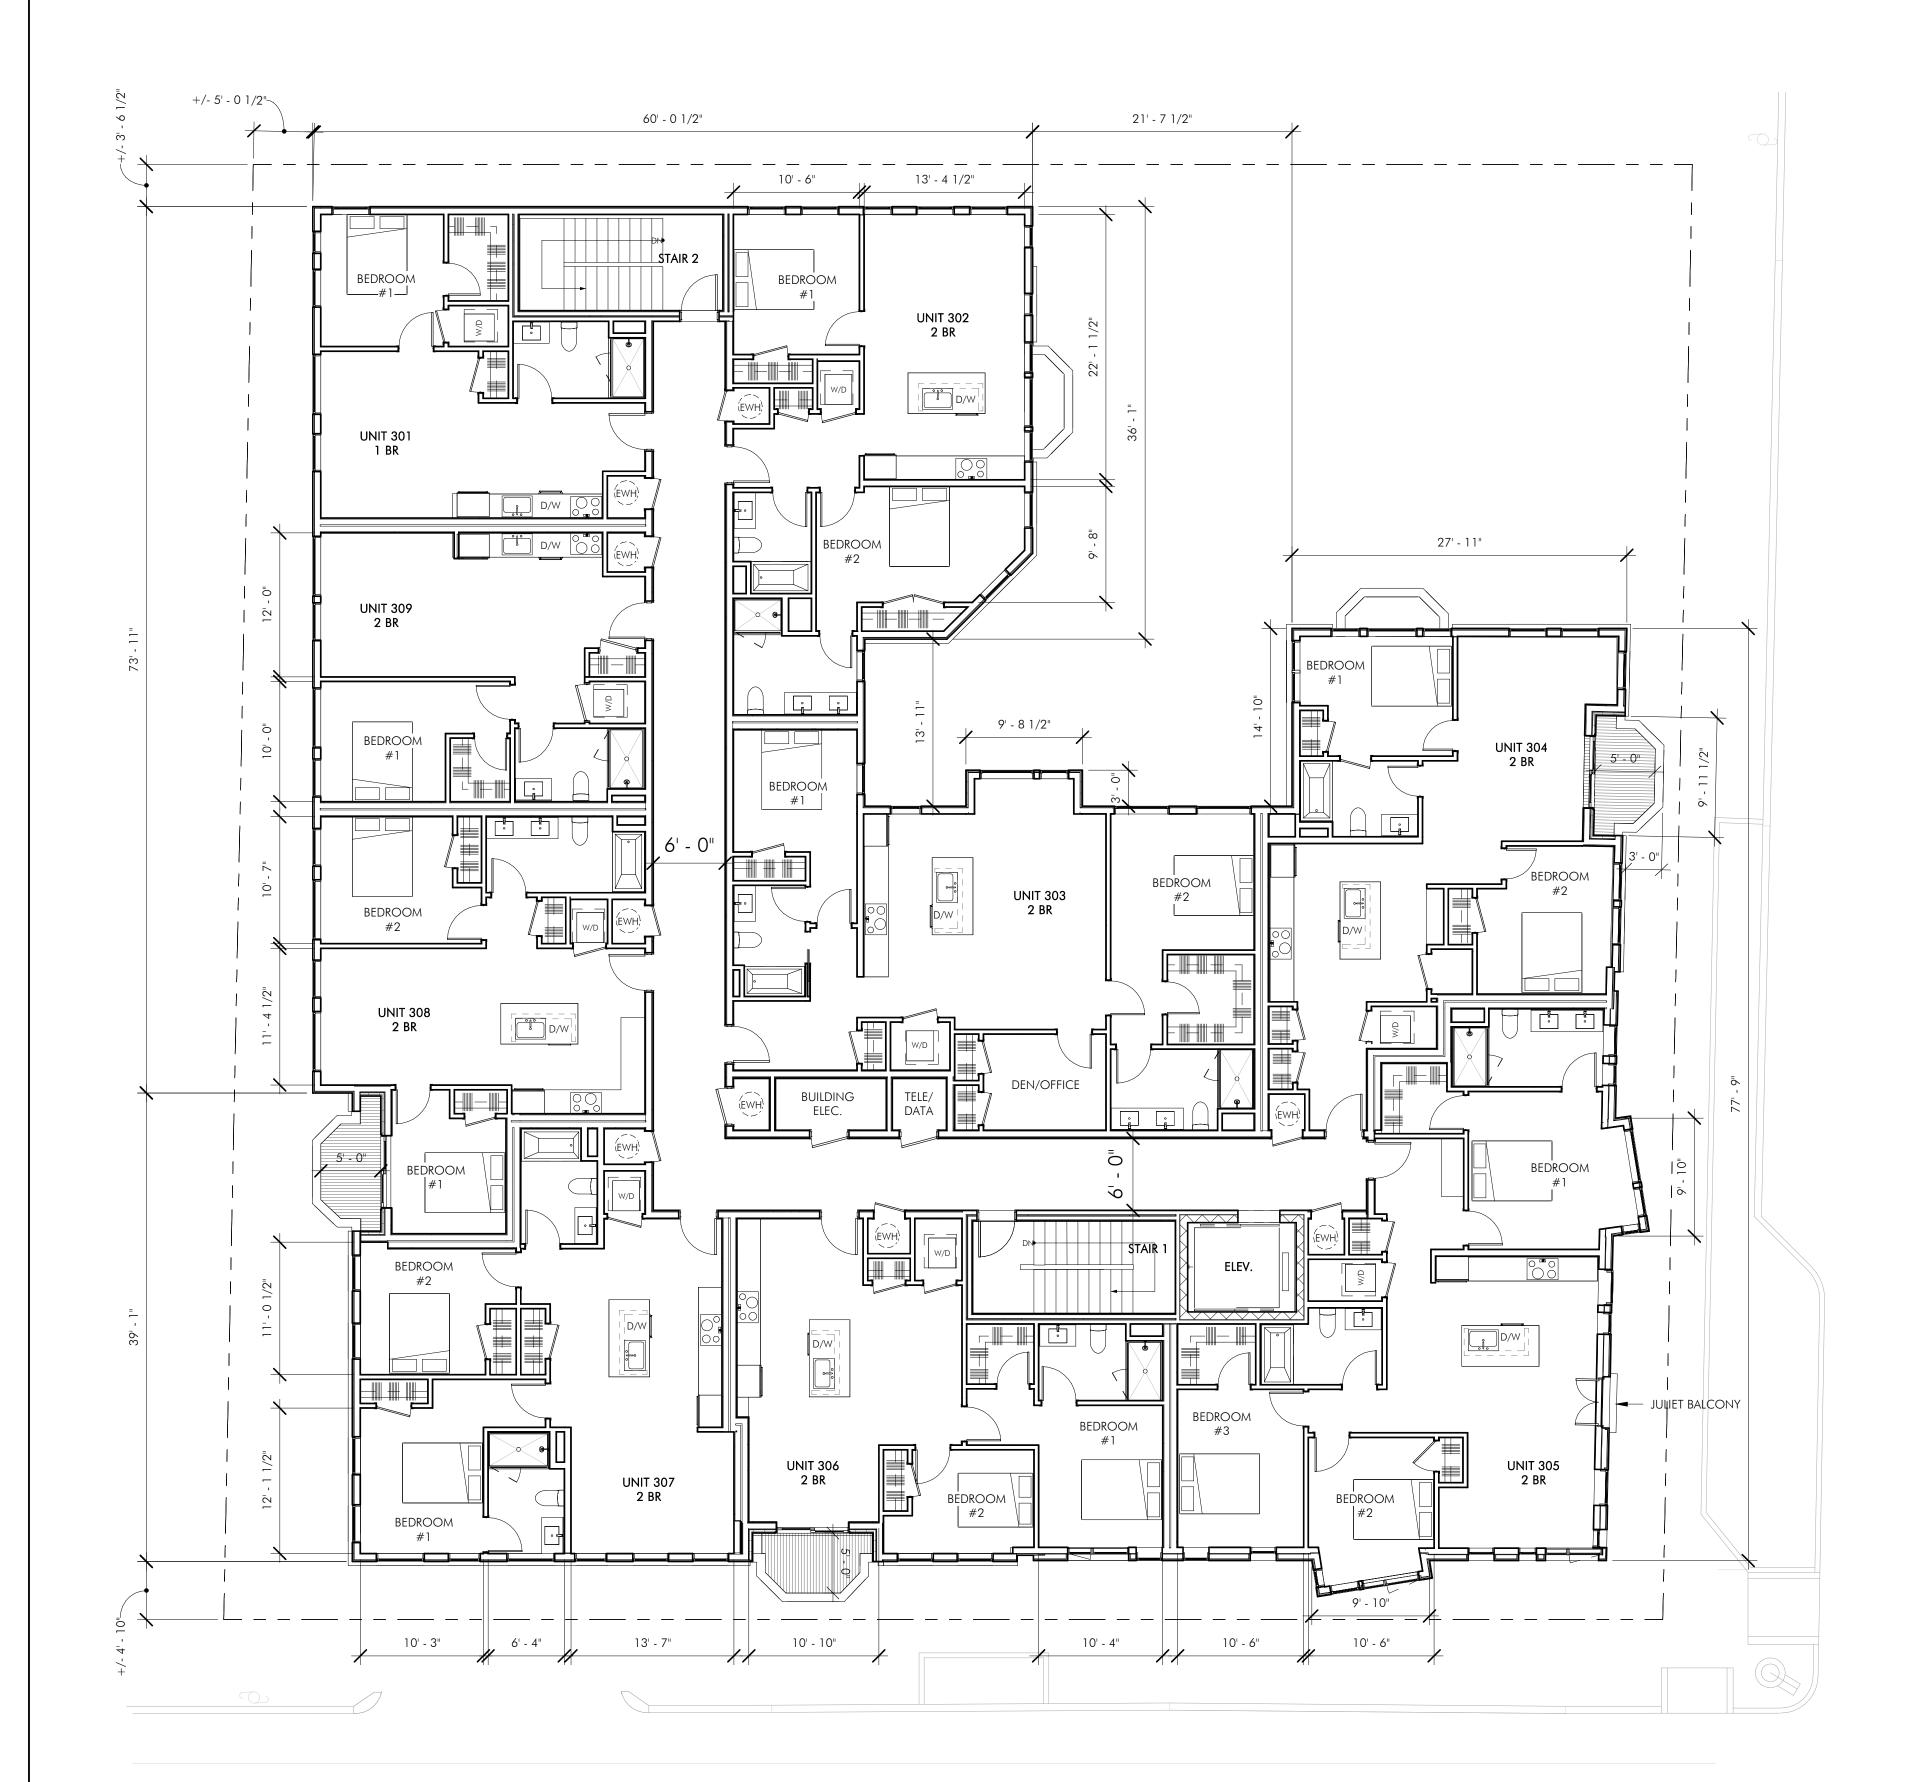
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SECOND LEVEL FLOOR PLAN




THIRD FLOOR GSF SUMMARY UNIT TYPE GROSS SQUARE FOOTAGE TYPE 301 649 SF 1 BD 302 2 BD 978 SF 1,270 SF 303 2 BD 1,009 SF 304 2 BD 305 1,342 SF 3 BD 306 2 BD 879 SF 991 SF 307 2 BD 835 SF 308 2 BD STUDIO 672 SF 309 TOTAL RENTABLE/SELLABLE GSF 8,626 SF

THIRD FLOOR COMMON GSF			
TYPE	UNIT TYPE	GROSS SQUARE FOOTAGE	
CORRIDOR		768 SF	
ELEC.		52 SF	
ELEV.		90 SF	
STAIR 1		162 SF	
STAIR 2		162 SF	
TELE/DATA		27 SF	
TOTAL COMMOI	N GSF	1,262 SF	
TOTAL THIRD	FLOOR GSF	9,889 SF	

	REN	TABLE GSF				
TYPE	UNIT TYPE	GSF				
101	1 BD	789 SF				
102	2 BD	859 SF				
103	STUDIO	501 SF				
104	1 BD	709 SF				
105	2 BD	1,080 SF				
106	2 BD	991 SF				
107	2 BD	1,040 SF				
108	STUDIO	533 SF				
109	STUDIO	534 SF				
T FLOOR:	9 UNITS	7,036 SF				
201	1 BD	650 SF				
202	2 BD	1,015 SF				
203	2 BD	1,271 SF				
204	2 BD	1,107 SF				
205	3 BD	1,343 SF				
206	2 BD	938 SF				
207	2 BD	1,010 SF				
208	2 BD	893 SF				
209	STUDIO	673 SF				
OND FLO	OR: 9 UNITS	8,899 SF				
301	1 BD	649 SF				
302	2 BD	978 SF				
303	2 BD	1,270 SF				
304	2 BD	1,009 SF				
305	3 BD	1,342 SF				
306	2 BD	879 SF				
307	2 BD	991 SF				
308	2 BD	835 SF				
309	STUDIO	672 SF				
	: 9 UNITS	8,626 SF				

LEVEL	GSF				
BASEMENT	1,994.11 SF W/ 7,730 SF DEDUCTION				
FIRST FLOOR	8,788.53 SF				
SECOND FLOOR	10,160.68 SF				
THIRD FLOOR	9,888.64 SF				
TOTAL BUILDING GSF	30,831.95 SF				

SUMMER STREET

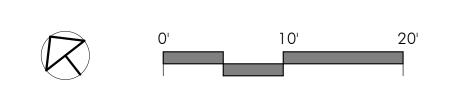

S

| ARCHITECT

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PROJECT #: 20027 1/8" = 1'-0"

DRAWING TITLE

ROOF PLAN



60 K STREET, 3RD FLOOR BOSTON, MA 02127 O: 617.766.8330 www.embarcstudio.com

OWNER

FIRST SUMMER 73, LLC 20 WOODWARD STREET NEWTON, MA

CONSULTANTS

CIVIL ENGINEERING / SURVEY

MCKENZIE ENGINEERING GROUP 150 LONGWATER DRIVE, SUITE 101 NORWELL, MA 02061 781.792.3900

LANDSCAPE ARCHITECT

VERDANT

318 HARVARD STREET, SUITE 25

BROOKLINE, MA 02446 617.735.1180

SUBMISSIO REVIEW

DEVEL

STRE 73 SUMMER SOMERVILLE, MA

REVISIONS

MARK ISSUE DATE

DRAWING INFORMATION

ISSUE: <u>DEVELOPMENT REVIEW SUBMISSION</u>

DATE: NOVEMBER 12, 2021 PROJECT #: 20027

SCALE: As indicated DRAWING TITLE

BUILDING ELEVATIONS



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ISSUE: <u>DEVELOPMENT REVIEW SUBMISSION</u> NOVEMBER 12, 2021

SCALE: As indicated DRAWING TITLE

BUILDING ELEVATIONS

PARTIAL ELEVATION - COURTYARD EAST

1/8" = 1'-0"

PARTIAL ELEVATION - COURTYARD WEST

PARTIAL ELEVATION - COURTYARD NORTH

1/8" = 1'-0"

KEY PLAN

SUMMER ST

| ARCHITECT 60 K STREET, 3RD FLOOR BOSTON, MA 02127 O: 617.766.8330

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DRAWING INFORMATION

ISSUE: <u>DEVELOPMENT REVIEW SUBMISSION</u>

NOVEMBER 12, 2021 PROJECT #: 20027 SCALE: As indicated

DRAWING TITLE

PARTIAL BUILDING ELEVATIONS DRAWING NUMBER

A. A SIGN, INDIVIDUAL NUMERALS OR LETTERS, OR A NONELECTRICAL NAMEPLATE IDENTIFYING THE PROPERTY ADDRESS IS REQUIRED FOR ALL REAL PROPERTY AS FOLLOWS:


I. EACH GROUND STORY NON-RESIDENTIAL USE MUST IDENTIFY THE STREET ADDRESS EITHER ON THE PRINCIPAL ENTRANCE DOOR OR ABOVE OR BESIDE THE PRINCIPAL ENTRANCE OF THE USE.

II. ALL RESIDENTIAL BUILDING TYPES MUST IDENTIFY THE STREET ADDRESS EITHER ON THE PRINCIPAL ENTRANCE DOOR, ABOVE OR BESIDE THE PRINCIPAL ENTRANCE, OR ON A MAILBOX.


B. ADDRESS SIGNS MUST BE MADE EASILY VISIBLE THROUGH THE USE OF COLORS OR MATERIALS THAT CONRAST WITH THE BACKGROUND MATERIAL THEY ARE ATTACHED TO AND MUST BE CONSPICUOUSLY LOCATED TO PROVIDE VISIBILITY FROM THE THROROUGHFARE THAT THE BUILDING FACES

C. ADDRESS SIGNS MUST BE 12 INCHES IN HEIGHT OR LESS AND MAY INCLUDE THE NAME OF THE OCCUPANT.



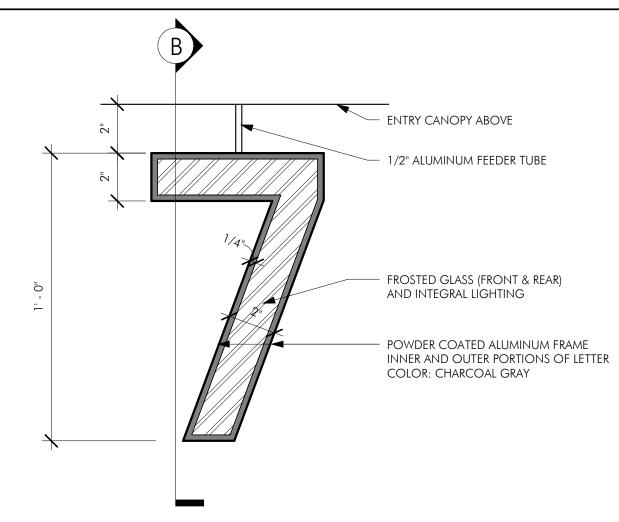

(A) ELEVATION @ INDIVIDUAL BACK-LIT/ FRONT-LIT STAND-OFF LETTERING

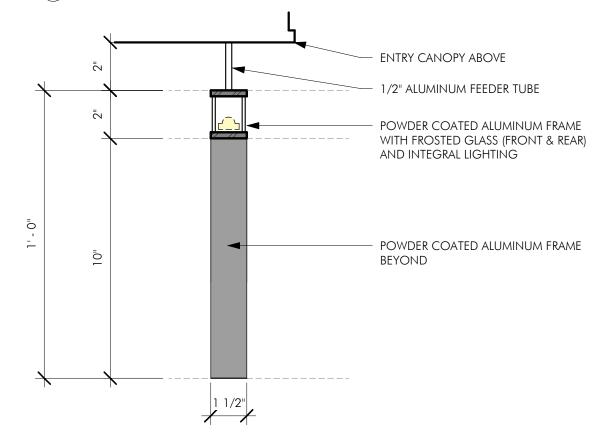

(B) SECTION @ INDIVIDUAL BACK-LIT/ FRONT-LIT STAND-OFF LETTERING

ENLARGE PARTIAL ELEVATION - SUMMER STREET ENTRY SIGNAGE

1" = 1'-0"



PARTIAL ELEVATION - SUMMER STREET ENTRY

1/2" = 1'-0"

| ARCHITECT

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DRAWING TITLE SIGNAGE

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VERDANT

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PERSPECTIVES

VIEW OF BUILDING FROM CORNER OF SCHOOL AND SUMMER STREET



VIEW OF COURTYARD FROM SCHOOL STREET



KEY PLAN

SUMMER ST

| ARCHITECT

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DRAWING TITLE BUILDING PERSPECTIVES



SUMMER STREET PERSPECTIVE



2 SCHOOL STREET PERSPECTIVE

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DRAWING TITLE

BUILDING PERSPECTIVES







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DRAWING TITLE ALTERNATE

COLOR
EXPLORATIONS
DRAWING NUMBER









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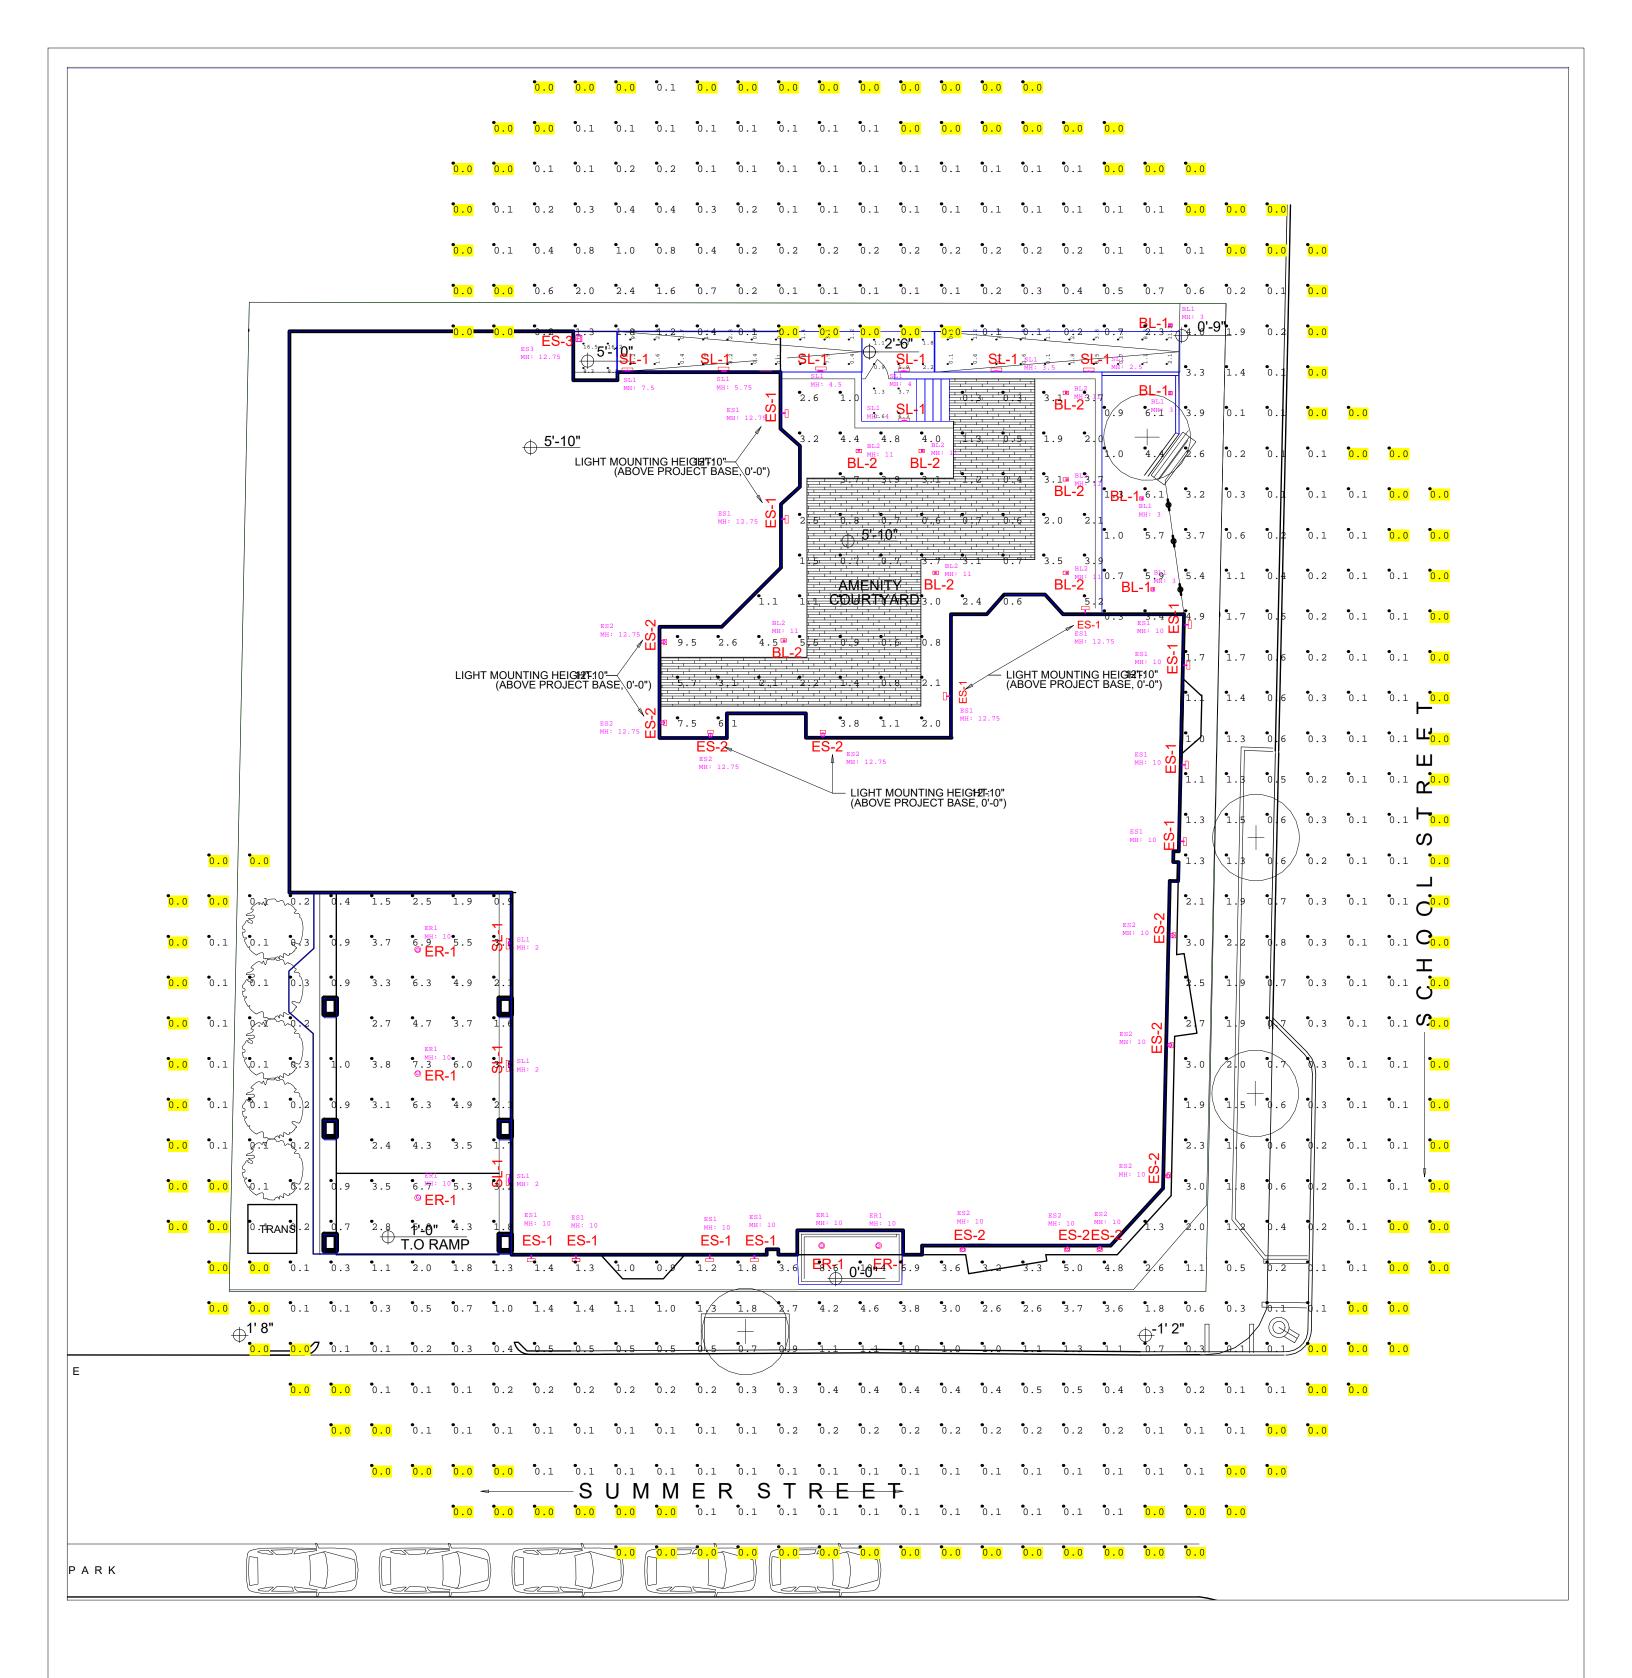
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DRAWING TITLE ALTERNATE

DRAWING NUMBER

DESIGN OPTIONS



Luminaire S	Schedule				
Symbol	Label	Description	Lum. Lumens	Lum. Watts	LLF
-	BL1	LUMIERE: 303-B1-LEDB1-3000-UNV-T2-DIM10-BK-36	581	8.3	0.900
+	BL2	WAC: PM-W15925-BK ON 4' POLE	404	15.8954	0.900
\odot	ER1	ALPHABET: NU4-RD-XTM19-13LM-30K-83-HE60-UNV-DIM10-(HOUSING)-(FINISH)	1140	14.08	0.900
+	ES1	WAC: WS-W15912-BK	338	10.6133	0.900
\odot	ES2	WAC: WS-W65607-BK	849	17	0.900
+	ES3	WAC: WP-LED219-30-(FINISH)	1344	19.1	0.900
-	SL1	VISTA PRO: 1501-SW-SS-B-30-MV-010-CP	184	5.75	0.900

Calculation Summary				
Label	Units	Avg	Max	Min
AMENITY COURTYARD_FLOOR	Fc	2.45	9.5	0.3
RAMP 1_FLOOR	Fc	2.90	11.3	0.1
RAMP 2_FLOOR	Fc	2.69	9.2	0.1
RAMP LANDING AT STAIRS_FLOOR	Fc	2.71	6.3	0.6
RAMP LANDING- TOP_FLOOR	Fc	12.38	16.5	8.3
SITE (ALL POINTS)_Planar	Fc	0.81	10.4	0.0



	Drawn By: A.M.		#	Date	Comments	1
73 SUMMER ST- SOMERVILLE	Checked By:		Х	XX/XX	xxxxxxxxx]
	Date: 5/26/2021	Jus				
	Specifier:	Visic				
SITE LIGHTING		_ &				
	Scale: NTS					